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# allcove

## BEACH CITIES HEALTH DISTRICT



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ZC SUSTAINABILITY  
859 25TH STREET  
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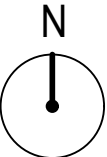
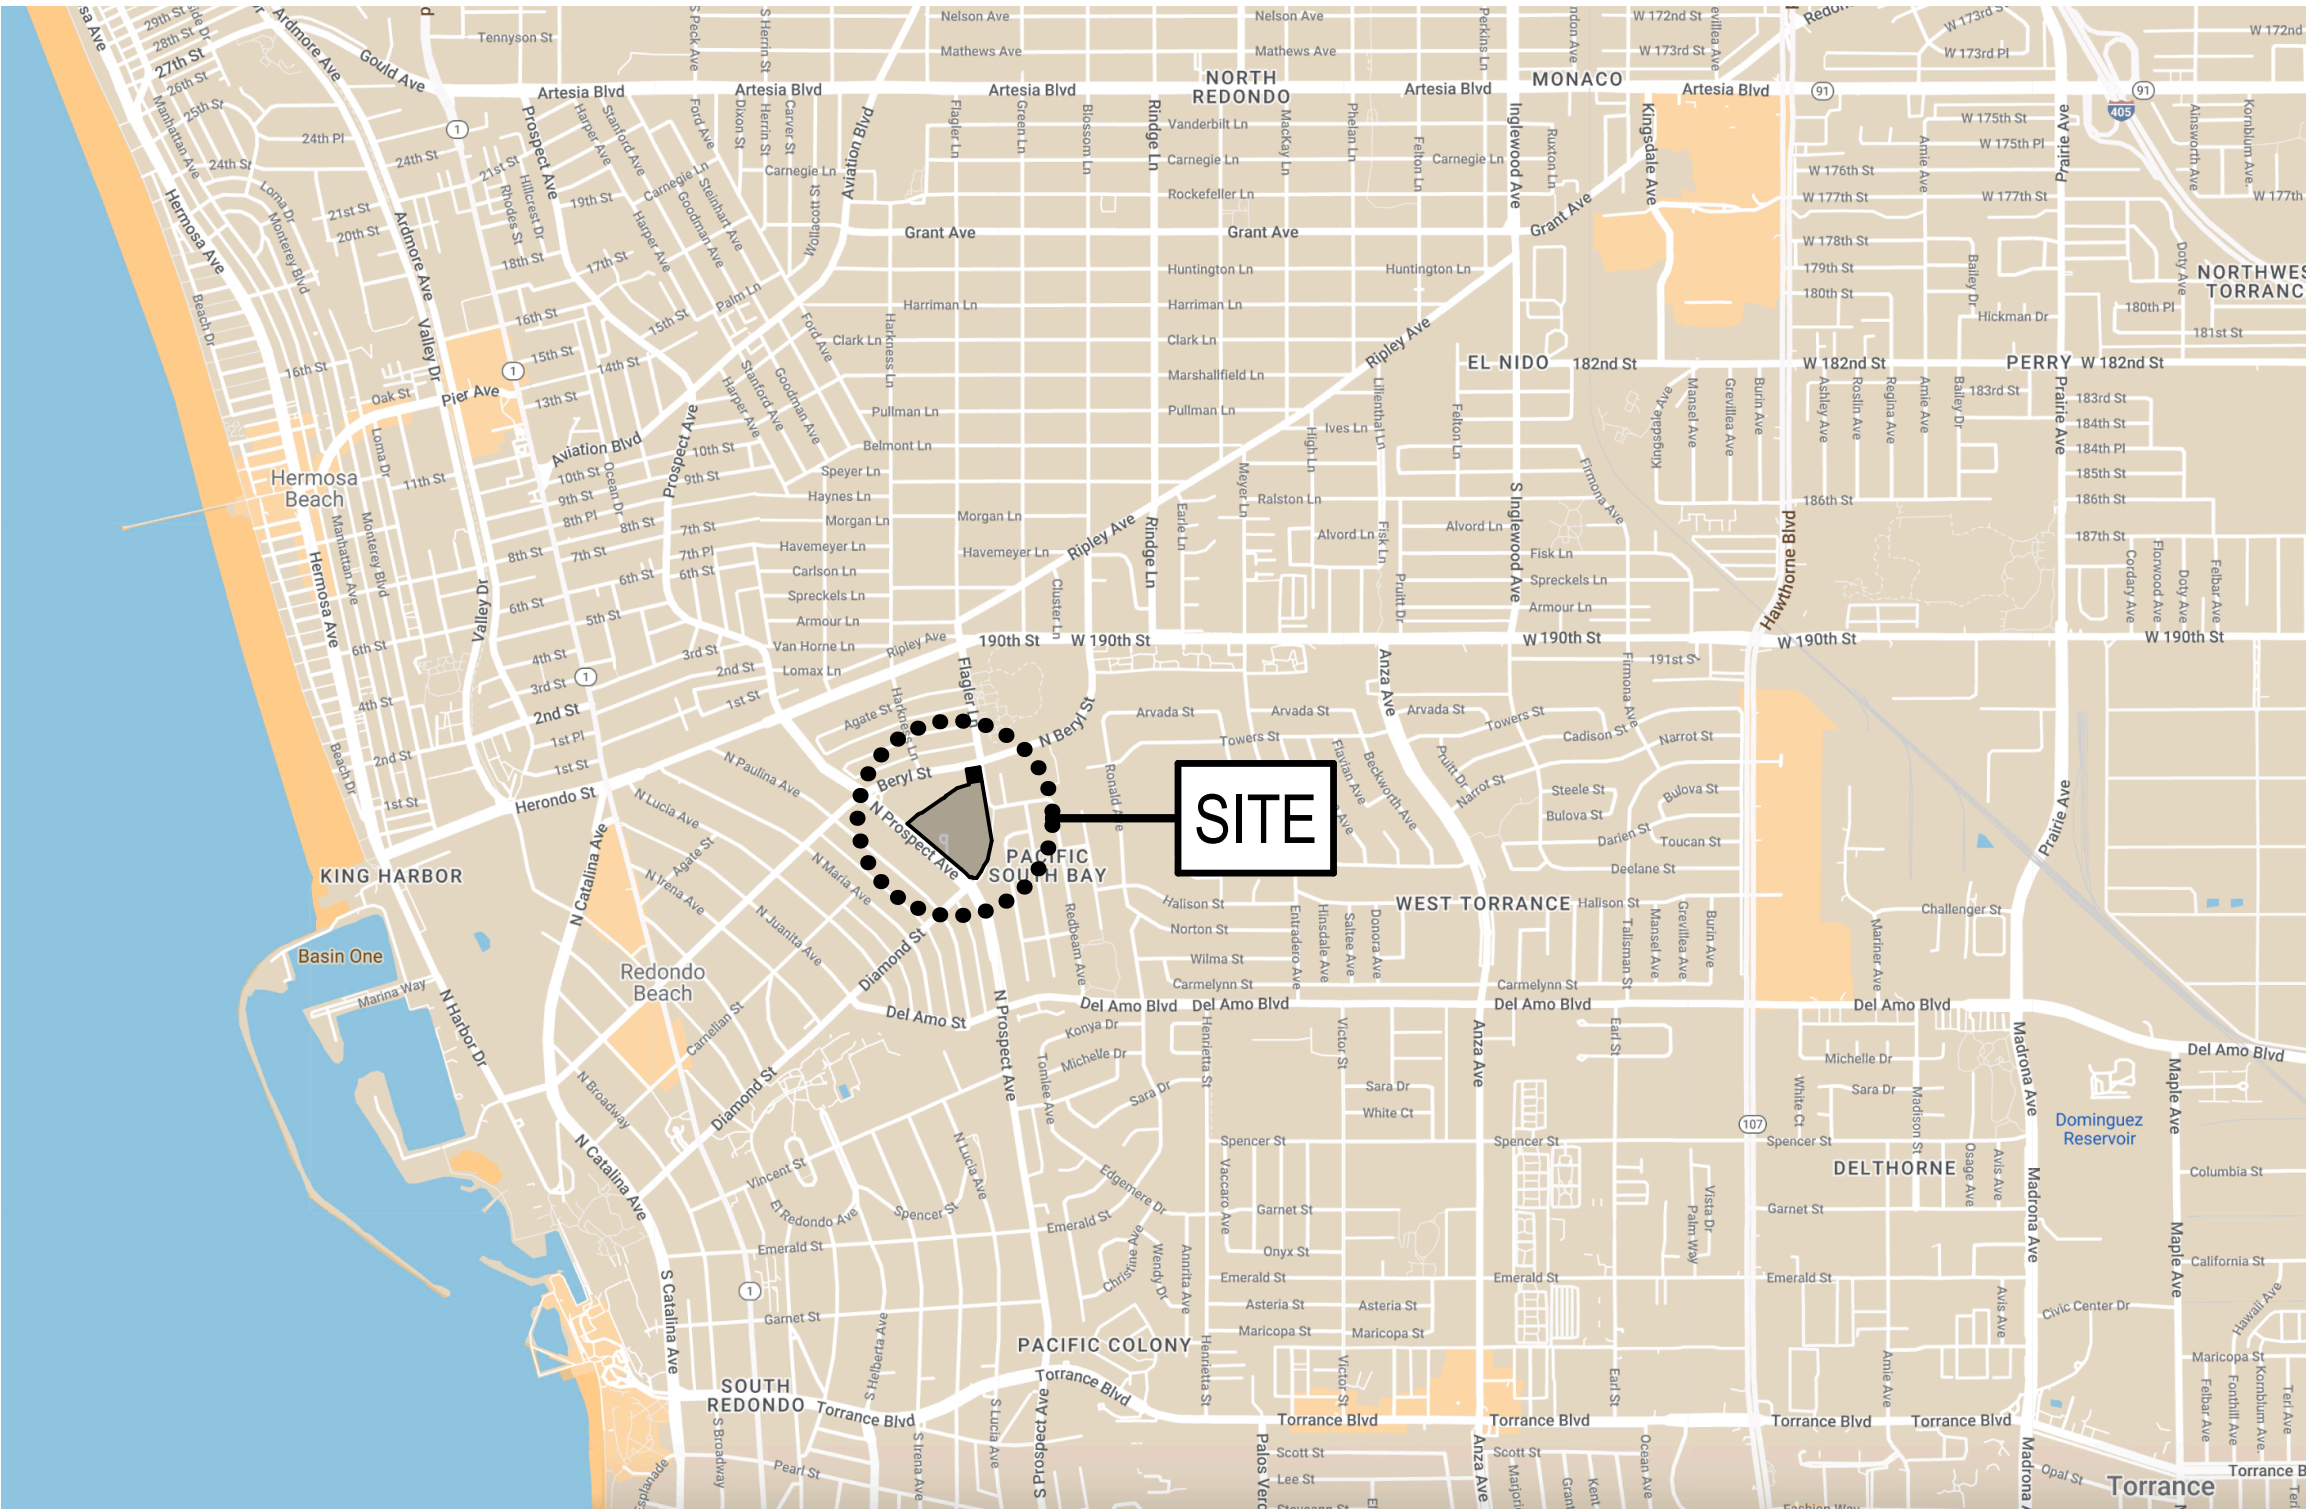
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### OWNER

BEACH CITIES HEALTH DISTRICT  
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### OWNER REPRESENTATIVE

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2555 TOWNSGATE ROAD, SUITE 312  
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NO. DATE REVISION

**allcove**  
BEACH CITIES  
HEALTH DISTRICT

**100% PRELIMINARY  
DESIGN SUBMITTAL**

PMA PROJECT NO.  
23007

DRAWING TITLE  
**COVER SHEET**

SCALE  
N.T.S.

DATE  
02/28/2024

DRAWN  
E.C.

CHECKED  
P.M.

SHEET NO.  
G001



ABBREVIATIONS

ABV.	ABOVE	L.	LENGTH
A/C.	AIR CONDITIONING	L.B.	LAG BOLT
ACC.	ACCESS	LAB.	LABORATORY
ACOUS.	ACOUSTICAL	LAM.	LAMINATE
A.T.	ACOUSTICAL TILE	LAV.	LAVATORY
ADJ.	ADJUSTABLE	LT.	LIGHT
A.F.F.	ABOVE FINISH FLOOR	LKR.	LOCKER
AGR.	AGGREGATE	LOC.	LOCATED, LOCATION
ALUM., AL.	ALUMINUM	LVR.	LOUVER
ALT.	ALTERNATE	LVT.	LUXURY VINYL TILE
ANG. I.	ANGLE	M.H.	MANHOLE
APPROX.	APPROXIMATE	MFR.	MANUFACTURER
A.P.	ACCESS PANEL	M.O.	MASONRY OPENING
ARCH.	ARCHITECTURAL	MAT.	MATERIAL
A.D.	AREA DRAIN	MAX.	MAXIMUM
ASB.	ASBESTOS	MECH.	MECHANICAL
ASPH.	ASPHALT	M.B.	MECHANICAL BOLT
@	AT	M.E.P.	MECHANICAL, ELECTRICAL + PLUMBING
AHU.	AIR HANDLING UNIT	M.E.P.T.	MECHANICAL, ELECTRICAL + PLUMBING + TELE.
		M.C.	MEDICINE CABINET
BM.	BEAM	MED.	MEDIUM
BET.	BETWEEN	MEMB.	MEMBRANE
BITUM.	BITUMINOUS	MEZZ.	MEZZANINE
BLK.	BLOCK	MTL.	METAL
BLKG.	BLOCKING	MIN.	MINIMUM
BD.	BOARD	MIR.	MIRROR
BOL.	BOLLARD	MISC.	MISCELLANEOUS
BTM.	BOTTOM	MTD.	MOUNTED
BLDG.	BUILDING	MUL.	MULLION
BIOHAZ.	BIOHAZARD		
BSMT.	BASEMENT	NOM.	NOMINAL
		N.	NORTH
CAB.	CABINET	N.I.C.	NOT IN CONTRACT
C.I.	CAST IRON	NOT TO SCALE	
C.I.P.	CAST IN PLACE	NO.	NUMBER
C.B.	CATCH BASIN	N.S.	NURSE STATION
CLKG.	CAULKING	N.S.T.	NON STRESS TEST
CLG.	CEILING		
CEM.	CEMENT	O/	OVER
CT.	CENTER	OBS.	OBSERVATION
CER.	CERAMIC	OFF.	OFFICE
CH.	CHANNEL	O.C.	ON CENTER
C.T.	CERAMIC TILE	OPNG.	OPENING
CL.	CENTERLINE	OPP.	OPPOSITE
CLR.	CLEAR	O.D.	OUTSIDE DIAMETER
CLO.	CLOSET	O.A.	OVERALL
COL.	COLUMN	O.F.C.I.	OWNER FURNISHED CONTRACTOR INSTALLED
CONC.	CONCRETE	O.F.O.I.	OWNER FURNISHED OWNER INSTALLED
CONN.	CONNECTION	O.R.	OUTSIDE RADIUS
CONSTR.	CONSTRUCTION		
CONT.	CONTINUOUS	PR.	PAIR
CORR.	CORRIDOR	PERF.	PERFORATED
CNTR.	COUNTER	PIV.	PIVOT
CTSK.	COUNTERSUNK	PNL.	PANEL
C.U.	CLEAN UTILITY	PNL.	PANEL
C.W.	CURTAIN WALL	PPB.	PREFABRICATE
		P.T.D.	PAPER TOWEL DISPENSER
DBL.	DOUBLE	P.T.R.	PAPER TOWEL RECEPTACLE
DEPT.	DEPARTMENT	PTD.	PAINTED
DET.	DETAIL	PTN.	PARTITION
D.F.	DOUGLAS FIR	PA.	PLANTED AREA
DIA.	DIAMETER	PLAS.	PLASTER
DIAG.	DIAGONAL	PLAM.	PLASTIC LAMINATE
DIM.	DIMENSION	PL.PLT.	PLATE
DISP.	DISPENSER	PLWD.	PLYWOOD
D.O.	DOOR OPENING	PT.	POINT
DN.	DOWN	PRCST.	PRECAST
DS.	DOWNSPOUT	PTS.	PNEUMATIC TUBE STATION
DWR.	DRAWER	P.S.I.	POUNDS/SQUARE INCH
DWG.	DRAWING	PVC.	POLYVINYLCHLORIDE
D.F.	DRINKING FOUNTAIN		
D.S.P.	DRY STANDPIPE	Q.T.	QUARRY TILE
EA.	EACH	RAD.	RADIUS
E.	EAST	R.W.L.	RAIN WATER LEADER
E.D.F.	ELECTRIC DRINKING FOUNTAIN	R.A.F.	RAISED ACCESS FLOOR
E.W.F.	ELECTRIC WATER COOLER	RDWD.	REDWOOD
ELEC.	ELECTRICAL	REF.	REFERENCE
E.P.	ELECTRICAL PANEL BOARD	REFL.	REFLECTED
EL.	ELEVATION	REFR.	REFRIGERATOR
ELEV.	ELEVATOR	RET.	RETAINING
EMER.	EMERGENCY	RGST.	REGISTER
ENCL.	ENCLOSURE	REINF.	REINFORCED
EQ.	EQUIPMENT	REQD.	REQUIRED, REQUIREMENTS
EQPT.	EQUIPMENT	RES.	RESILIENT
(E)	EXISTING	REV.	REVISION
EOS.	EDGE OF SLAB	R.	RISER
EXP.	EXPANSION	R.D.	ROOF DRAIN
E.J.	EXPANSION JOINT	RM.	ROOM
EXH.	EXHAUST	R.O.	ROUGH OPENING
EXPO.	EXPOSED		
EXT.	EXTERIOR	SCHED.	SCHEDULE
E.W.	EACH WAY	SECT.	SECTION
EXTR.	EXTRUSION	S.SK.	SERVICE SINK
		SHT.	SHEET
F.O.C.	FACE OF CONCRETE	SH.	SHELF
F.O.F.	FACE OF FINISH	SHRW.	SHOWER
F.O.G.	FACE OF GYP. BD.	SIM.	SIMILAR
F.O.S.	FACE OF STUD	S.D.	SOAP DISPENSER
FIN.	FINISH	S.C.	SOLID CORE
F.F.L.	FINISH FLOOR LINE	S.	SOUTH
FT.	FEET, FOOT	SPEC.	SPECIFICATION
FA.	FIRE ALARM	SQ.	SQUARE
F.E.C.	FIRE EXTINGUISHER	S.S.	STAINLESS STEEL
F.H.C.	FIRE EXTINGUISHER CABINET	STD.	STANDARD
F.H.C.	FIRE HOSE CABINET	STA.	STATION
FPRF.	FIRE PROOF	STL.	STEEL
FLASH.	FLASHING	STO.	STORAGE
F.B.	FLAT BAR	STRUCT.	STRUCTURAL
FLEX.	FLEXIBLE	SUSP.	SUSPENDED
FL.	FLOOR	SYM.	SYMMETRICAL
F.D.	FLOOR DRAIN	SUPV.	SUPERVISOR
FLUOR.	FLUORESCENT	S.U.	SOILED UTILITY
FTG.	FOOTING		
FDN.	FOUNDATION	TEL.	TELEPHONE
F.S.	FULL SIZE	T.V.	TELEVISION
FURR.	FURRING	TEMP.	TEMPERED
FUT.	FUTURE	TER.	TERRAZZO
		THK.	THICK
GALV.	GALVANIZED	T.P.D.	TOILET PAPER DISPENSER
GA.	GAUGE	T.+ G.	TONGUE + GROOVE
GL.	GLASS	TO.	TOP OF
G.B.	GRAB BAR	T.O.C.	TOP OF CURB/ TOP OF CONC.
G.F.R.G.	GLASS FIBER REINFORCED GYPSUM	T.O.P.	TOP OF PAVEMENT/ TOP OF PARAPET
GR.	GRADE	T.O.S.	TOP OF STEEL/ TOP OF SLAB
GND.	GROUND	T.O.W.	TOP OF WALL
GVL.	GRAVEL	T.B.	TOWEL BAR
GYP.	GYPSUM	T.	TREAD
GYP. BD.	GYPSUM WALLBOARD	TYP.	TYPICAL
		TOI.	TOILET
HDW.	HARDWARE	UNF.	UNFURNISHED
HDWD.	HARDWOOD	UR.	URINAL
HT.	HEIGHT	U.N.O.	UNLESS NOTED OTHERWISE
HC.	HANDICAP		
H.	HIGH	VERT.	VERTICAL
H.M.	HOLLOW METAL	VEST.	VESTIBULE
HRZ.	HORIZONTAL	V.T.R.	VENT THROUGH ROOF
H.B.	HOSE BIBB		
H.S.	HEAT STRENGTHENED	WSCT.	WAINSCOT
HVAC.	HEATING/VENTILATING/AIR CONDITIONING	W.C.	WATER CLOSET
HR.	HOUR	WP.	WATERPROOFING
		WT.	WEIGHT
I.D.	INSIDE DIAMETER	W.	WEST
I.R.	INSIDE RADIUS	WIN.	WINDOW
IN.	INCH	W/	WITH
INCL.	INCLUDED	W/O	WITHOUT
INFO.	INFORMATION	WD.	WOOD
INSUL.	INSULATION	WPT.	WORKING POINT
INT.	INTERIOR	W.W.F.	WELDED WIRE FABRIC
ISOL.	ISOLATION		
JAN.	JANITOR		
JT., JNT.	JOINT		
KIT.	KITCHEN		

SYMBOL LEGEND

GRID BUBBLE	
CENTERLINE	
LIMIT OF WORK	
PROPERTY LINE	
ELEMENT BELOW OR N.I.C. AS NOTED	
ELEMENT OVERHEAD	
MATCH LINE	
SECTION / WALL SECTION	
ELEVATION REFERENCE	
DETAIL REFERENCE	
INTERIOR ELEVATION REFERENCE	
POINT ELEVATION / LEVEL TARGET	
WINDOW TYPE	
DOOR NUMBER	
WALL ASSEMBLY TYPE	
REVISION NUMBER	
ROOM TAG	

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C201	ROUGH GRADING SECTIONS
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A112	SECOND FLOOR PLAN
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A303	BUILDING SECTIONS
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A403	3D EXTERIOR VIEWS
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M-0.3	SCHEDULES
M-1.0	1ST FLOOR HVAC PLAN
M-1.1	2ND FLOOR HVAC PLAN
M-1.2	ROOF HVAC PLAN
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P-0.2	PLUMBING SITE PLAN
P-1.0	BELOW GROUND PLUMBING PLAN
P-1.1	FIRST FLOOR PLUMBING PLAN
P-1.2	SECOND FLOOR PLUMBING PLAN
P-1.3	ROOF PLUMBING PLAN
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P-5.0	PLUMBING DETAIL
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NO.    DATE    REVISION

**allcove**  
BEACH CITIES  
HEALTH DISTRICT

**100% PRELIMINARY  
DESIGN SUBMITTAL**

PMA PROJECT NO.  
23007

DRAWING TITLE  
**DRAWING INDEX,  
SYMBOL LEGEND  
+ ABBREVIATIONS**

SCALE  
N.T.S.

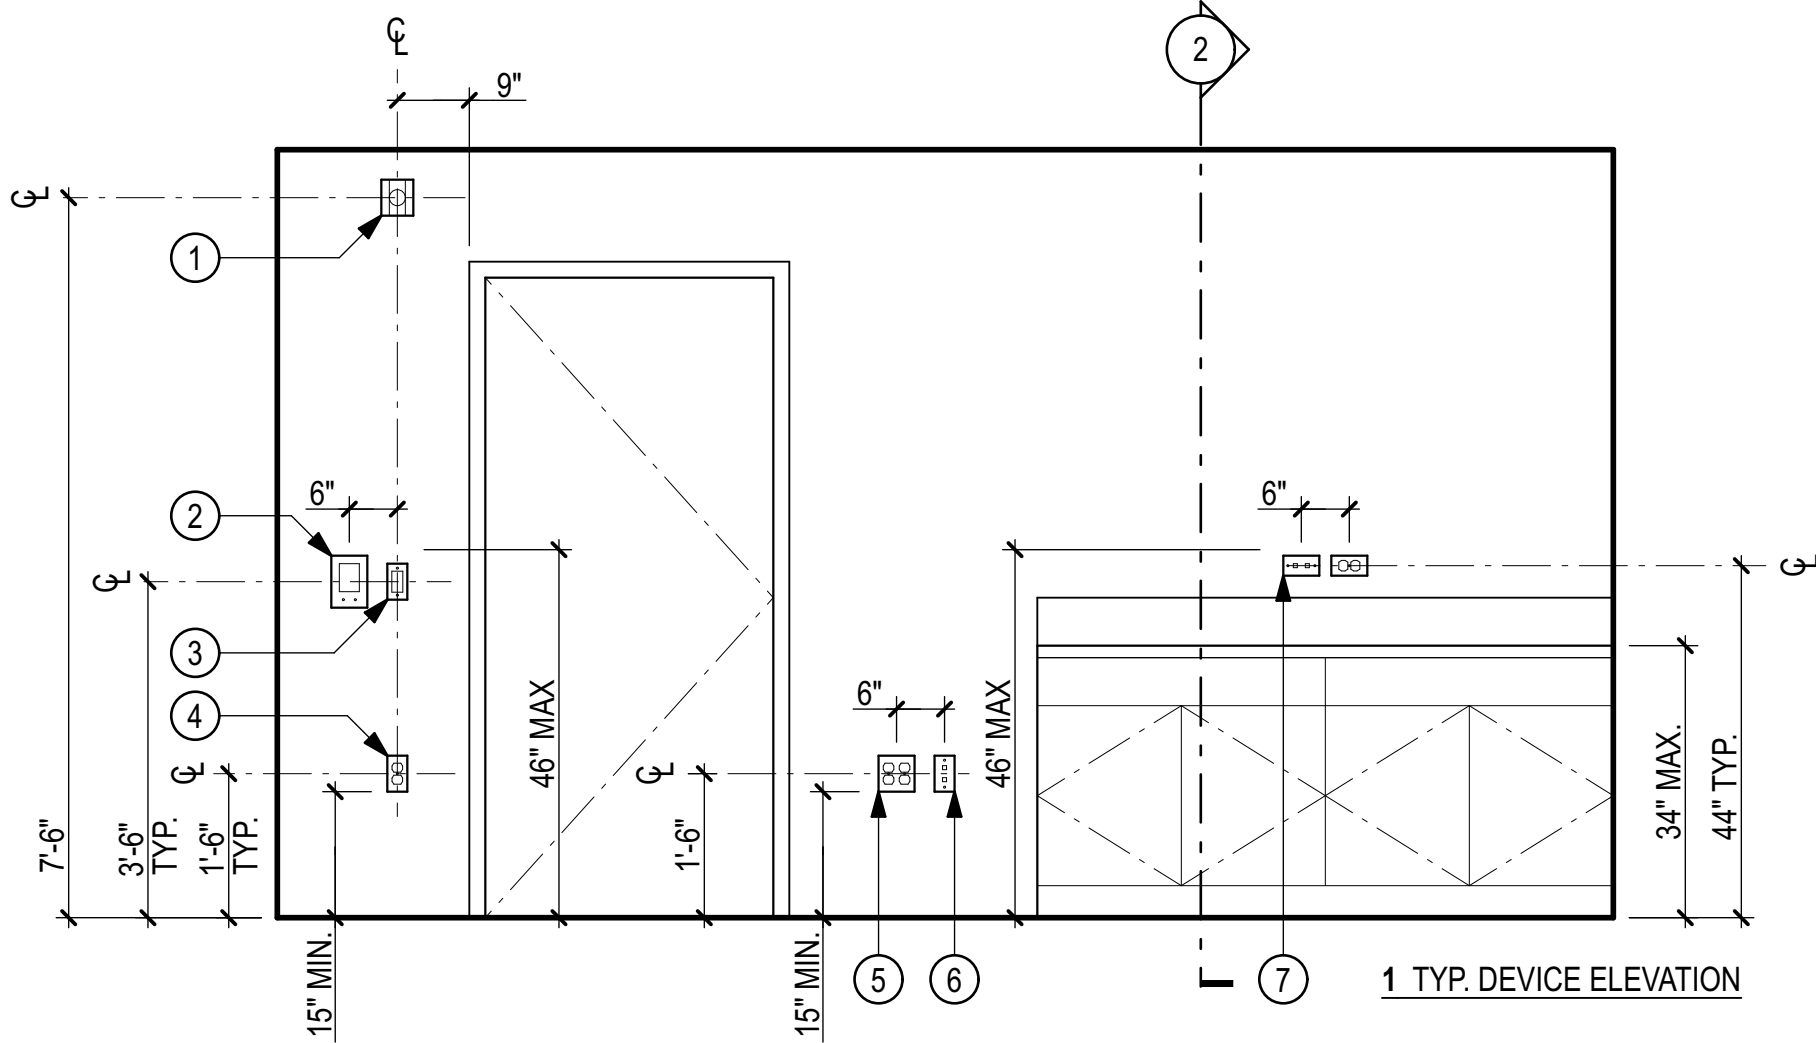
DATE  
02/28/2024

DRAWN    CHECKED  
E.C.    P.M.

SHEET NO.  
**G002**



ADA ACCESSIBLE DEVICE MOUNTING HEIGHTS



KEYNOTES

- 1 HORN / STROBE. REFER TO FIRFE ALARM DWGS.
- 2 THERMOSTAT. REFER TO MECH DWGS.
- 3 LIGHT SWITCH. REFER TO ELEC. DWGS.
- 4 DUPLEX RECEPTACLE. REFER TO ELEC. DWGS.
- 5 QUADRUPLUX RECEPTACLE. REFER TO ELEC. DWGS.
- 6 DATA RECEPTACLE. REFER TO TELE. DWGS.
- 7 HORIZONTAL RECEPTABLES ABV. COUNTERS TYP. REFER TO CASEWORK DWGS.

CALCULATION FOR PUBLIC RESTROOMS

NO.	ROOM NAME	NET AREA IN SQ. FT.	OCCUPANT LOAD FACTOR	OCCUPANT LOAD
B OCCUPANCY		1 per 150SF		
	TOTAL	6,360	150	43
	INTAKE CHECK-IN	105		
	LOBBY + RECEPTION	691		
	WORKSTATIONS	100		
	CAFÉ	228		
	LARGE GROUP MEETING ROOM	542		
	RECEPTION DESK	277		
	WORK ROOM	625		
	PRINTER AREA	24		
	OFFICE	192		
	BREAKROOM	171		
	STORAGE	47		
	FIRE RISER	15		
	MECHANICAL ROOM	17		
	THE COVE	1,415		
	RECEPTION DESK	131		
	SENSORY ROOM	185		
	GROUP ROOM	158		
	GROUP ROOM	158		
	CHAT ROOM	114		
	CHAT ROOM	145		
	CHAT ROOM	111		
	CHAT ROOM	114		
	CHAT ROOM	145		
	CHAT ROOM	111		
	EXAM ROOM	175		
	PRIVACY ROOM	82		
	CLEAN ROOM	49		
	DIRTY ROOM	49		
	STORAGE	57		
	STORAGE	67		
	JANITOR ROOM			

2022 CALIFORNIA PLUMBING CODE TABLE 422.1 MINIMUM PLUMBING FACILITIES

TOTAL REQUIRED FIXTURES	WATER CLOSET	URINAL	LAVATORY	DRINKING FOUNTAIN
	1 - 25	-	1 - 50	1 - 150
FEMALE (50% = 22 OCCUPANTS)	2	0	1	1
	1 - 50	1 - 100	1 - 75	
MALE (50% = 22 OCCUPANTS)	1	1	1	1

TOTAL PROVIDED FIXTURES	WATER CLOSET	URINAL	LAVITORY	DRINKING FOUNTAIN
UNISEX	4	2	4	2

CALCULATIONS BASED ON CALIFORNIA PLUMBING CODE, CHAPTER 4:  
TABLE A OCCUPANT LOAD FACTOR AND TABLE 422.1

VEHICLE PARKING TABLES

TOTAL PARKING SPACES

1 SPACE PER 300SF = 9,400 / 300 = 32 SPARKING PACES TOTAL

PARKING SPACES	TOTAL PARKING SPACES	REQUIRED	PROVIDED	REMARKS
AP	ACCESSIBLE PARKING SPACES	32	8	A
VA	VAN ADA ACCESSIBLE PARKING SPACES	1	1	B
EVC	ELECTRIC VEHICLE CAPABLE PARKING SPACES	8	8	C
EVCS	ELECTRIC VEHICLE CHARGING STATIONS	3	5	D
EVCS-AP	EV CHARGING STATION ADA ACCESSIBLE SPACES	1	1	E
EVCS-VA	EV CHARGING STATION ADA VAN ACCESSIBLE SPACES	1	1	F

REMARKS

- NUMBER OF REQUIRED ACCESSIBLE PARKING SPACES FOR 26-50 TOTAL SPACES PER CBC TABLE 11B-208.2.
- NUMBER OF REQUIRED VAN ACCESSIBLE SPACES PROVIDED PER CBC 11B-208.2.4.
- NUMBER OF REQUIRED EV CAPABLE FOR 26-50 TOTAL SPACES PER CAL GREEN TABLE 5.106.5.3.1.
- NUMBER OF REQUIRED EVCS FOR 26-50 TOTAL SPACES PER CAL GREEN TABLE 5.106.5.3.1.
- NUMBER OF REQUIRED ADA ACCESSIBLE ELECTRIC VEHICLE CHARGING SPACES FOR 7 TOTAL EVCS SPACES PER CBC TABLE 11B-228.3.2.1.
- NUMBER OF REQUIRED ADA VAN ACCESSIBLE ELECTRIC VEHICLE CHARGING SPACES FOR 7 TOTAL EVCS SPACES PER CBC TABLE 11B-228.3.2.1.

BICYCLE PARKING TABLE

BICYCLE PARKING	REQUIRED	PROVIDED
SBP STAFF LONG TERM BICYCLE PARKING (32 X 5% =2)	2	2
PBP PUBLIC BICYCLE PARKING (32 X 5% =6)	2	10*

\* PUBLIC BICYCLE PARKING TO INCLUDE E-BIKE CHARGING INFRASTRUCTURE.  
REFER TO CAL GREEN 5.105.4.1.1 FOR SHORT TERM BICYCLE PARKING REQUIREMENTS  
REFER TO CAL GREEN 5.105.4.1.2 LONG TERM BICYCLE PARKING REQUIREMENTS

FIRE RESISTANCE REQUIREMENTS

THE DESIGN BUILD TEAM SHALL VERIFY ALL FIRE RESISTANCE REQ. AND PROVIDE ASSEMBLIES AS REQ'D. BY CODE.

STRUCTURAL BUILDING ELEMENTS (CBC TABLE 601) (CBC TABLE 602)	MINIMUM FIRE RESISTANCE RATING
STRUCTURAL FRAME	0 HOUR
STRUCTURAL FRAME (SUPPORTING ROOF ONLY)	0 HOUR
BEARING WALLS (INTERIOR / EXTERIOR)	0 HOUR
FLOOR CONSTRUCTION	0 HOUR
ROOF CONSTRUCTION	0 HOUR
NON-STRUCTURAL ELEMENTS	0 HOUR

	MINIMUM FIRE RESISTANCE RATING
EXTERIOR WALLS / PARTITIONS (FIRE SEPARATION DISTANCE, X: X < 5 FT)	1 HOUR
EXTERIOR WALLS / PARTITIONS (FIRE SEPARATION DISTANCE, X: 5 < X < 10 FT)	1 HOUR
EXTERIOR WALLS / PARTITIONS (FIRE SEPARATION DISTANCE, X: 10 < X < 30 FT)	0 HOUR
EXTERIOR WALLS / PARTITIONS (FIRE SEPARATION DISTANCE, X: 30 < X FT)	0 HOUR
EXTERIOR DOORS AND WINDOWS (CBC TABLE 705.B)	NO LIMIT
INTERIOR WALLS AND PARTITIONS NOT OTHERWISE NOTED	REFER TO FLOOR PLAN

CORRIDORS (CBC TABLE 1020.1)	MINIMUM FIRE RESISTANCE RATING
ALL CORRIDORS	NO REQUIREMENT

INTERIOR FINISH

INTERIOR FINISHES FOR WALLS, CEILINGS, AND FLOORS WILL BE PROVIDED IN ACCORDANCE WITH THE REQUIREMENTS OF CBC SECTIONS 803 AND 804. FINISH REQUIREMENTS FOR WALLS IN A FULLY SPRINKLERED BUILDING ARE PROVIDED AS DESCRIBED IN THE TABLE BELOW.

	EXIT ENCLOSURES AND EXIT PASSAGEWAYS	CORRIDORS	ROOMS
GROUP B	CLASS B	CLASS C	CLASS C

CALIFORNIA ENERGY CODE

THE CALIFORNIA ENERGY CODE SECTION 10-103 REQUIRES ACCEPTANCE TESTING ON ALL NEWLY INSTALLED LIGHTING CONTROLS, MECHANICAL SYSTEMS, ENVELOPES, AND PROCESS EQUIPMENT AFTER INSTALLATION AND BEFORE PROJECT COMPLETION. AN ACCEPTANCE TEST IS A FUNCTIONAL PERFORMANCE TEST TO HELP ENSURE THAT NEWLY INSTALLED EQUIPMENT IS OPERATING AND IN COMPLIANCE WITH THE ENERGY CODE.

LIGHTING CONTROLS ACCEPTANCE TESTS MUST BE PERFORMED BY A CERTIFIED LIGHTING CONTROLS ACCEPTANCE TEST TECHNICIAN (ATT).

MECHANICAL SYSTEM ACCEPTANCE TESTS MUST BE PERFORMED BY A CERTIFIED MECHANICAL ATT FOR PROJECTS SUBMITTED ON OR AFTER OCTOBER 1, 2021.

ENVELOPE AND PROCESS EQUIPMENT ACCEPTANCE TESTS SHALL BE PERFORMED BY THE INSTALLING CONTRACTOR, ENGINEER/ARCHITECT OF RECORD OR THE OWNER'S AGENT.

A LISTING OF CERTIFIED ATT CAN BE FOUND AT: [HTTPS://WWW.ENERGY.CA.GOV/PROGRAMS-AND-TOPICS/PROGRAMS/ACCEPTANCE-TEST-TECHNICIAN-CERTIFICATION-PROVIDER-PROGRAM/ACCEPTANCE](https://www.energy.ca.gov/programs-and-topics/programs/acceptance-test-technician-certification-provider-program/acceptance).

THE ACCEPTANCE TESTING PROCEDURES MUST BE REPEATED, AND DEFICIENCIES MUST BE CORRECTED BY THE BUILDER OR INSTALLING CONTRACTOR UNTIL THE CONSTRUCTION/INSTALLATION OF THE SPECIFIED SYSTEMS CONFORM AND PASS THE REQUIRED ACCEPTANCE CRITERIA.

PROJECT INSPECTORS WILL COLLECT THE FORMS TO CONFIRM THAT THE REQUIRED ACCEPTANCE TESTS HAVE BEEN COMPLETED.

CODE SUMMARY

FIRE PROTECTION SYSTEMS

- AUTOMATIC FIRE SPRINKLERS WILL BE PROVIDED THROUGHOUT THIS BUILDING IN ACCORDANCE WITH 2022 CBC/CFC SECTION 903.
- A FIRE ALARM SYSTEM WILL BE PROVIDED IN ACCORDANCE WITH 2022 CBC/CFC SECTION 907.
- PORTABLE FIRE EXTINGUISHERS WILL BE PROVIDED IN ACCORDANCE WITH 2022 CBC/CFC SECTION 906.

MEANS OF EGRESS REQUIREMENTS

- A. OCCUPANT LOAD FACTORS (2022 CBC TABLE 1004.1.2)
- ASSEMBLY WITHOUT FIXED SEATS (CONCENTRATED) - 7 SF NET PER PERSON
  - ASSEMBLY - UNCONCENTRATED (CONFERENCE ROOM) - 15 SF NET PER PERSON
  - BUSINESS (OFFICE) - 150 SF GROSS PER PERSON
  - CIRCULATION - 100 SF GROSS PER PERSON
  - LOCKER ROOMS - 50 SF GROSS PER PERSON
  - MECHANICAL - 300 SF GROSS PER PERSON
  - STORAGE - 300 SF GROSS PER PERSON

B. SEPARATION OF EXITS (2022 CBC SECTION 1007.1.1 EXCEPTION 2)

WHERE TWO EXITS, EXIT ACCESS DOORWAYS, EXIT ACCESS STAIRWAYS OR RAMPS, OR ANY COMBINATION THEREOF ARE REQ'D. FROM ANY PORTION OF THE EXIT ACCESS THEY SHALL BE PLACED A DISTANCE APART EQUAL TO NOT LESS THAN ONE-THIRD THE LENGTH OF THE MAXIMUM OVERALL DIAGONAL DIM. OF THE AREA SERVED.

C. EXIT WIDTH (2022 CBC SECTION 1005.3.2)

- LEVEL MEANS OF EGRESS COMPONENTS (DOORS, CORRIDORS): 0.2 INCHES PER OCCUPANT

D. EGRESS BASED ON OCCUPANT LOAD (2022 CBC TABLE 1006.3.1 AND TABLE 1006.3.2(2))

- STORAGE AREAS WITH AN OCCUPANT LOAD OF 29 OR LESS MAY HAVE ONLY ONE MEANS OF EGRESS
- ASSEMBLY AREAS, BUSINESS AREAS AND MECHANICAL SPACES WITH AN OCCUPANT LOAD OF 49 OR LESS MAY HAVE ONLY ONE MEANS OF EGRESS
- FOR ALL OCCUPANCIES WITH AN OCCUPANT LOAD OF FEWER THAN 500 BUT MORE THAN 49 (OR 29 IN STORAGE AREAS) MUST HAVE AT LEAST TWO MEANS OF EGRESS
- FOR OCCUPANT LOAD OF 501 - 1,000 FOR ALL OCCUPANCIES MUST HAVE AT LEAST 3 MEANS OF EGRESS

E. MAXIMUM COMMON PATH OF TRAVEL IN BUILDINGS EQUIPPED THROUGHOUT WITH AN AUTOMATIC SPRINKLERE SYSTEM IN ACCORDANCE WITH SECTION 903.3.1.1 OR 903.3.1.2 (2022 CBC TABLE 1006.2.1)

- GROUP A3 - 75 FT
- GROUP B - 100 FT
- GROUP S-1 - 100 FT

F. EXIT ACCESS TRAVEL DISTANCE IN BUILDING EQUIPPED THROUGHOUT WITH AN AUTOMATIC SPRINKLER SYSTEM IN ACCORDANCE WITH SECTION 903.3.1.1 OR 903.3.1.2 (2022 CBC TABLE 1017.2)

- GROUP A3 - 250 FT
- GROUP B - 300 FT
- GROUP S-1 - 250 FT

G. CORRIDORS (2016 CBC SECTION 1020.2)

- MINIMUM CLEAR WIDTH: 44 INCHES WHEN SERVING 50 OR MORE OCCUPANTS AND 36 INCHES WHEN SERVING LESS THAN 50 OCCUPANTS (2022 CBC TABLE 1020.2)

H. DEAD-END CORRIDORS. WHERE MORE THAN ONE EXIT OR EXIT ACCESS DOORWAY IS REQUIRED, THE EXIT ACCESS SHALL BE ARRANGED SUCH THAT ARE NO DEAD ENDS IN CORRIDORS MORE THAN 20 FEET IN LENGTH (2022 CBC SECTION 1020.4)

- GROUP A3 - 20 FT
- GROUP B - 50 FT\*
- GROUP S-1 - 50 FT\*

\*EXCEPTIONS WHERE THE BUILDING IS EQUIPPED THROUGHOUT W/ AN AUTOMATIC SPRINKLER SYSTEM IN ACCORDANCE WITH SECTION 903.3.1.1

I. DOORS USED IN MEANS OF EGRESS (2022 CBC SECTION 1010 AND SECTION 1022)

- MINIMUM CLEAR WIDTH: 32 INCHES (MEASURED BETWEEN THE FACE OF THE DOOR AND THE STOP, WITH THE DOOR OPEN 90 DEGREES)
- MAXIMUM WIDTH OF A SWINGING DOOR LEAF: 48 INCHES
- MINIMUM HEIGHT: 80 INCHES CLEAR
- DOORS MUST SWING IN THE DIRECTION OF EGRESS TRAVEL WHEN SERVING MORE THAN 50 OCCUPANTS OR WHEN SERVING STORAGE ROOMS CONTAINING HAZARDOUS MATERIALS

J. SPECIAL PURPOSE HORIZONTAL SLIDING EGRESS DOORS (2022 CBC SECTION 1010.1.4.3)

- THE DOORS SHALL BE POWER OPERATED AND SHALL BE CAPABLE OF BEING OPERATED MANUALLY IN THE EVENT OF POWER FAILURE.
- THE DOORS SHALL BE OPENABLE BY A SIMPLE METHOD FROM BOTH SIDES WITHOUT SPECIAL KNOWLEDGE OR EFFORT.
- THE FORCE REQUIRED TO OPERATE THE DOOR SHALL NOT EXCEED 30 POUNDS TO SET THE DOOR IN MOTION AND 15 POUNDS TO CLOSE OR OPEN THE DOOR TO THE MINIMUM REQUIRED WIDTH.
- THE DOOR SHALL BE OPENABLE WITH A FORCE NOT TO EXCEED 15 POUNDS WHEN A FORCE OF 250 POUNDS IS APPLIED PERPENDICULAR TO THE DOOR ADJACENT TO THE OPENING DEVICE.
- THE DOOR ASSEMBLY SHALL COMPLY WITH THE APPLICABLE FIRE PROTECTION RATING.
- THE DOOR ASSEMBLY SHALL HAVE AN INTEGRATED STANDBY POWER SUPPLY.
- THE DOOR ASSEMBLY POWER SUPPLY SHALL BE ELECTRICALLY SUPERVISED.
- THE DOOR SHALL OPEN TO THE MINIMUM REQUIRED WIDTH WITHIN 10 SECONDS AFTER ACTIVATION OF THE OPERATING DEVICE.

K. ACCESSIBLE MEANS OF EGRESS REQUIRED (2022 CBC SECTION 1009.1)

ACCESSIBLE MEANS OF EGRESS SHALL COMPLY WITH THIS SECTION. ACCESSIBLE SPACES SHALL BE PEVOIDED WITH NOT LESS THAN ONE ACCESSIBLE MEANS OF EGRESS. WHERE MORE THAN ONE MEANS OF EGRESS ARE REQUIRED BY SECTION 1006.2 AND 1006.3 FROM ANY ACCESSIBLE SPACE, EACH ACCESSIBLE PORTION OF THE SPACE SHALL BE SERVED BY ACCESSIBLE MEANS OF EGRESS IN AT LEAST THE SAME NUMBER AS REQUIRED BY SECTION 1006.2 OR 1006.3. IN ADDITION TO THE REQUIREMENTS OF THIS CHAPTER, MEANS OF EGRESS, WHICH PROVIDE ACCESS TO, OR EGRESS FROM, BUILDINGS FOR PERSONS WITH DISABILITIES, SHALL ALSO COMPLY WITH THE REQUIREMENTS OF CHAPTER 11A (NA) OR 11B AS APPLICABLE.

L. THE BUIDING ENVELOPE MEETS ALL MANDATORY REQUIREMENTS PER 2022 TITLE 24.

ROOFING

- A. ROOF COVERING MATERIALS ARE TO BE CLASS A IN ACCORDANCE WITH 2022 CBC SECTION 1505.2

ROOFTOP MOUNTED PHOTOVOLTAIC PANELS

- A. 2022 CBC SECTION 3111.1.1, ROOFTOP-MOUNTED PHOTOVOLTAIC PANELS AND MODULES SHOULD COMPLY WITH THE REQUIREMENTS OF 2016 CBC, CHAPTER 15 AND THE CALIFORNIA FIRE CODE.

- B. 2022 CBC SECTION 3111.2, ACCESS AND PATHWAYS. ROOF ACCESS, PATHWAYS AND SPACING REQUIREMENTS SHALL BE PROVIDED IN ACCORDANCE WITH SECTIONS 3111.2.1 THROUGH 3111.2.3.3.

- C. 2022 CBC SECTION 1505.9, PHOTOVOLTAIC PANELS AND MODULES ROOFTOP MOUNTED PHOTOVOLTAIC PANEL SYSTEMS SHALL BE TESTED, LISTED AND IDENTIFIED WITH A FIRE CLASSIFICATION IN ACCORDANCE WITH UL 1703. THE FIRE CLASSIFICATION SHALL COMPLY WITH 2016 CBC TABLE 1505.1 BASED ON THE TYPE OF CONSTRUCTION OF THE BUILDING. THE BUILDING IS TYPE VB CONSTRUCTION, MINIMUM FIRE CLASSIFICATION CLASS C.

PROJECT DESCRIPTION

THE PROPOSED BEACH CITIES HEALTH DISTRICT (BCHD) ALLCOVE PROJECT WILL DEVELOP THE EXISTING SITE ADJACENT TO THE BCHD CAMPUS IN THE CITY OF REDONDO BEACH. THE NEW 9,370 SF TWO STORY PREFABRICATED MODULAR BUILDING WILL BE ASSEMBLED ON THE UNDEVELOPED SITE.

THE SITE HAS AN EXISTING CAPPED OIL WELL THAT WILL REMAIN. THE BUILDING MAY HAVE A BELOW SLAB VAPOR BARRIER TO MITIGATE AIRBORNE POLLUTANTS FROM THE CONTAMINATED SOIL. REFER TO OWNERS SOIL MITIGATION MONITORING PLAN.

THE PROJECT INCLUDES SITE WORK, UTILITIES, WALKWAYS, CURBS, GUTTERS, SIGNAGE, LANDSCAPING, IRRIGATION, SITE DRAINAGE, SITE LIGHTING, SURFACE PARKING, COMMUNICATIONS (SECURITY, TELE/DATA).

THE BUILDING WILL BE EQUIPPED WITH AN AUTOMATED FIRE ALARM, FIRE SPRINKLER SYSTEM (DESIGN-BUILD) AND A PHOTOVOLTAIC ROOF TOP SYSTEM (DESIGN-BUILD).

THE PROJECT IS DESIGNED TO MEET LEED GOLD LEVEL OF CERTIFICATION.

ADDRESS: 1200 BERYL STREET, REDONDO BEACH, CA 90277

AIN: 7502-017-902

SITE AREA: 18,855 SF

ALLOWABLE FLOOR AREA RATIO: 9,427.5 SF

PROPOSED BUILDING AREA: 9,370 SF

ALLOWABLE BUILDING HEIGHT: 30'-0"

PROPOSED BUILDING HEIGHT: 28'-6"

STORIES: 2 STORIES

PHOTOVOLTAIC ROOF AREA: 1,200 SF

SKYLIGHT AREA: 96 SF

SKYLIGHT TO ROOF RATIO: 96 SF / 5,029 SF = 2%

SPRINKLERS: APPROVED AUTOMATIC SPRINKLER SYSTEM IN COMPLIANCE WITH NFPA 13

OCCUPANCY: GROUP B: OFFICE SPACES

CONSTRUCTION TYPE: TYPE V-B (PREFABRICATED)

GROUP B (\$1) OCCUPANCY PERMITS TWO STORIES PER CBC TABLE 504.4 AND A 36,000 SF BASE ALLOWABLE AREA AREA PER CBC TABLE 506.2. THE BUILDING SHALL BE EQUIPPED THROUGHOUT WITH AN AUTOMATIC SPRINKLER SYSTEM INSTALLED IN ACCORDANCE WITH SECTION 903.3.1.1.

DELEGATED DESIGN / DEFERRED SUBMITTALS  
APPROVALS BY CITY OF REDONDO BEACH

- SUPERVISED AUTOMATIC FIRE SPRINKLER SYSTEM
- FIRE ALARM SYSTEM AND VOICE ALARM
- REFER TO SPECIFICATIONS FOR ADDITIONAL REQUIREMENTS.

OWNER FURNISHED CONTRACTOR INSTALLED ITEMS

- FURNITURE

APPLICABLE CODES AND STANDARDS

THE DESIGN BUILD TEAM SHALL VERIFY AND COMPLY WITH ALL RELEVANT CODE REQUIREMENTS AND AGENCY APPROVAL REQ.

2022 CALIFORNIA BUILDING STANDARDS CODE, TITLE 24, CALIFORNIA CODE OF REGULATIONS

PART 1	CALIFORNIA BUILDING STANDARDS ADMINISTRATIVE CODE
PART 2	CALIFORNIA BUILDING CODE (CBC), VOLUME 1 AND 2
PART 3	CALIFORNIA ELECTRICAL CODE (CEC)
PART 4	CALIFORNIA MECHANICAL CODE (CMC)
PART 5	CALIFORNIA PLUMBING CODE (CPC)
PART 6	CALIFORNIA ENERGY CODE
PART 9	CALIFORNIA FIRE CODE (CFC)
PART 11	CALIFORNIA GREEN BUILDING STANDARDS CODE
PART 12	CALIFORNIA REFERENCED STANDARDS CODE

NFPA 10 STANDARD FOR PORTABLE FIRE EXTINGUISHERS

NFPA 13 STANDARD FOR INSTALLATION OF SPRINKLER SYSTEMS, 2019 (W/ STATE OF CA AMENDMENTS)

NFPA 14 STANDARD FOR THE INSTALLATION OF STANDPIPE AND HOSE SYSTEMS (2019 EDITION WITH STATE OF CALIFORNIA AMENDMENTS).

NFPA 72 NATIONAL FIRE ALARM CODE, 2022 (WITH STATE OF CALIFORNIA AMENDMENTS)

WHEN NEITHER THE CALIFORNIA BUILDING CODE OR RELEVANT NFPA STANDARDS SPECIFICALLY COVER A SUBJECT RELATING TO BUILDING DESIGN AND CONSTRUCTION, RECOGNIZED FIRE PROTECTION ENGINEERING PRACTICES WILL BE EMPLOYED.

TITLE 19 C.C.R, PUBLIC SAFETY, SFM REGULATIONS

AMERICANS WITH DISABILITIES ACT (ADA) TITLE II

CALIFORNIA HEALTH AND SAFETY CODE

FEDERAL OCCUPATIONAL SAFETY AND HEALTH ACT OF 1970 (OSHA STANDARDS)

SAM MANAGEMENT MEMOS + EXECUTIVE ORDERS

LEADERSHIP IN ENERGY AND ENVIRONMENTAL DESIGN (LEED V.2009)



PAUL MURDOCH  
ARCHITECTS

6310 SAN VICENTE BLVD, SUITE 400  
LOS ANGELES, CA 90048  
T. 310.358-0993

THE DRAWINGS AND SPECIFICATIONS AND IDEAS, DESIGNS AND ARRANGEMENTS REPRESENTED THEREBY ARE AND SHALL REMAIN THE PROPERTY OF THE ARCHITECT, AND NO PART THEREOF SHALL BE COPIED, DISCLOSED TO OTHERS OR USED IN CONNECTION WITH ANY WORK OR PROJECT OTHER THAN THE SPECIFIC PROJECT FOR WHICH THEY HAVE BEEN PREPARED AND DEVELOPED WITHOUT THE WRITTEN CONSENT OF THE ARCHITECT. USUAL CONTACT WITH THESE DRAWINGS OR SPECIFICATIONS SHALL CONSTITUTE CONCLUSIVE EVIDENCE OF ACCEPTANCE OF THESE RESTRICTIONS. WRITTEN DIMENSIONS ON THESE DRAWINGS SHALL HAVE PRECEDENCE OVER SCALED DIMENSIONS. CONTRACTORS SHALL VERIFY AND BE RESPONSIBLE FOR ALL DIMENSIONS AND CONDITIONS ON THE JOB AND THIS OFFICE MUST BE NOTIFIED OF ANY VARIATIONS FROM THE DIMENSIONS AND CONDITIONS SHOWN BY THESE DRAWINGS. SHOP DETAILS MUST BE SUBMITTED TO THIS OFFICE FOR REVIEW BEFORE PROCEEDING WITH FABRICATION.

NO. DATE REVISION

allcove  
BEACH CITIES  
HEALTH DISTRICT

100% PRELIMINARY  
DESIGN SUBMITTAL

PMA PROJECT NO.  
23007

DRAWING TITLE  
CODE ANALYSIS

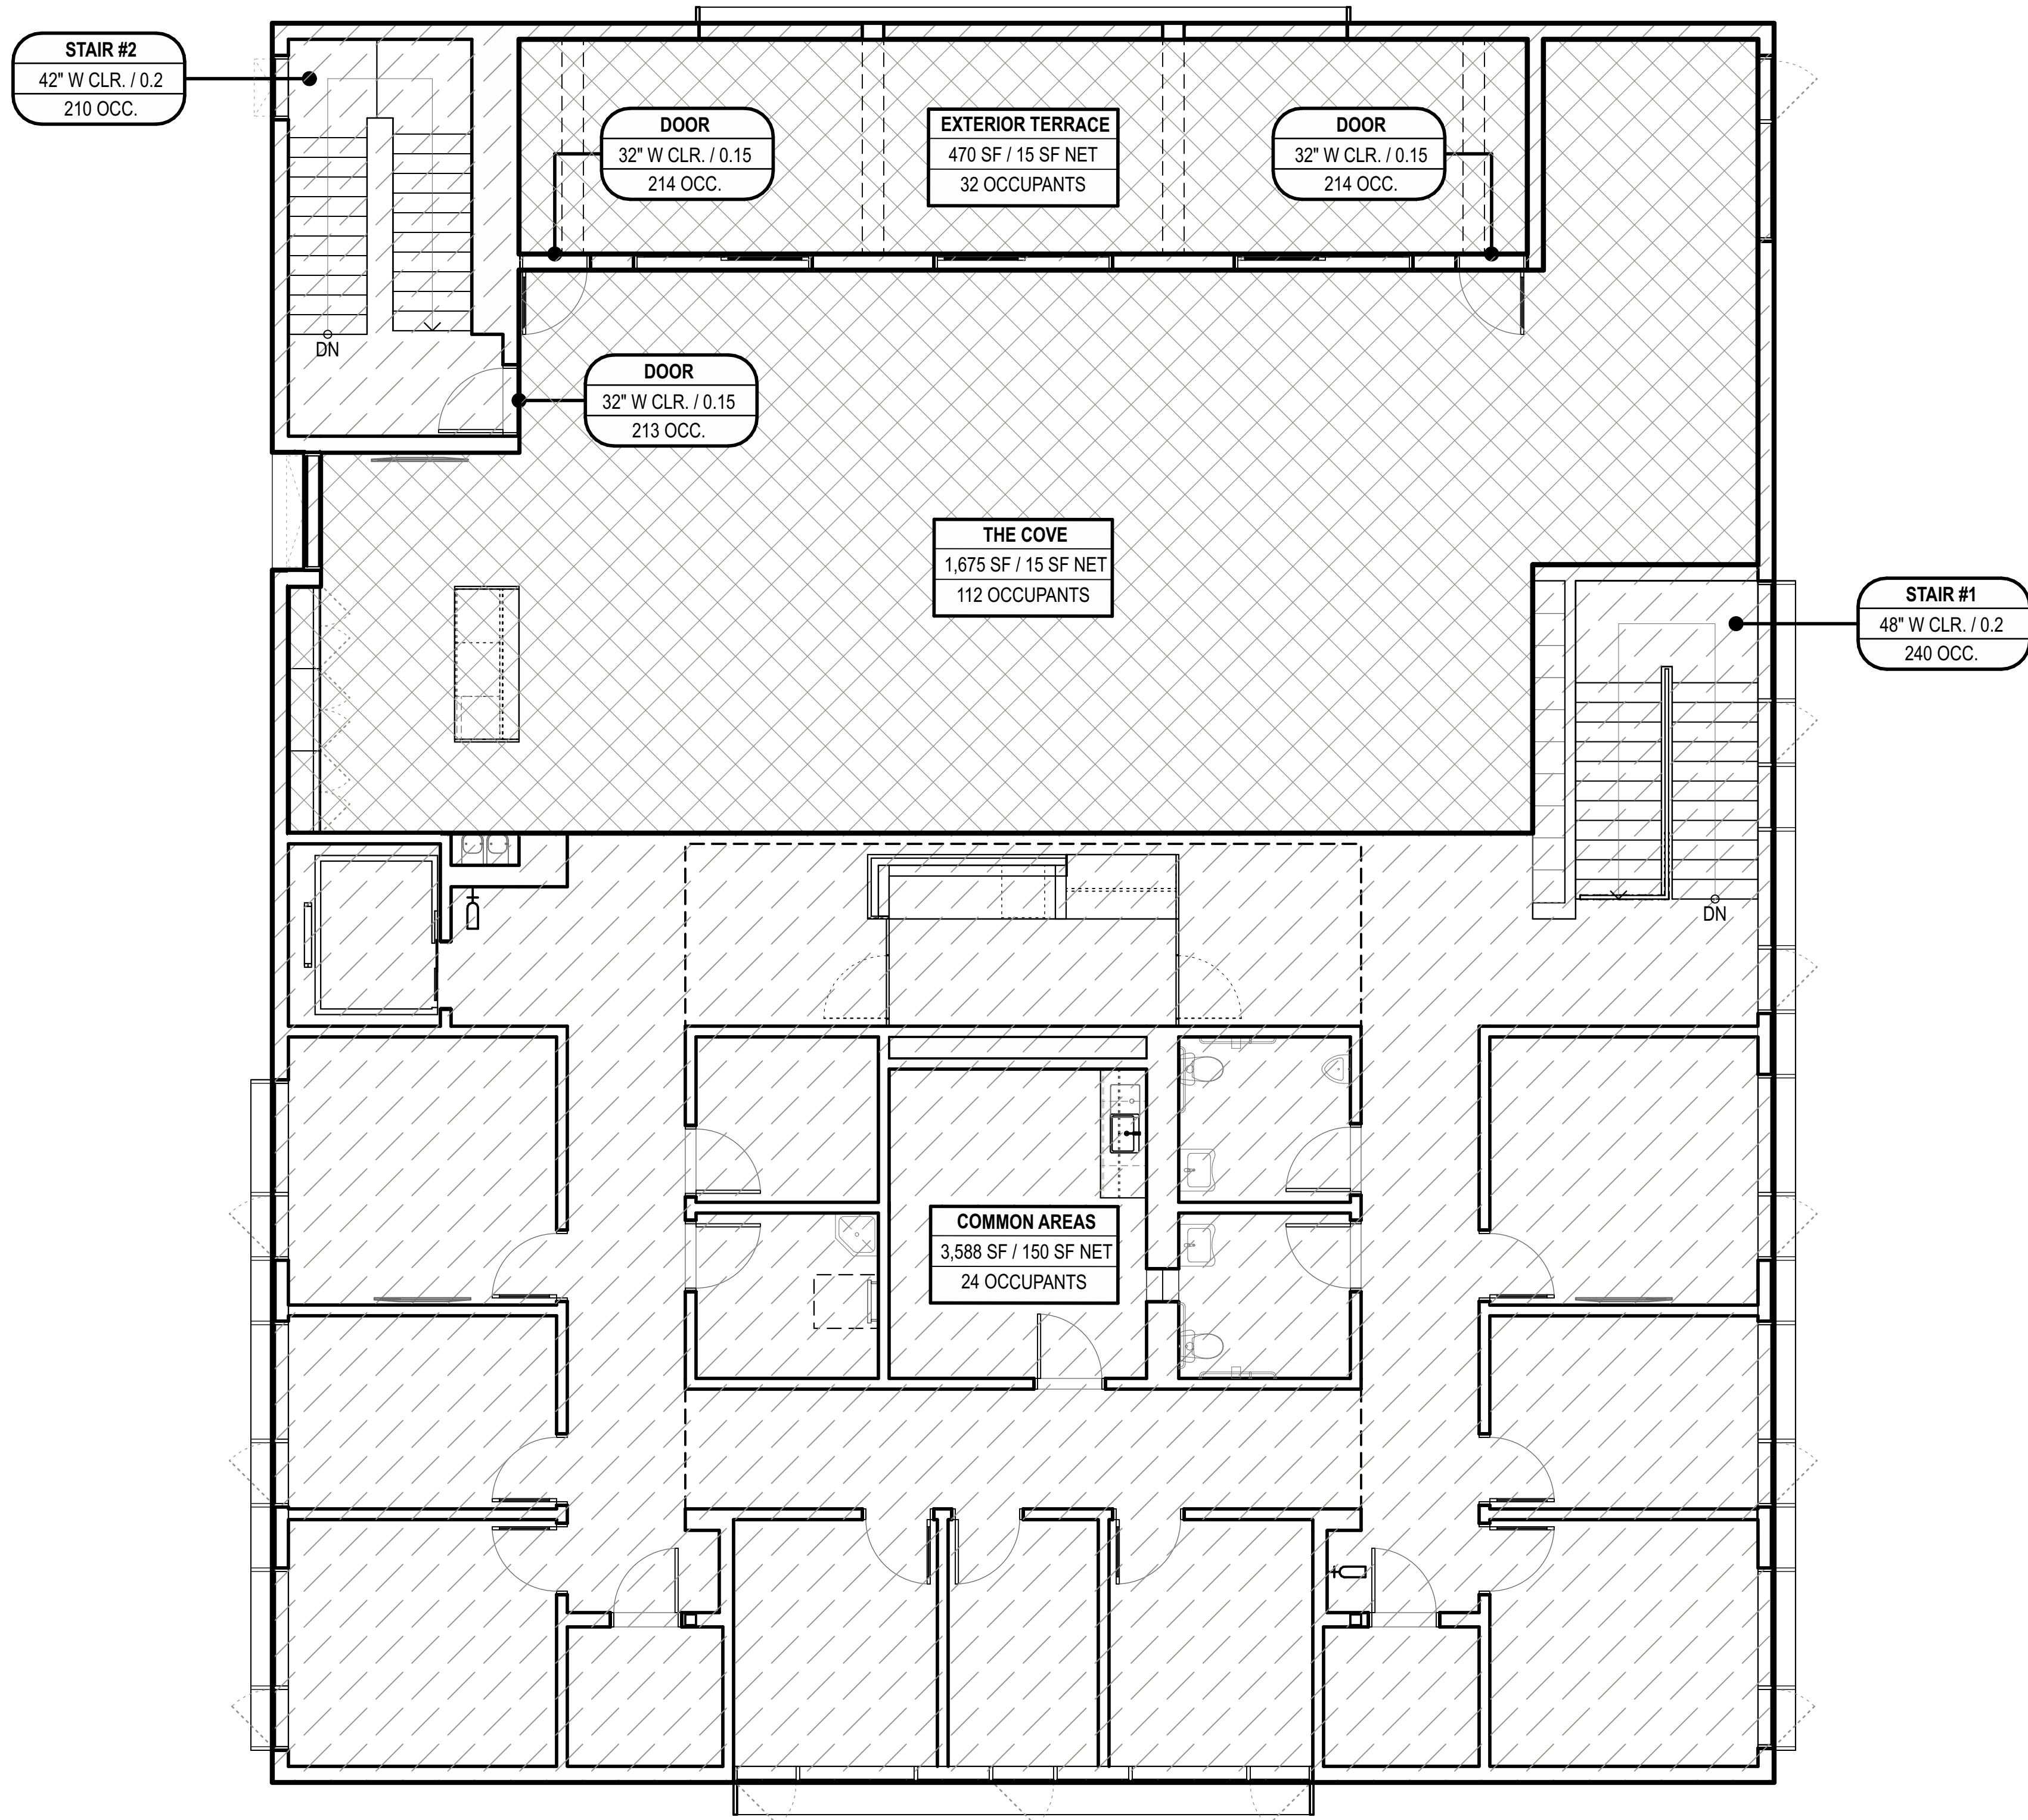
SCALE  
N.T.S.

DATE  
02/28/2024

DRAWN CHECKED  
E.C. P.M.

SHEET NO.  
G003






SECOND FLOOR EGRESS OCCUPANCY FLOOR PLAN

SCALE: 3/16" = 1'-0"

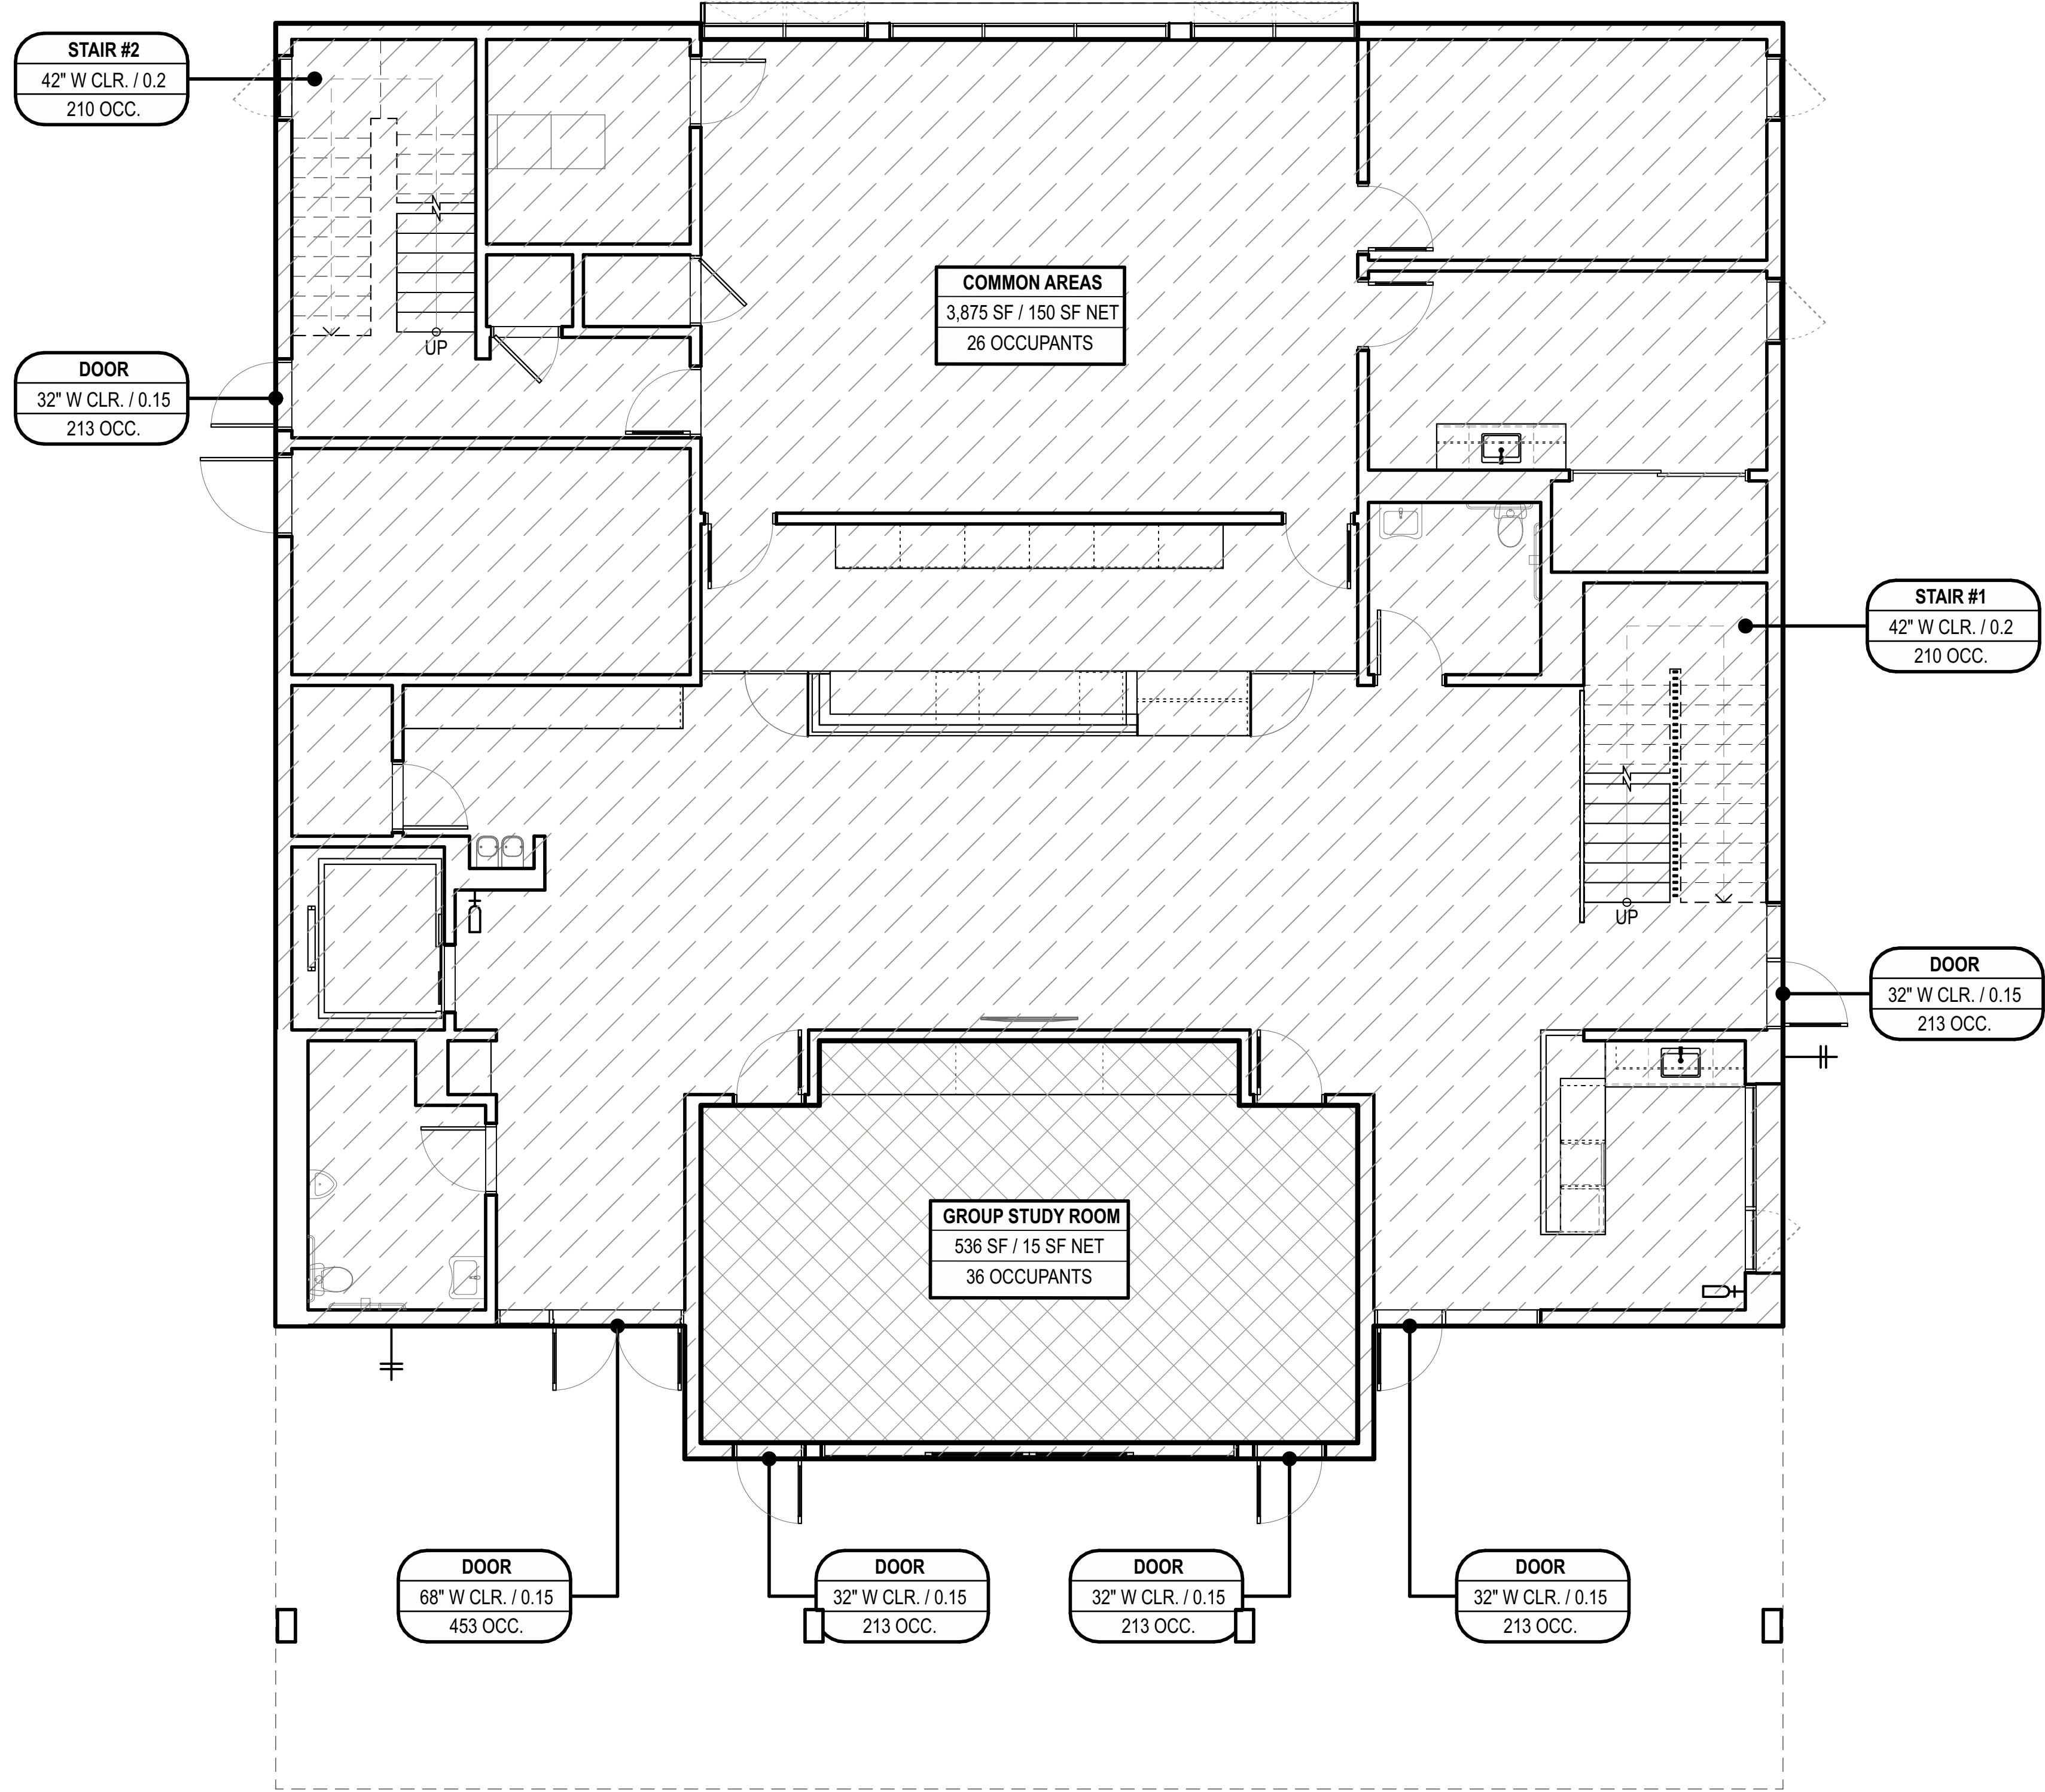2




FIRST FLOOR EGRESS OCCUPANCY FLOOR PLAN


SCALE: 3/16" = 1'-0"

1

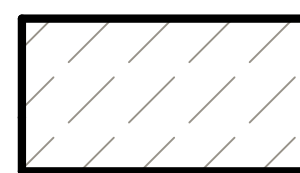
SYMBOL LEGEND



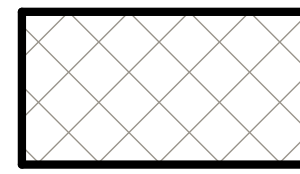
**BUSINESS AREA**  
150 GROSS OCCUPANT LOAD FACTOR  
PEE CBC TABLE 1004.5



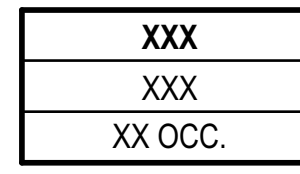
**CONCENTRATED BUSINESS USE AREA**  
15 NET OCCUPANT LOAD FACTOR ASSUMED  
PEE CBC 1004.8



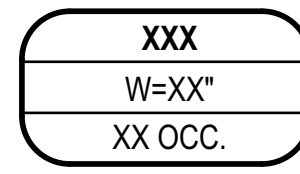**ROOM IDENTIFICATION TAG**  
ROOM NUMBER  
XXX  
AREA / LOAD FACTOR  
XX OCC.



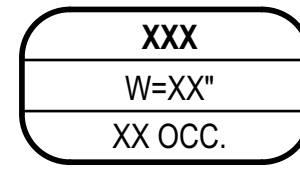**DOOR IDENTIFICATION TAG**  
DOOR NUMBER / ID  
W=XX"  
NET DOOR WIDTH (INCHES) / LOAD FACTOR  
XX OCC.




**STAIR IDENTIFICATION TAG**  
STAIR NUMBER / ID  
W=XX"  
NET STAIR WIDTH (INCHES) / LOAD FACTOR  
XX OCC.

NSF FLOOR AREA NET SF  
GSF FLOOR AREA GROSS SF  
(CHAPTER 2 DEFINITION 2022 CBC)

GENERAL NOTES

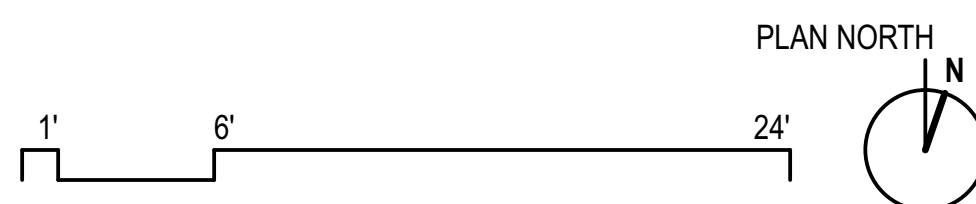1. ARCHITECT OF RECORD IS RESPONSIBLE TO VERIFY EGRESS OCCUPANCY CALCULATION AND MEET ALL REQUIREMENTS FOR EXITING PER CBC.
2. REFER TO E301 + E302 FOR EXIT SIGN LOCATIONS. EXIT SIGNS TO COMPLY W/ CBC 1013.
3. MAX. / MIN. AVERAGE ILLUMINATION FOR EXITING IN NORMAL / EMERGENCY CONDITIONS PER CBC 1008. REFER TO ELEC. DWGS.
4. MAXIMUM TRAVEL DISTANCE IS 250' PER CBC 2016 TABLE 1017.2. COMMON PATH OF TRAVEL PER CBC 1006.2.1 AND TABLE 1006.2.1 (75').
5. REFER TO A111 + A112 FOR FIRE EXTINGUISHER LOCATIONS + TRAVEL DISTANCE.
6. ALL INT. DOORS ARE MIN. 33" CLEAR NET WIDTH U.N.O.
7. EVERY ROOM OR SPACE THAT IS AN CONCENTRATED BUSINESS USE AREA SHALL HAVE THE OCCUPANT LOAD OF THE ROOM OR SPACE POSTED IN A CONSPICUOUS PLACE, NEAR THE MAIN EXIT OR EXIT ACCESS DOORWAY FROM THE ROOM OR SPACE. POSTED SIGNS SHALL BE OF AN APPROVED LEGIBLE PERMANENT DESIGN AND SHALL BE MAINTAINED BY THE CITY OR AUTHORIZED AGENT.
8. REFER TO A101 FOR PATH OF TRAVEL TO THE PUBLIC WAY.






CITY OF REDONDO BEACH DEPARTMENT OF  
ENGINEERING & BUILDING SERVICES GENERAL  
ENGINEERING NOTES

- A. MYLAR COPY OF THE RECORDED TRACT MAP/PARCEL MAP SHALL BE SUBMITTED TO THE CITY ENGINEER, PRIOR TO REQUESTING FINAL BUILDING INSPECTION.
- B. RECORDED COPY OF THE REQUIRED COVENANT/EASEMENT/DEED/DEED RESTRICTION SHALL BE SUBMITTED TO THE CITY ENGINEER, PRIOR TO REQUESTING FINAL BUILDING INSPECTION.
- C. ALL EASEMENTS, OIL WELLS, SUBSTRUCTURES, SUPERSTRUCTURES, LANDSCAPE, HARDSCAPE, UTILITY POLES, UTILITY BOXES, UTILITY VENTS, UTILITY VAULTS, UTILITY CABINETS, UTILITY OVERHEAD LINES AND WATER HYDRANTS ARE SHOWN ON THIS SITE PLAN.
- D. CONTRACTOR, AT ITS SOLE COST, SHALL ENSURE THAT PERMITTED WORK WILL NOT CREATE POTENTIAL FLOODING OF NEIGHBORING IMPROVEMENTS, NOR WILL IT ALTER THE EXISTING COURSE OF WATER FLOW.
- E. CONTRACTOR SHALL NOTIFY CITY ENGINEERING DIVISION 48 HOURS PRIOR TO COMMENCING ANY WORK IN PUBLIC RIGHT OF WAY.
- F. WORK IN PUBLIC RIGHT OF WAY, SHALL COMPLY WITH THE LATEST EDITION OF APWA STANDARD PLANS AND SPECIFICATIONS, AND SHALL BE EXECUTED TO THE SATISFACTION OF CITY ENGINEER AND/OR HIS REPRESENTATIVE.
- G. WORK IN PUBLIC RIGHT OF WAY SHALL BE PERFORMED BY LICENSED CONTRACTORS. CONTRACTORS AND SUBCONTRACTORS SHALL POSSESS VALID REDONDO BEACH BUSINESS LICENSES.
- H. CONTRACTOR SHALL MAINTAIN CONSTRUCTION PERMITS AND AN APPROVED SET OF PLANS ON SITE AT ALL TIMES. CONTRACTOR SHALL SURRENDER ALL REQUIRED CONSTRUCTION DOCUMENTS TO THE CITY ENGINEER AND/OR HIS REPRESENTATIVE UPON DEMAND.
- I. PRIOR TO ISSUANCE OF THE BUILDING/ENGINEERING PERMIT, CONTRACTOR MUST PROVIDE PROOF OF INSURANCE. CONTRACTOR SHALL MAINTAIN ON CITY FILES APPROVED ONE MILLION DOLLAR GENERAL LIABILITY NAMING THE CITY ADDITIONAL INSURED, WITH 30-DAY CANCELLATION NOTICE. THE INSURANCE POLICY SHALL STATE "THE CITY OF REDONDO BEACH, ITS OFFICERS, ELECTED OFFICIALS, ATTORNEYS, EMPLOYEES, MEMBERS OF BOARDS AND COMMISSIONS, AGENTS AND VOLUNTEERS ARE HEREBY NAMED ADDITIONAL INSURED." THE CERTIFICATE OF INSURANCE MUST STATE THAT THE INSURANCE IS "PRIMARY" AND NOT EXCESS. THE CANCELLATION CLAUSE SHALL STATE "SHOULD ANY OF THE ABOVE DESCRIBED POLICIES BE CANCELED BEFORE THE EXPIRATION DATE THEREOF, THE ISSUING COMPANY WILL MAIL 30 DAYS WRITTEN NOTICE TO THE CERTIFICATE HOLDER NAMED TO THE LEFT."
- J. CONTRACTOR SHALL REPLACE AT ITS SOLE COST, DAMAGED SIDEWALK, DRIVEWAYS, CURB, GUTTER AND PAVEMENT TO THE SATISFACTION OF THE CITY ENGINEER AND/OR HIS REPRESENTATIVE.
- K. CONSTRUCT NEW COMMERCIAL CONCRETE DRIVEWAY TYPE \_\_\_\_\_ WHERE NOTED ON SITE PLAN. NEW CONCRETE SHALL BE CLASS 520-C-2500.
- L. CONSTRUCT NEW CONCRETE SIDEWALK WHERE NOTED ON SITE PLAN. NEW SIDEWALK SHALL MATCH EXISTING. NEW CONCRETE SHALL BE CLASS 520-C-2500.
- M. CONSTRUCT NEW CONCRETE CURB AND GUTTER WHERE NOTED ON SITE PLAN. NEW CURB SHALL HAVE FACE HEIGHT OF 6 INCHES OR MATCH EXISTING. NEW GUTTER SHALL BE 12 INCHES WIDE OR MATCH EXISTING. NEW CONCRETE SHALL BE CLASS 520-C-2500.
- N. CONSTRUCT NEW FULL-DEPTH ASPHALT CONCRETE PAVEMENT WHERE NOTED ON SITE PLAN. NEW ASPHALTIC CONCRETE SHALL BE CLASS D1-PG-64-10.
- O. CONSTRUCT NEW CONCRETE CURB RAMP WITH ADJACENT 3-FOOT MINIMUM ASPHALTIC CONCRETE PAVEMENT, WHERE NOTED ON SITE PLAN. NEW CONCRETE SHALL BE CLASS 520-C-2500. NEW ASPHALTIC CONCRETE SHALL BE CLASS D1-PG-64-10.
- P. NEW SEWER LATERAL SHALL BE CONNECTED TO MAIN SEWER LINE WITHIN PROPERTY FRONTAGE. SEWER LATERAL SHALL BE PERPENDICULAR TO MAIN SEWER LINE. MINIMUM SEWER LATERAL DIAMETER SHALL BE 4-INCH. NO CONNECTION TO EXISTING UNLESS THE EXISTING SEWER MEETS THE CURRENT CODE REQUIREMENTS AND THE APPROVAL OF THE BUILDING DIVISION. QUALITY/QUANTITY OF SEWAGE CONSTITUENTS SHALL COMPLY WITH THE REQUIREMENTS OF THE LATEST EDITION OF THE WASTEWATER ORDINANCE OF THE SANITATION DISTRICTS OF LOS ANGELES COUNTY. PROVIDE 6-INCH CLEAN-OUT IMMEDIATELY BEHIND SIDEWALK, ENCASE CLEAN-OUT IN CONCRETE BOX MARKED "S" OR "SEWER". DESIGN SHALL BE PERFORMED BY A REGISTERED CIVIL ENGINEER.
- Q. NEW PUBLIC OR QUASI-PUBLIC UTILITY FACILITIES SHALL BE LOCATED IN PUBLIC PARKWAY (THE LANDSCAPED AREAS BETWEEN THE CURB AND THE SIDEWALK OR THE CITY'S RIGHT OF WAY LINE), OUTSIDE OF CURB RAMPS, DRIVEWAYS AND SIDEWALK, UNLESS OTHERWISE NOTED ON SITE PLAN.
- R. TRAFFIC DELINEATION SHALL BE EXECUTED IN ACCORDANCE WITH THE LATEST EDITION OF THE CALIFORNIA MANUAL ON UNIFORM TRAFFIC CONTROL DEVICES (CA-MUTCD) AND TO THE SATISFACTION OF THE CITY ENGINEER AND/OR HIS REPRESENTATIVE.
- S. COMMERCIAL VEHICLES TRANSPORTING SOIL, EQUIPMENT OR CONSTRUCTION MATERIALS, AND HAVING AS DEFINED IN SECTION 390 OF CVC OF 6,000 POUNDS OR MORE OR HAVING MANUFACTURER'S GROSS WEIGHT RATING AS DEFINED IN SECTION 390 OF CVC OF 10,000 POUNDS OR MORE SHALL USE DESIGNATED TRUCK ROUTE TO COMMUTE TO PROJECT SITE. ANY COMMERCIAL VEHICLE HAVING A FULLY LOADED WEIGHT OF 20,000 POUNDS OR MORE SHALL NOT USE CONDITIONAL TRUCK ROUTE.
- T. PUBLIC WORKS INSPECTOR SHALL INSPECT ALL STREET IMPROVEMENTS; ALL SEWER SYSTEMS INCLUDING ALL PIPING, TRENCHING, BACKFILLING AND SEWER EJECTOR; ALL STORM DRAIN SYSTEMS INCLUDING ALL PIPING, TRENCHING, BACKFILLING, CATCH BASINS, SUMP PUMPS AND OIL/WATER SEPARATOR. FIRST INSPECTION SHALL TAKE PLACE AFTER FORMS ARE IN PLACE FOR SIDEWALKS, DRIVEWAYS, ETC. OR AT THE TIME OF CONSTRUCTION OF THE SEWER LINE SADDLE. SECOND INSPECTION SHALL TAKE PLACE WHILE SIDEWALKS, DRIVEWAYS, ETC., ARE BEING POURED AND FINISHED OR AT THE TIME OF BACKFILLING. BACKFILLING, COMPACTION AND TESTING SHALL BE CONDUCTED IN ACCORDANCE WITH CITY STANDARDS AND TO THE SATISFACTION OF THE CITY ENGINEER AND/OR HIS REPRESENTATIVE. FINAL INSPECTION WILL BE MADE AFTER CITY BUILDING DIVISION HAS MADE THEIR FINAL INSPECTION. AT THAT TIME, IF ALL WORK PERTAINING TO PUBLIC RIGHT OF WAY IS IN GOOD ORDER, THE PERMIT DEPOSITS WILL BE RELEASED, LESS ANY AND ALL CHARGES.
- U. CONTRACTOR SHALL ARRANGE FOR PUBLIC WORKS INSPECTION 24 HOURS IN ADVANCE. CONTRACTOR SHALL CONTACT THE ENGINEERING SERVICES DIVISION AT (310) 937-6653 BEFORE 3:00 P.M. FOR ALL INSPECTION REQUESTS. CALLS RECEIVED AFTER 3:00 P.M. SHALL NOT BE SCHEDULED FOR NEXT BUSINESS DAY INSPECTION.
- V. CONTRACTOR SHALL SUBMIT COMPACTION REPORTS AND CONCRETE/ASPHALT CLASS CERTIFICATES TO THE ENGINEERING SERVICES DIVISION PRIOR TO REQUESTING FINAL INSPECTION.
- W. DUST CONTROL SHALL BE ENFORCED TO THE SATISFACTION OF THE CITY ENGINEER AND/OR HIS REPRESENTATIVE THROUGHOUT CONSTRUCTION.
- X. NOISE CONTROL SHALL BE ENFORCED TO THE SATISFACTION OF THE CITY ENGINEER AND/OR HIS REPRESENTATIVE THROUGHOUT CONSTRUCTION. ACTUAL CONSTRUCTION ACTIVITIES IN PUBLIC RIGHT OF WAY MAY OCCUR FROM 7:00 A.M. TO 6:00 P.M., MONDAY THROUGH FRIDAY. NO WORK IN PUBLIC RIGHT OF WAY SHALL OCCUR ON SATURDAYS WITHOUT PRIOR AUTHORIZATION FROM THE CITY ENGINEER AND/OR HIS REPRESENTATIVE. AUTHORIZED WORK ON SATURDAYS SHALL OCCUR FROM 9:00 A.M. TO 5:00 P.M. NO WORK IN PUBLIC RIGHT OF WAY SHALL OCCUR ON SUNDAYS OR NATIONAL HOLIDAYS.
- Y. PUBLIC RIGHT OF WAY SHALL BE KEPT CLEAR AND CLEAN TO THE SATISFACTION OF THE CITY ENGINEER AND/OR HIS REPRESENTATIVE THROUGHOUT CONSTRUCTION. NO STORAGE OF DEBRIS, MATERIALS OR EQUIPMENT SHALL BE ALLOWED ON PUBLIC RIGHT OF WAY WITHOUT PRIOR WRITTEN CONSENT FROM THE CITY ENGINEER AND/OR HIS REPRESENTATIVE. SUCH CONSENT SHALL BE RENEWED DAILY. IF CITY CREWS ARE CALLED UPON TO PERFORM WORK OF CONTRACTOR, REGARDING CITY RIGHT OF WAY, CONTRACTOR SHALL BE CHARGED FOR ALL EXPENSES INCURRED BY CITY CREWS.
- Z. CONTRACTOR SHALL LOCATE AND PROTECT IN PLACE EXISTING UTILITIES AT ITS SOLE COST. CONTRACTOR SHALL REPAIR, AT ITS COST AND TO THE SATISFACTION OF THE CITY ENGINEER, HIS REPRESENTATIVE AND/OR TO THE UTILITY COMPANIES, ANY DAMAGE INFLICTED BY CONTRACTOR ON EXISTING UTILITIES.
- AA. CONTRACTOR SHALL LOCATE AND PROTECT IN PLACE EXISTING SURVEY POINTS AT ITS SOLE COST. CONTRACTOR SHALL RE-ESTABLISH DAMAGED SURVEY POINTS, AT ITS SOLE COST, AND TO THE SATISFACTION OF THE CITY ENGINEER AND/OR HIS REPRESENTATIVE.
- BB. CONTRACTOR SHALL REPLACE AT ITS SOLE COST, REMOVED/DAMAGED TREES/LANDSCAPING WITHIN PUBLIC RIGHT OF WAY, TO THE SATISFACTION OF THE CITY ENGINEER AND/OR HIS REPRESENTATIVE.

GENERAL NOTES

1. ALL NEW CONSTRUCTION SHALL COMPLY WITH THE CONTRACT DOCUMENTS AND LATEST EDITIONS OF THE CALIFORNIA BUILDING CODE, "STANDARD SPECIFICATIONS FOR PUBLIC WORKS CONSTRUCTION", AND CITY OF REDONDO BEACH LOCAL ORDINANCES AS APPLICABLE.
2. ALL GRADING WORK SHALL BE PERFORMED IN ACCORDANCE WITH THE REQUIREMENTS AND RECOMMENDATIONS CONTAINED IN THE GEOTECHNICAL INVESTIGATION "SUPPLEMENTAL GEOTECHNICAL STUDY REPORT, HEALTHY LIVING CAMPUS PROJECT" DATED MAY 27, 2022 BY CONVERSE CONSULTANTS.
3. THE CONTRACTOR SHALL ASSUME SOLE AND COMPLETE RESPONSIBILITY FOR THE JOB SITE CONDITIONS, INCLUDING SAFETY OF ALL PERSONS AND PROPERTY, DURING THE COURSE OF CONSTRUCTION OF THIS PROJECT. THIS REQUIREMENT SHALL APPLY CONTINUOUSLY, AND SHALL NOT BE LIMITED TO NORMAL WORKING HOURS.
4. PRIOR TO COMMENCING CONSTRUCTION, THE CONTRACTOR SHALL VERIFY ALL JOIN CONDITIONS FOR GRADING, DRAINAGE AND UNDERGROUND FACILITIES INCLUDING LOCATION AND ELEVATION OF EXISTING UNDERGROUND FACILITIES AT CROSSINGS WITH PROPOSED UNDERGROUND FACILITIES. IF CONDITIONS DIFFER FROM THOSE SHOWN ON THE PLANS, THE CONTRACTOR SHALL NOTIFY THE ENGINEER AND SHALL NOT BEGIN CONSTRUCTION UNTIL THE CHANGED CONDITIONS HAVE BEEN EVALUATED.
5. ALL DRAWINGS ARE CONSIDERED TO BE A PART OF THE CONTRACT DOCUMENTS. THE CONTRACTOR SHALL BE RESPONSIBLE FOR THE REVIEW AND COORDINATION OF ALL DRAWINGS AND SPECIFICATIONS PRIOR TO THE START OF CONSTRUCTION. ANY DISCREPANCIES THAT OCCUR SHALL BE BROUGHT TO THE ATTENTION OF THE ARCHITECT PRIOR TO THE START OF CONSTRUCTION SO THAT A CLARIFICATION CAN BE ISSUED. ANY WORK PERFORMED IN CONFLICT WITH THE CONTRACT DOCUMENTS OR ANY CODE REQUIREMENTS SHALL BE CORRECTED BY THE CONTRACTOR AT THEIR OWN EXPENSE AND AT NO EXPENSE TO THE OWNER OR ARCHITECT.
6. THE ENGINEER PREPARING THESE PLANS WILL NOT BE RESPONSIBLE FOR, OR LIABLE FOR, UNAUTHORIZED CHANGES TO OR USES OF THESE PLANS. ALL CHANGES TO THESE PLANS MUST BE IN WRITING AND MUST BE APPROVED BY THE PREPARER OF THESE PLANS.
7. NOTES AND DETAILS ON DRAWINGS SHALL TAKE PRECEDENCE OVER GENERAL NOTES AND TYPICAL DETAILS WHERE NO DETAILS ARE GIVEN, CONSTRUCTION SHALL BE AS SHOWN FOR SIMILAR WORK.
8. THE EXISTENCE, LOCATION AND CHARACTERISTICS OF UNDERGROUND UTILITY INFORMATION SHOWN ON THESE PLANS HAVE BEEN OBTAINED FROM A REVIEW OF AVAILABLE RECORD DATA. NO REPRESENTATION IS MADE AS TO THE ACCURACY OR COMPLETENESS OF SAID UTILITY INFORMATION. THE CONTRACTOR SHALL TAKE PRECAUTIONARY MEASURES TO PROTECT THE UTILITY LINES SHOWN AND ANY OTHER LINES NOT OF RECORD OR NOT SHOWN ON THESE PLANS.
9. IF AT ANY TIME, DURING GRADING OPERATIONS, ANY UNFAVORABLE GEOLOGICAL CONDITIONS ARE ENCOUNTERED, GRADING IN THAT AREA WILL STOP UNTIL APPROVED CORRECTIVE MEASURES ARE OBTAINED.
10. THE PROPOSED GRADE IS THE FINAL GRADE AND NOT THE ROUGH GRADE. THE CONTRACTOR SHALL SUBTRACT THE THICKNESS OF THE PAVED SECTION AND/OR LANDSCAPE TOPSOIL SECTION TO ARRIVE AT THE ROUGH GRADE ELEVATION.
11. STRAIGHT GRADE SHALL BE MAINTAINED BETWEEN CONTOUR LINES AND SPOT ELEVATIONS UNLESS OTHERWISE SHOWN ON THE PLANS.
12. ALL DEBRIS AND FOREIGN MATERIAL SHALL BE REMOVED FROM THE SITE AND DISPOSED OF AT APPROVED DISPOSAL SITES. THE CONTRACTOR SHALL OBTAIN NECESSARY PERMITS FOR THE TRANSPORTATION OF MATERIAL TO AND FROM THE SITE.
13. ALL FILL SOILS OR SOILS DISTURBED OR OVEREXCAVATED DURING CONSTRUCTION SHALL BE COMPACTED PER THE REQUIREMENTS OF THE SOILS REPORT BUT NOT LESS THAN 90% MAXIMUM DENSITY AS DETERMINED BY A.S.T.M. SOIL COMPACTION TEST D-1557.
14. THE CONTRACTOR SHALL OBTAIN AN O.S.H.A. PERMIT FROM THE CALIFORNIA DIVISION OF INDUSTRIAL SAFETY PRIOR TO THE CONSTRUCTION OF TRENCHES OR EXCAVATIONS WHICH ARE FIVE FEET OR DEEPER.
15. DIMENSIONS TO PIPELINES ARE TO CENTERLINE UNLESS OTHERWISE NOTED.
16. ALL WATER LINES SHALL BE INSTALLED WITH 36" MINIMUM COVER FROM TOP OF PIPE TO FINISHED GRADE, UNLESS OTHERWISE NOTED.
17. THRUST BLOCKS SHALL BE INSTALLED AT WATERLINE HORIZONTAL AND VERTICAL BENDS, TEES, CAPPED ENDS AND REDUCERS ACCORDING TO THE DETAILS PROVIDED ON THESE PLANS.
18. CONSTRUCTION STAKING FOR IMPROVEMENTS SHOWN ON THESE PLANS SHALL BE PERFORMED BY A LICENSED LAND SURVEYOR. CONSTRUCTION STAKING SURVEYOR SHALL BE RESPONSIBLE FOR COORDINATION OF THESE PLANS WITH SOURCE DRAWINGS PREPARED BY ARCHITECT, LANDSCAPE ARCHITECT, STRUCTURAL ENGINEER, MEP CONSULTANT AND ANY OTHER DISCIPLINE PRIOR TO START OF STAKING AND CONSTRUCTION. ANY DISCREPANCIES THAT OCCUR SHALL BE BROUGHT TO THE ATTENTION OF THE OWNER'S PROJECT MANAGER PRIOR TO THE START OF CONSTRUCTION SO THAT A CLARIFICATION CAN BE ISSUED.
19. THE CONTRACTOR SHALL REPLACE ALL EXISTING IMPROVEMENTS DAMAGED DURING CONSTRUCTION TO MATCH EXISTING, INCLUDING PERMANENT TRENCH RESURFACING.
20. CONTRACTOR TO CONTACT UNDERGROUND SERVICE ALERT (800-227-2600) PRIOR TO EXCAVATION.
21. ALL DIMENSIONS ARE IN FEET OR DECIMALS THEREOF.
22. ALL CURB DIMENSIONS AND RADII ARE TO PAVEMENT FACE OF CURB.
23. CONTRACTOR TO BE AWARE OF ALL OVERHEAD LINES AT ALL TIMES, SO AS NOT TO DISTURB THEM.
24. WATER SHALL BE PROVIDED ONSITE AND USED TO CONTROL DUST DURING CONSTRUCTION OPERATIONS.
25. CONTRACTOR SHALL OBTAIN ANY NECESSARY PERMITS FROM THE CITY OF REDONDO BEACH FOR ALL WORK WITHIN THE PUBLIC RIGHT-OF-WAY.
26. STORM DRAINAGE SYSTEMS SHOWN ON THESE PLANS HAVE BEEN DESIGNED FOR THE FINAL SITE CONDITION AT COMPLETION OF THE PROJECT. THE CONTRACTOR IS RESPONSIBLE FOR MAINTAINING ADEQUATE DRAINAGE OF THE SITE, DURING INTERIM CONDITIONS OF CONSTRUCTION.
27. CONTRACTOR SHALL OBTAIN ALL REQUIRED PERMITS, INCLUDING NPDES, FROM THE APPROPRIATE JURISDICTIONAL AGENCIES FOR DISCHARGE OF GROUNDWATER THAT MAY BE NECESSARY TO ACCOMPLISH EXCAVATIONS SHOWN ON THESE PLANS.
28. REFER TO DIVISION 1 PROJECT MANUAL FOR ADDITIONAL REQUIREMENTS.

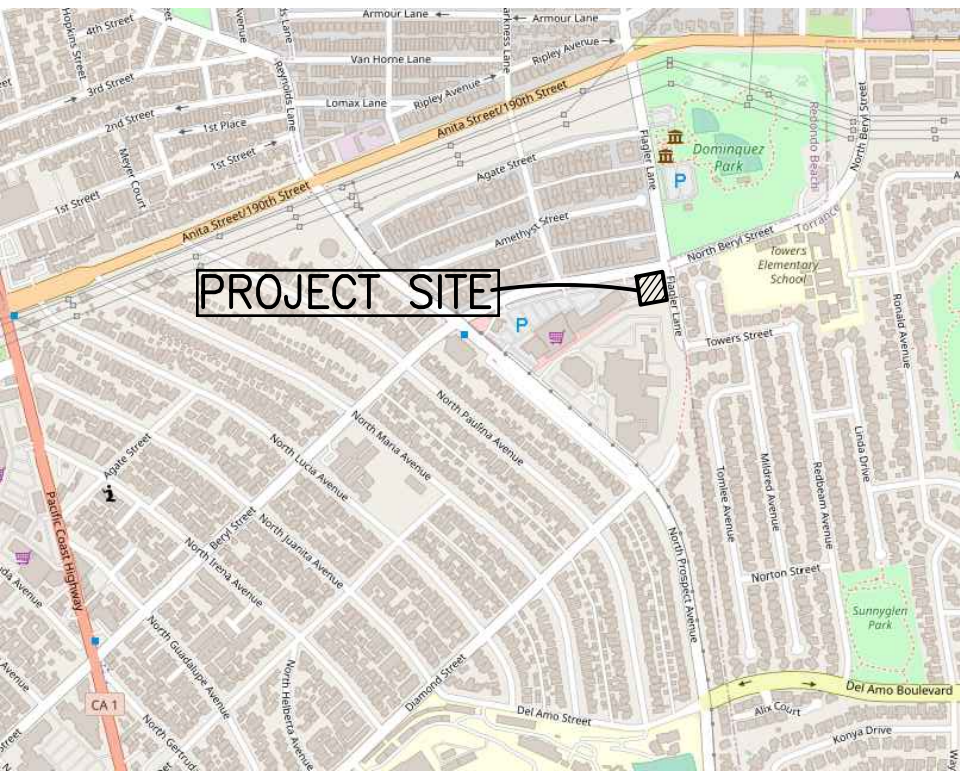ALLCOVE  
BEACH CITIES HEALTH DISTRICT  
CIVIL PLANS



VICINITY MAP  
(NOT TO SCALE)

LEGAL DESCRIPTIONS

THE LAND REFERRED TO HEREIN BELOW IS SITUATED IN THE CITY OF REDONDO BEACH, IN THE COUNTY OF LOS ANGELES, STATE OF CALIFORNIA, AND IS DESCRIBED AS FOLLOWS:

**SITE ADDRESS:**  
514 N. PROSPECT AVE.  
REDONDO BEACH, CA 90277


PARCEL 2  
P.M. NO. 13030  
P.M.B. 144-3  
APN 7502-017-902

FLOOD ZONE


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LEGEND

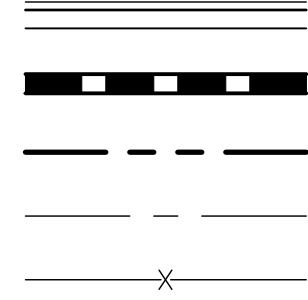
SITE



EROSION CONTROL

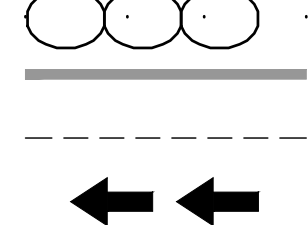

GRADING

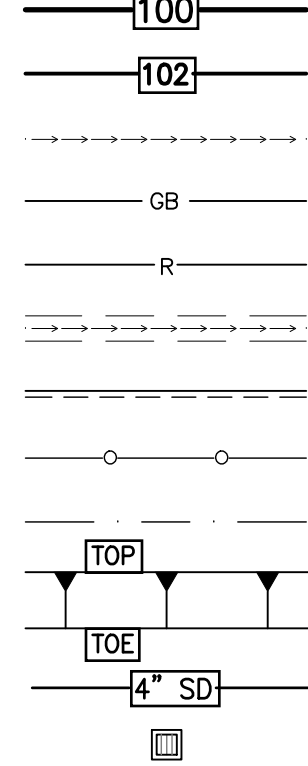

ESTIMATED EARTHWORK QUANTITIES

CUT:	1,842 CUBIC YARDS
FILL:	85 CUBIC YARDS
<b>NET (FILL/IMPORT):</b>	<b>1,757 CUBIC YARDS</b>
REMOVAL AND RECOMPACTION	1,097 CUBIC YARDS

EARTHWORK CALCULATION NOTES:

- THE ESTIMATED QUANTITIES PROVIDED ABOVE ARE TO BE USED FOR JURISDICTIONAL PLAN CHECKING AND PERMITTING PURPOSES ONLY.
- ESTIMATED EARTHWORK ABOVE IS BASED ON DESIGN FINISH GRADES TO EXISTING GRADES AND/OR CONTOURS AS PROVIDED ON THE BASE SURVEY. THE ESTIMATED EARTHWORK DOES NOT ACCOUNT FOR THE THICKNESS OF PAVEMENTS, FOUNDATIONS AND SLABS ON GRADE, FOOTINGS, CLEARING AND GRUBBING, OVER EXCAVATION AND RECOMPACTION, AND CONSTRUCTION MEANS AND METHODS.
- THE ESTIMATED EARTHWORK QUANTITIES DO NOT INCLUDE SHRINKAGE AND/OR EXPANSION FACTORS DUE TO COMPACTION OR OVER EXCAVATION QUANTITIES.
- THE CONTRACTOR SHALL CALCULATE HIS OWN EARTHWORK QUANTITIES NECESSARY FOR HIS BID AND WORK.
- ESTIMATED EARTHWORK QUANTITIES ABOVE ASSUME THAT ALL ONSITE MATERIALS ARE SUITABLE FOR BACKFILLING. HOWEVER, ACTUAL EXISTING ONSITE MATERIALS AND IMPORTED MATERIALS MUST FIRST BE APPROVED BY THE GEOTECHNICAL ENGINEER PRIOR TO INSTALLATION, REMOVAL, REPLACEMENT.

ABBREVIATIONS

AC	ASPHALTIC CONCRETE	MH	MANHOLE
BCR	BEGIN CURVE RETURN	(N)	NORTH
BW	BACK OF WALK	NTS	NOT TO SCALE
BLDG	BUILDING	PA	PLANTER AREA
BM	BENCH MARK	POC	POINT OF CONNECTION
BOS	BOTTOM OF STAIRS	PV	POST INDICATOR VALVE
BMP	BEST MANAGEMENT PRACTICES	PCC	POINT OF COMPOUND CURVE
C&G	CURB AND GUTTER	PRC	POINT OF REVERSE CURVE
CB	CATCH BASIN	PRV	PRESSURE REDUCING VALVE
CI	CAST IRON	PVC	POLYVINYL CHLORIDE
CL	CENTER LINE	R	RADIUS
CMU	CONCRETE MASONRY UNIT	RCIP	RECTANGULAR CAST IRON PIPE
CO	CLEANOUT	RD	ROOF DRAIN
CONC	PORTLAND CEMENT CONCRETE	RW	RIGHT-OF-WAY
CF	CURB FACE	(S)	SOUTH
DW	DOMESTIC WATER	S=	SLOPE EQUALS
(E)	EAST	SD	STORM DRAIN
ECR	END CURVE RETURN	SL	STREET LIGHT
EG	EDGE OF GUTTER	SSMH	SANITARY SEWER MANHOLE
EL, OR ELEV	ELEVATION	SS	SANITARY SEWER
ELEC	ELECTRIC, ELECTRICAL	STD	STANDARD
EM	ELECTRICAL METER	SDMH	STORM DRAIN MANHOLE
EX, OR EXIST.	EXISTING	TC	TOP OF CURB
FDC	FIRE DEPARTMENT CONNECTION	TEL	TELEPHONE
FF	FINISHED FLOOR	TG	TOP OF GRATE
FG	FINISHED GRADE (LANDSCAPE)	TOS	TOP OF STAIRS
FS	FINISHED SURFACE (HARDSCAPE)	TW	TOP OF WALL
FH	FIRE HYDRANT	TS	TRAFFIC SIGNAL
FL	FLOW LINE	TSB	TRAFFIC SIGNAL BOX
FT	FOOT OR FEET	TYP	TYPICAL
FU	FIXTURE UNITS	TV	TELEVISION
FW	FIRE WATER	VF	VERIFY IN FIELD
GPM	GALLONS PER MINUTE	VLT	VAULT
GV	GATE VALVE	VCP	VITRIFIED CLAY PIPE
HDPE	HIGH DENSITY POLYETHYLENE	(N)	WEST
HP	HIGH POINT	W	WATER
INV.	INVERT	WM	WATER METER
LP	LOW POINT	WV	WATER VALVE
MAX	MAXIMUM		
MIN	MINIMUM		

PROJECT DIRECTORY

**ARCHITECT:**  
PAUL MURDOCH ARCHITECTS  
6310 SAN VICENTE BLVD  
SUITE 400  
LOS ANGELES, CA 90048  
CONTACT: PAUL MURDOCH  
TEL: 310.358.0993, EXT. 1

**CIVIL ENGINEER:**  
LABIS FUNK & ASSOCIATES  
319 MAIN STREET  
EL SEGUNDO, CA 90245  
CONTACT: FRANK LAROCCA  
TEL: 213.239.9700, EXT. 150

**GEOTECHNICAL ENGINEER:**  
CONVERSE CONSULTANTS  
717 SOUTH MYRTLE AVE  
MONROVIA, CA 91016  
TEL: 626.930.1200

GEOTECHNICAL ENGINEER'S STATEMENT

THIS PLAN HAS BEEN REVIEWED AND CONFORMS TO RECOMMENDATIONS OF SOILS ENGINEERING/GEOLOGIC REPORT DATED MAY 27, 2022 BY CONVERSE CONSULTANTS.

SIGNATURE \_\_\_\_\_ DATE \_\_\_\_\_ STAMP \_\_\_\_\_

SHEET INDEX

C000	TITLE SHEET
C100	DEMOLITION AND EROSION CONTROL PLAN
C200	ROUGH GRADING PLAN
C201	ROUGH GRADING SECTIONS
C210	GRADING AND DRAINAGE PLAN
C300	LOW IMPACT DEVELOPMENT PLAN
C400	UTILITY PLAN



PAUL MURDOCH  
ARCHITECTS

6310 SAN VICENTE BLVD, SUITE 400  
LOS ANGELES, CA 90048  
T. 310.358-0993

THE DRAWINGS AND SPECIFICATIONS AND REVISIONS, DESIGNS AND ARRANGEMENTS REPRESENTED THEREBY ARE AND SHALL REMAIN THE PROPERTY OF THE ARCHITECT, AND NO PART THEREOF SHALL BE COPIED, REPRODUCED, OR USED IN CONNECTION WITH ANY WORK OR PROJECT OTHER THAN THAT SPECIFICALLY AUTHORIZED BY THE ARCHITECT. VISUAL CONTACT WITH THESE DRAWINGS OR SPECIFICATIONS SHALL CONSTITUTE CONCLUSIVE EVIDENCE OF ACCEPTANCE OF THESE RESTRICTIONS. WRITTEN DIMENSIONS ON THESE DRAWINGS SHALL HAVE PRECEDENCE OVER SCALED DIMENSIONS. CONTRACTORS SHALL VERIFY AND BE RESPONSIBLE FOR ALL DIMENSIONS AND CONDITIONS ON THE JOB AND THIS OFFICE MUST BE NOTIFIED OF ANY VARIATIONS FROM THE DIMENSIONS AND CONDITIONS SHOWN BY THESE DRAWINGS. SHOP DETAILS MUST BE SUBMITTED TO THIS OFFICE FOR REVIEW BEFORE PROCEEDING WITH FABRICATION.



319 Main Street  
El Segundo, California 90245  
1-213-239-9700  
LFA Job No. 23798

NO. DATE REVISION

**allcove**  
BEACH CITIES  
HEALTH DISTRICT

**100% PRELIMINARY  
DESIGN SUBMITTAL**

PMA PROJECT NO.

23007

DRAWING TITLE

**TITLE SHEET**

SCALE

PER PLAN

DATE

02/28/2024

DRAWN

I.S.

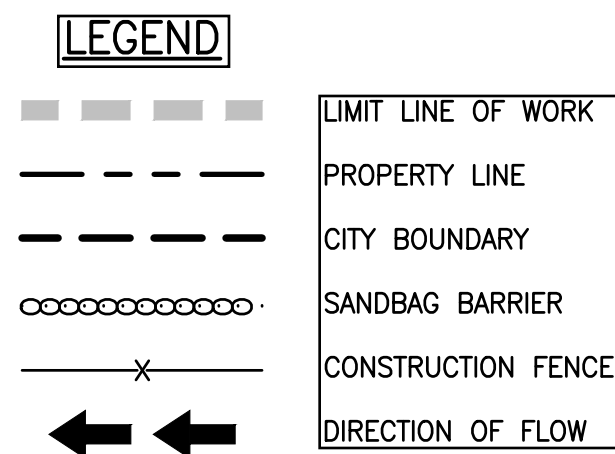
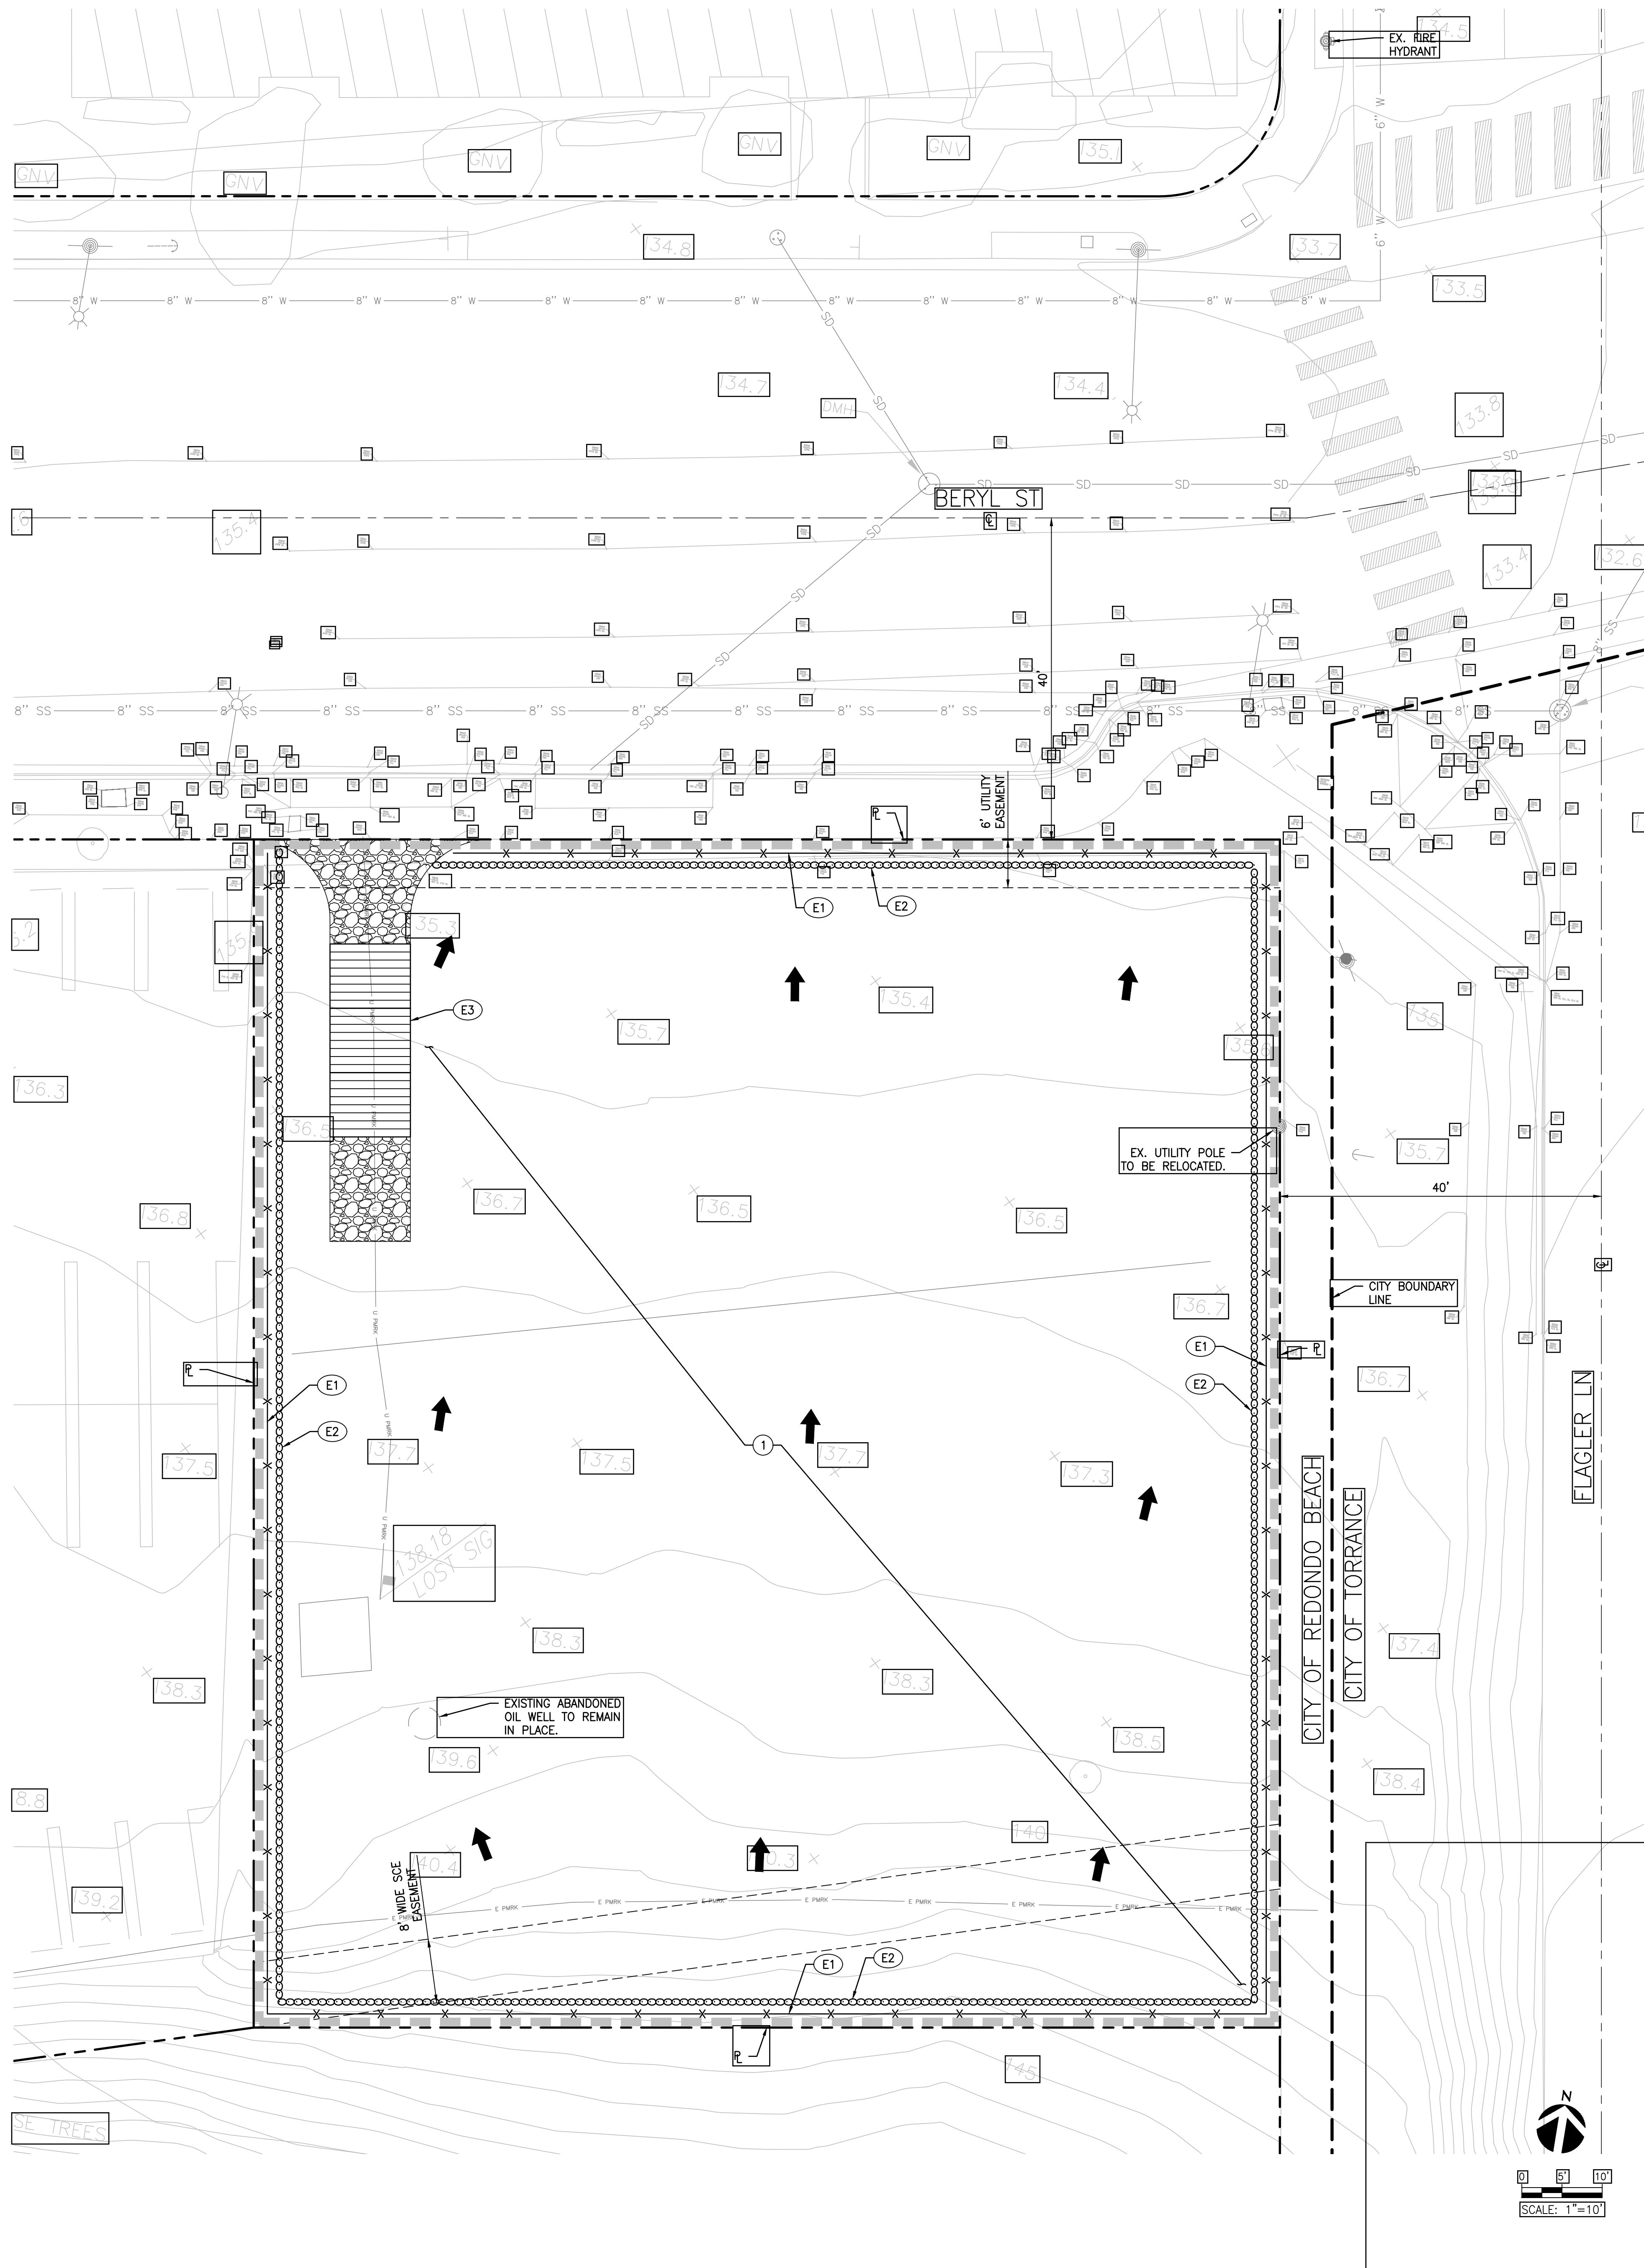
SHEET NO.

**C000**

**1-800-227-2600**  
CALL USA/SC FOR  
UNDERGROUND LOCATING  
48 HOURS BEFORE YOU  
DIG!

**IMPORTANT NOTICE!**  
SECTION 4216/4217 OF THE GOVERNMENT CODE  
REQUIRES A DIGALERT IDENTIFICATION NUMBER  
BE ISSUED BEFORE A "PERMIT TO EXCAVATE"  
WILL BE VALID. FOR YOUR DIGALERT I.D.  
NUMBER CALL UNDERGROUND SERVICE ALERT  
TOLL FREE 1-800-227-2600 TWO WORKING  
DAYS BEFORE YOU DIG





- EROSION CONTROL NOTES**
- (E1) PLACE TEMPORARY CONSTRUCTION FENCE.
  - (E2) PLACE GRAVEL BAGS TRIPLE ROW PER DETAIL 1, HEREON.
  - (E3) POSSIBLE STABILIZED CONSTRUCTION ENTRANCE LOCATION PER DETAIL 2, HEREON.

- DEMOLITION NOTES**
- (D) SEE GENERAL DEMOLITION NOTES HEREON.

**BMP NOTES**

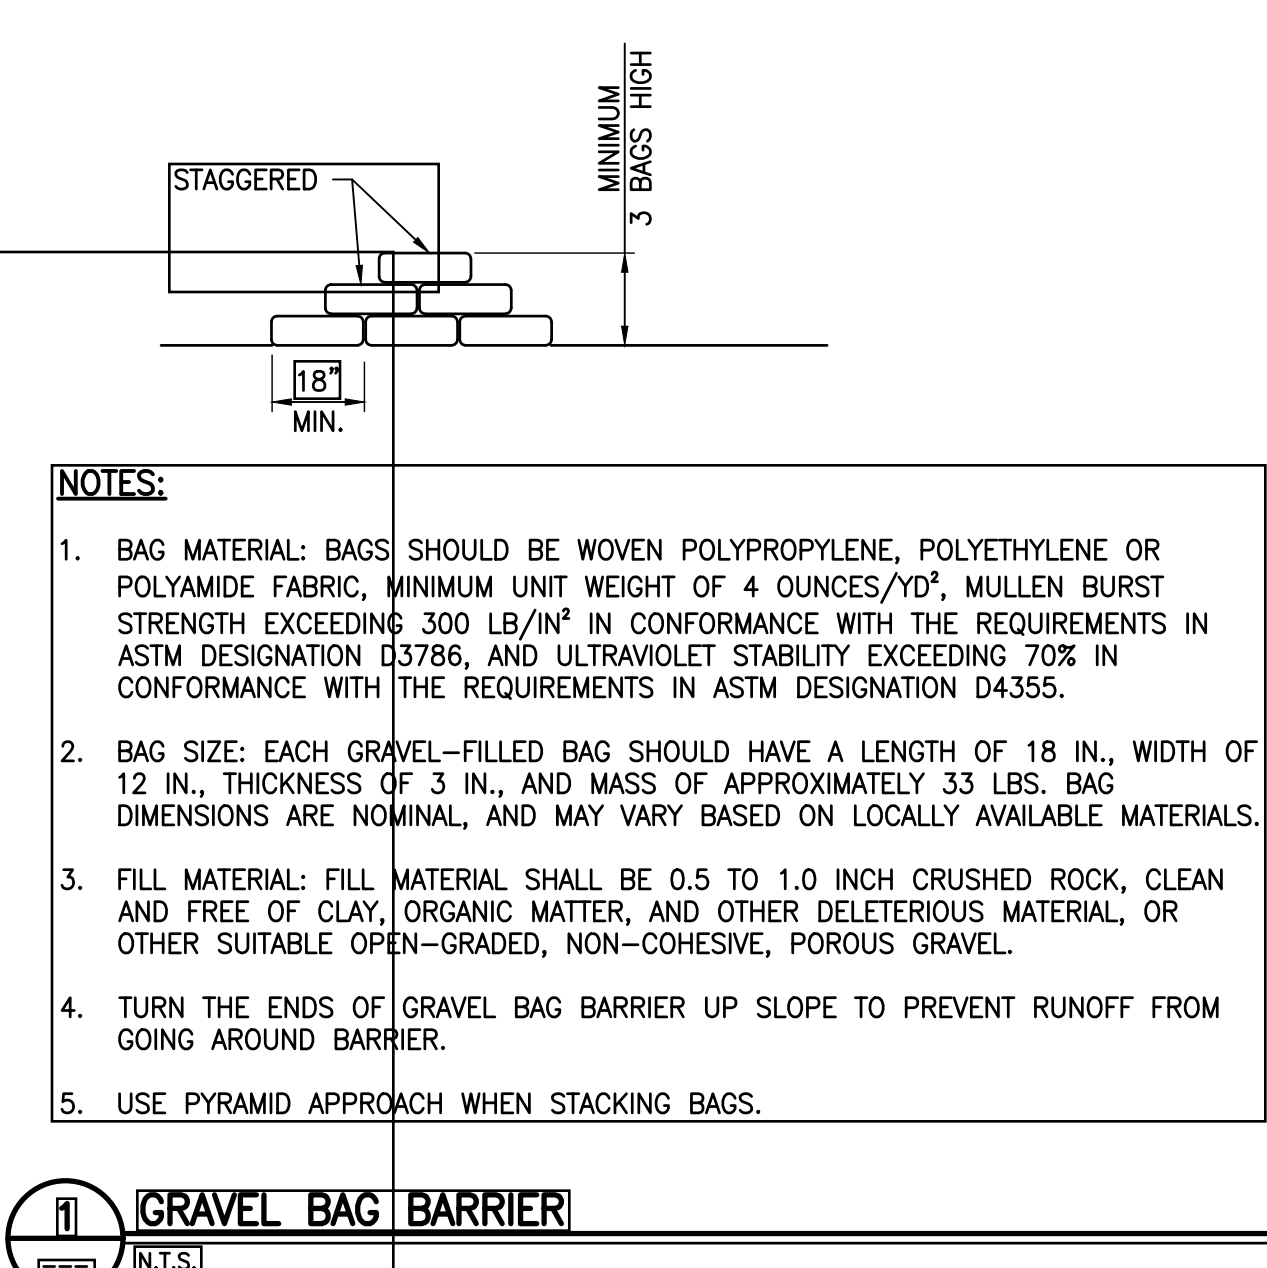
THE FOLLOWING BMPs AS OUTLINED IN, BUT NOT LIMITED TO, THE BEST MANAGEMENT PRACTICE HANDBOOK, CALIFORNIA STORMWATER QUALITY TASK FORCE, SACRAMENTO, CALIFORNIA, JULY 2012, MAY APPLY DURING THE CONSTRUCTION OF THIS PROJECT (ADDITIONAL MEASURES MAY BE REQUIRED IF DEEMED APPROPRIATE BY CITY INSPECTORS):

- EROSION CONTROL**
- EC1-SCHEDULING
  - EC2-PRESERVATION OF EXISTING VEGETATION
  - EC3-HYDRAULIC MULCH
  - EC4-HYDROSEEDING
  - EC5-SOIL BINDERS
  - EC6-STRAW MULCH
  - EC7-GEOTEXTILES AND MATS
  - EC8-WOOD MULCHING
  - EC9-EARTH DIKES AND DRAINAGE SWALES
  - EC10-VELOCITY DISSIPATION DEVICES
  - EC11-SLOPE DRAINS
  - EC12-STREAMBANK STABILIZATION
  - EC13-RESERVED
  - EC14-COMPOST BLANKET
  - EC15-SOIL PREPARATION/ROUGHENING
  - EC16-NON-VEGETATIVE STABILIZATION
- TEMPORARY SEDIMENT CONTROL**
- SE1-SILT FENCE
  - SE2-SEDIMENT BASIN
  - SE3-SEDIMENT TRAP
  - SE4-CHECK DAM
  - SE5-FIBER ROLLS
  - SE6-GRAVEL BAG BERM
  - SE7-STREET SWEEPING AND VACUUMING
  - SE8-SANDBAG BARRIER
  - SE9-STRAW BALE BARRIER
  - SE10-STORM DRAIN INLET PROTECTION
  - SE11-ACTIVE TREATMENT SYSTEMS
  - SE12-MANUFACTURED LINEAR SEDIMENT CONTROLS
  - SE13-COMPOST SOCKS AND BERMS
  - SE14-BIOFILTER BAGS

- EQUIPMENT TRACKING CONTROL**
- TC1-STABILIZED CONSTRUCTION ENTRANCE/EXIT
  - TC2-STABILIZED CONSTRUCTION ROADWAY
  - TC3-ENTRANCE/OUTLET TIRE WASH

- WIND EROSION CONTROL**
- WE1-WIND EROSION CONTROL
- NON-STORMWATER MANAGEMENT**
- NS1-WATER CONSERVATION PRACTICES
  - NS2-DEWATERING OPERATIONS
  - NS3-PAVING AND GRINDING OPERATIONS
  - NS4-TEMPORARY STREAM CROSSING
  - NS5-CLEAR WATER DIVERSION
  - NS6-ILLUICIT CONNECTION/DISCHARGE
  - NS7-POTABLE WATER/IRRIGATION
  - NS8-VEHICLE AND EQUIPMENT FUELING
  - NS9-VEHICLE AND EQUIPMENT FUELING
  - NS10-VEHICLE AND EQUIPMENT MAINTENANCE
  - NS11-PILE DRIVING OPERATIONS
  - NS12-CONCRETE CURING
  - NS13-CONCRETE FINISHING
  - NS14-MATERIAL OVER WATER
  - NS15-DEMOLITION ADJACENT TO WATER
  - NS16-TEMPORARY BATCH PLANTS


- WASTE MANAGEMENT & MATERIALS POLLUTION CONTROL**
- WM1-MATERIAL DELIVERY AND STORAGE
  - WM2-MATERIAL USE
  - WM3-STOCKPILE MANAGEMENT
  - WM4-SPILL PREVENTION AND CONTROL
  - WM5-SOLID WASTE MANAGEMENT
  - WM6-HAZARDOUS WASTE MANAGEMENT
  - WM7-CONTAMINATED SOIL MANAGEMENT
  - WM8-CONCRETE WASTE MANAGEMENT
  - WM9-SANITARY/SEPTIC WASTE MANAGEMENT
  - WM10-LIQUID WASTE MANAGEMENT



- EROSION CONTROL NOTES**
- TEMPORARY EROSION CONTROL DEVICES SHOWN ON THE GRADING PLAN WHICH INTERFERE WITH THE WORK SHALL BE RELOCATED OR MODIFIED AS AND WHEN THE INSPECTOR SO DIRECTS AS THE WORK PROGRESSES TO MEET "AS GRADED" CONDITIONS.
  - ALL LOOSE SOIL AND DEBRIS SHALL BE REMOVED FROM THE STREET AREAS UPON STARTING OPERATIONS AND PERIODICALLY THEREAFTER AS DIRECTED BY THE INSPECTOR.
  - WHEN THE INSPECTOR SO DIRECTS, A 12-INCH BERM SHALL BE MAINTAINED ALONG THE TOP OF THE SLOPE OF THOSE FILLS ON WHICH GRADING IS NOT IN PROGRESS.
  - STORM AND SEWER DRAIN TRENCHES THAT ARE CUT THROUGH BASIN DIKES OR BASIN INLET DIKES SHALL BE PLUGGED WITH SANDBAGS.
  - EXCEPT WHEN THE INSPECTOR DIRECTS OTHERWISE, ALL DEVICES SHOWN SHALL BE IN PLACE AT THE END OF EACH WORKING DAY WHEN RAIN IS FORECAST, AND SHALL BE MAINTAINED DURING THE RAINY SEASON (OCTOBER 15 TO APRIL 15).
  - SANDBAGS SHALL BE STOCKPILED ON SITE, READY TO BE PLACED IN POSITION WHEN RAIN IS FORECAST, OR WHEN THE INSPECTOR SO DIRECTS.
  - A "STANDBY EMERGENCY CREW" SHALL BE ALERTED BY THE PERMITTEE OR THE CONTRACTOR TO PERFORM EMERGENCY WORK DURING RAINSTORMS. THE PARTY TO BE CONTACTED IS: NAME: (TO BE FILLED IN BY CONTRACTOR) PHONE NUMBER: \_\_\_\_\_

- DUST CONTROL NOTES**
- DUST SHALL BE CONTROLLED BY WATERING AND/OR APPLYING A DUST PALLIATIVE. THE DUST PALLIATIVE SHALL BE APPLIED IN THE AMOUNT AT THE LOCATIONS AS DIRECTED BY THE ENGINEER.
  - WATER FOR DUST CONTROL SHALL BE APPLIED BY MEANS OF PRESSURE TYPE DISTRIBUTORS OR PIPE LINES EQUIPPED WITH A SPRAY SYSTEM OR HOSES WITH NOZZLES THAT WILL INSURE A UNIFORM APPLICATION OF WATER.
  - UNLESS WATER IS APPLIED BY MEANS OF PIPE LINES, AT LEAST ONE MOBILE UNIT WITH A MINIMUM CAPACITY OF 100 GALLONS SHALL BE AVAILABLE FOR APPLYING WATER.
  - ALL SOIL MATERIALS OR DEBRIS TRUCKED FROM THE SITE SHALL BE COVERED AND SPRINKLED PRIOR TO ENTERING PUBLIC STREETS.
  - PROVIDE FOR WET SUPPRESSION OR CHEMICAL STABILIZING OF EXPOSED SOILS.
  - PROVIDE FOR RAPID CLEAN-UP OF SEDIMENTS DEPOSITED ON THE PAVED ROADS.
  - LIMIT THE AMOUNT OF AREAS DISTURBED BY CLEARING & EARTH MOVING OPERATIONS BY SCHEDULING THESE ACTIVITIES IN PHASES.

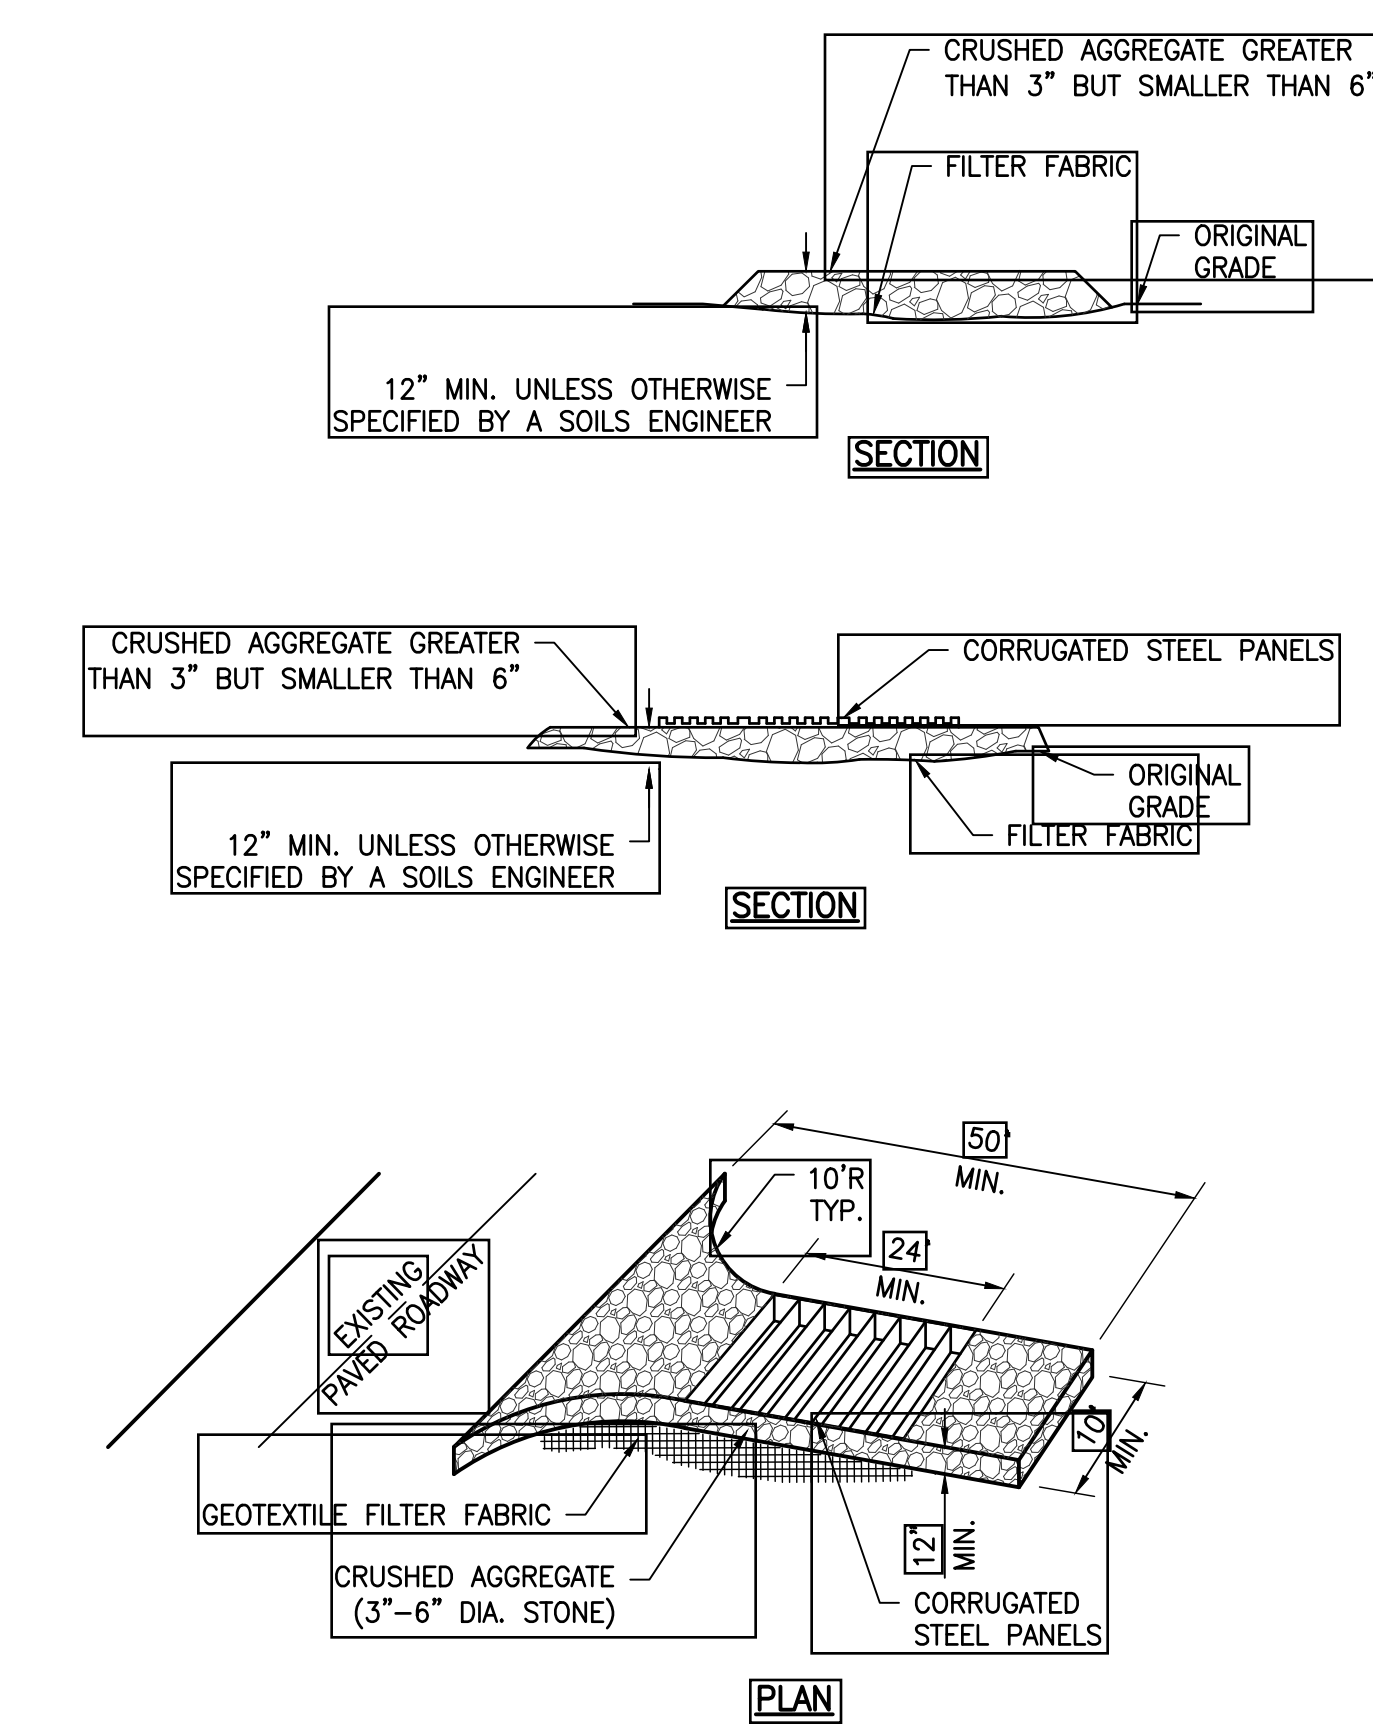- GENERAL DEMOLITION NOTES**
- CONTRACTOR TO CLEAR PROJECT SITE AREA WITHIN THE CONFINES OF THE DEMOLITION LIMIT LINE. THE CONTRACTOR SHALL DEMOLISH AND REMOVE FROM THE SITE ALL EXISTING UTILITIES, STRUCTURES, PLANTERS, TREES, AND ALL OTHER SITE FEATURES, UNLESS OTHERWISE NOTED ON THE PLAN.
  - REMOVAL OF LANDSCAPING SHALL INCLUDE ROOTS AND ORGANIC MATERIALS.
  - THE CONTRACTOR SHALL BE RESPONSIBLE FOR OBTAINING ANY AND ALL PERMITS AND SHALL PAY ALL FEES NECESSARY FOR ENCROACHMENT, GRADING, DEMOLITION AND DISPOSAL OF SAID MATERIALS AS REQUIRED BY PRIVATE, LOCAL AND STATE JURISDICTIONS.
  - THE CONTRACTOR SHALL BE RESPONSIBLE FOR A SITE INSPECTION TO FULLY ACKNOWLEDGE THE EXTENT OF THE DEMOLITION WORK.
  - THE CONTRACTOR SHALL VERIFY AND LOCATE ALL EXISTING ABOVE AND UNDERGROUND UTILITIES. LOCATIONS SHOWN ON THE PLANS ARE APPROXIMATE AND ARE SHOWN FOR GENERAL INFORMATION ONLY.
  - DAMAGE TO ANY EXISTING UTILITIES AND SERVICES TO REMAIN SHALL BE THE RESPONSIBILITY OF THE CONTRACTOR. CONTRACTOR SHALL REPAIR AND/OR REPLACE IN KIND.
  - EROSION CONTROL MEASURES SHALL BE IMPLEMENTED TO PREVENT DEBRIS AND UNSUITABLE MATERIALS FROM ENTERING STORM DRAINS, SANITARY SEWERS AND STREETS.
  - DUST CONTROL SHALL BE IMPLEMENTED DURING DEMOLITION.
  - DEMOLITION IS LIMITED TO WITHIN DEMOLITION LIMIT LINE UNLESS NOTED OTHERWISE.
  - THE CONTRACTOR SHALL VERIFY THE LOCATION AND QUANTITY OF EXISTING SURFACE STRUCTURES AND SHALL BE SOLELY RESPONSIBLE FOR ANY UNIDENTIFIED UTILITIES, IMPROVEMENTS, TREES, ETC. TO BE DEMOLISHED AND REMOVED WITHIN THE DEMOLITION LIMIT LINE, INCLUDING APPURTENANT FOUNDATIONS OR SUPPORTS.
  - DEMOLITION CALLOUTS IN THIS SECTION ARE REPRESENTATIVE OF WHAT IS TO BE DONE, NOT AN ITEMIZED ACCOUNTING FOR EACH PIPE, CATCH BASIN, MANHOLE, VAULT, ETC. THAT IS TO BE DEMOLISHED, REMOVED AND DISPOSED OF.



- NOTES:**
- THE CONSTRUCTION ENTRANCE ROADWAYS SHALL BE STABILIZED SO AS TO PREVENT SEDIMENTS FROM BEING DEPOSITED INTO THE PUBLIC ROADS. DEPOSITIONS MUST BE SWEEPED UP IMMEDIATELY AND MAY NOT BE WASHED DOWN BY RAIN OR OTHER MEANS INTO THE STORM DRAIN SYSTEM.
  - STABILIZED CONSTRUCTION ENTRANCE SHALL BE LOCATED AT ANY POINT WHERE TRAFFIC WILL BE ENTERING OR LEAVING A CONSTRUCTION SITE OR FROM A PUBLIC RIGHT OF WAY, STREET, ALLEY, AND SIDEWALK OR PARKING AREA.
  - IF A WASH RACK IS INCLUDED, A SEDIMENT TRAP OF SOME KIND MUST ALSO BE PROVIDED TO COLLECT WASH WATER RUNOFF.
  - ALL VEHICLES ACCESSING THE CONSTRUCTION SITE SHALL UTILIZE THE STABILIZED CONSTRUCTION ENTRANCE.

- STREET MAINTENANCE NOTES**
- REMOVE ALL SEDIMENT DEPOSITED ON PAVED ROADWAYS IMMEDIATELY.
  - SWEEP PAVED AREAS THAT RECEIVE CONSTRUCTION TRAFFIC WHENEVER SEDIMENT BECOMES VISIBLE.
  - PAVEMENT WASHING WITH WATER IS PROHIBITED IF IT RESULTS IN A DISCHARGE TO THE STORM DRAIN SYSTEM.



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319 Main Street  
El Segundo, California 90245  
T. 213/239-9700  
LFA Job No. 23798

NO. DATE REVISION

**allcove**  
BEACH CITIES  
HEALTH DISTRICT

**100% PRELIMINARY DESIGN SUBMITTAL**

PMA PROJECT NO. 23007

DRAWING TITLE  
**DEMOLITION AND EROSION CONTROL PLAN**

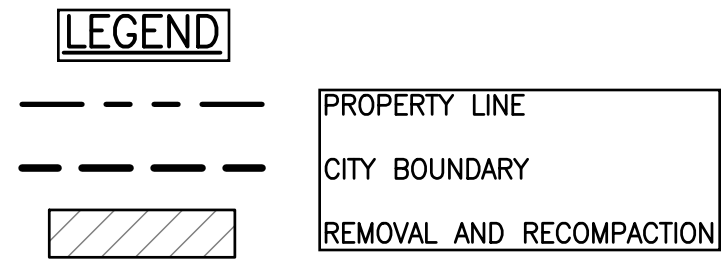
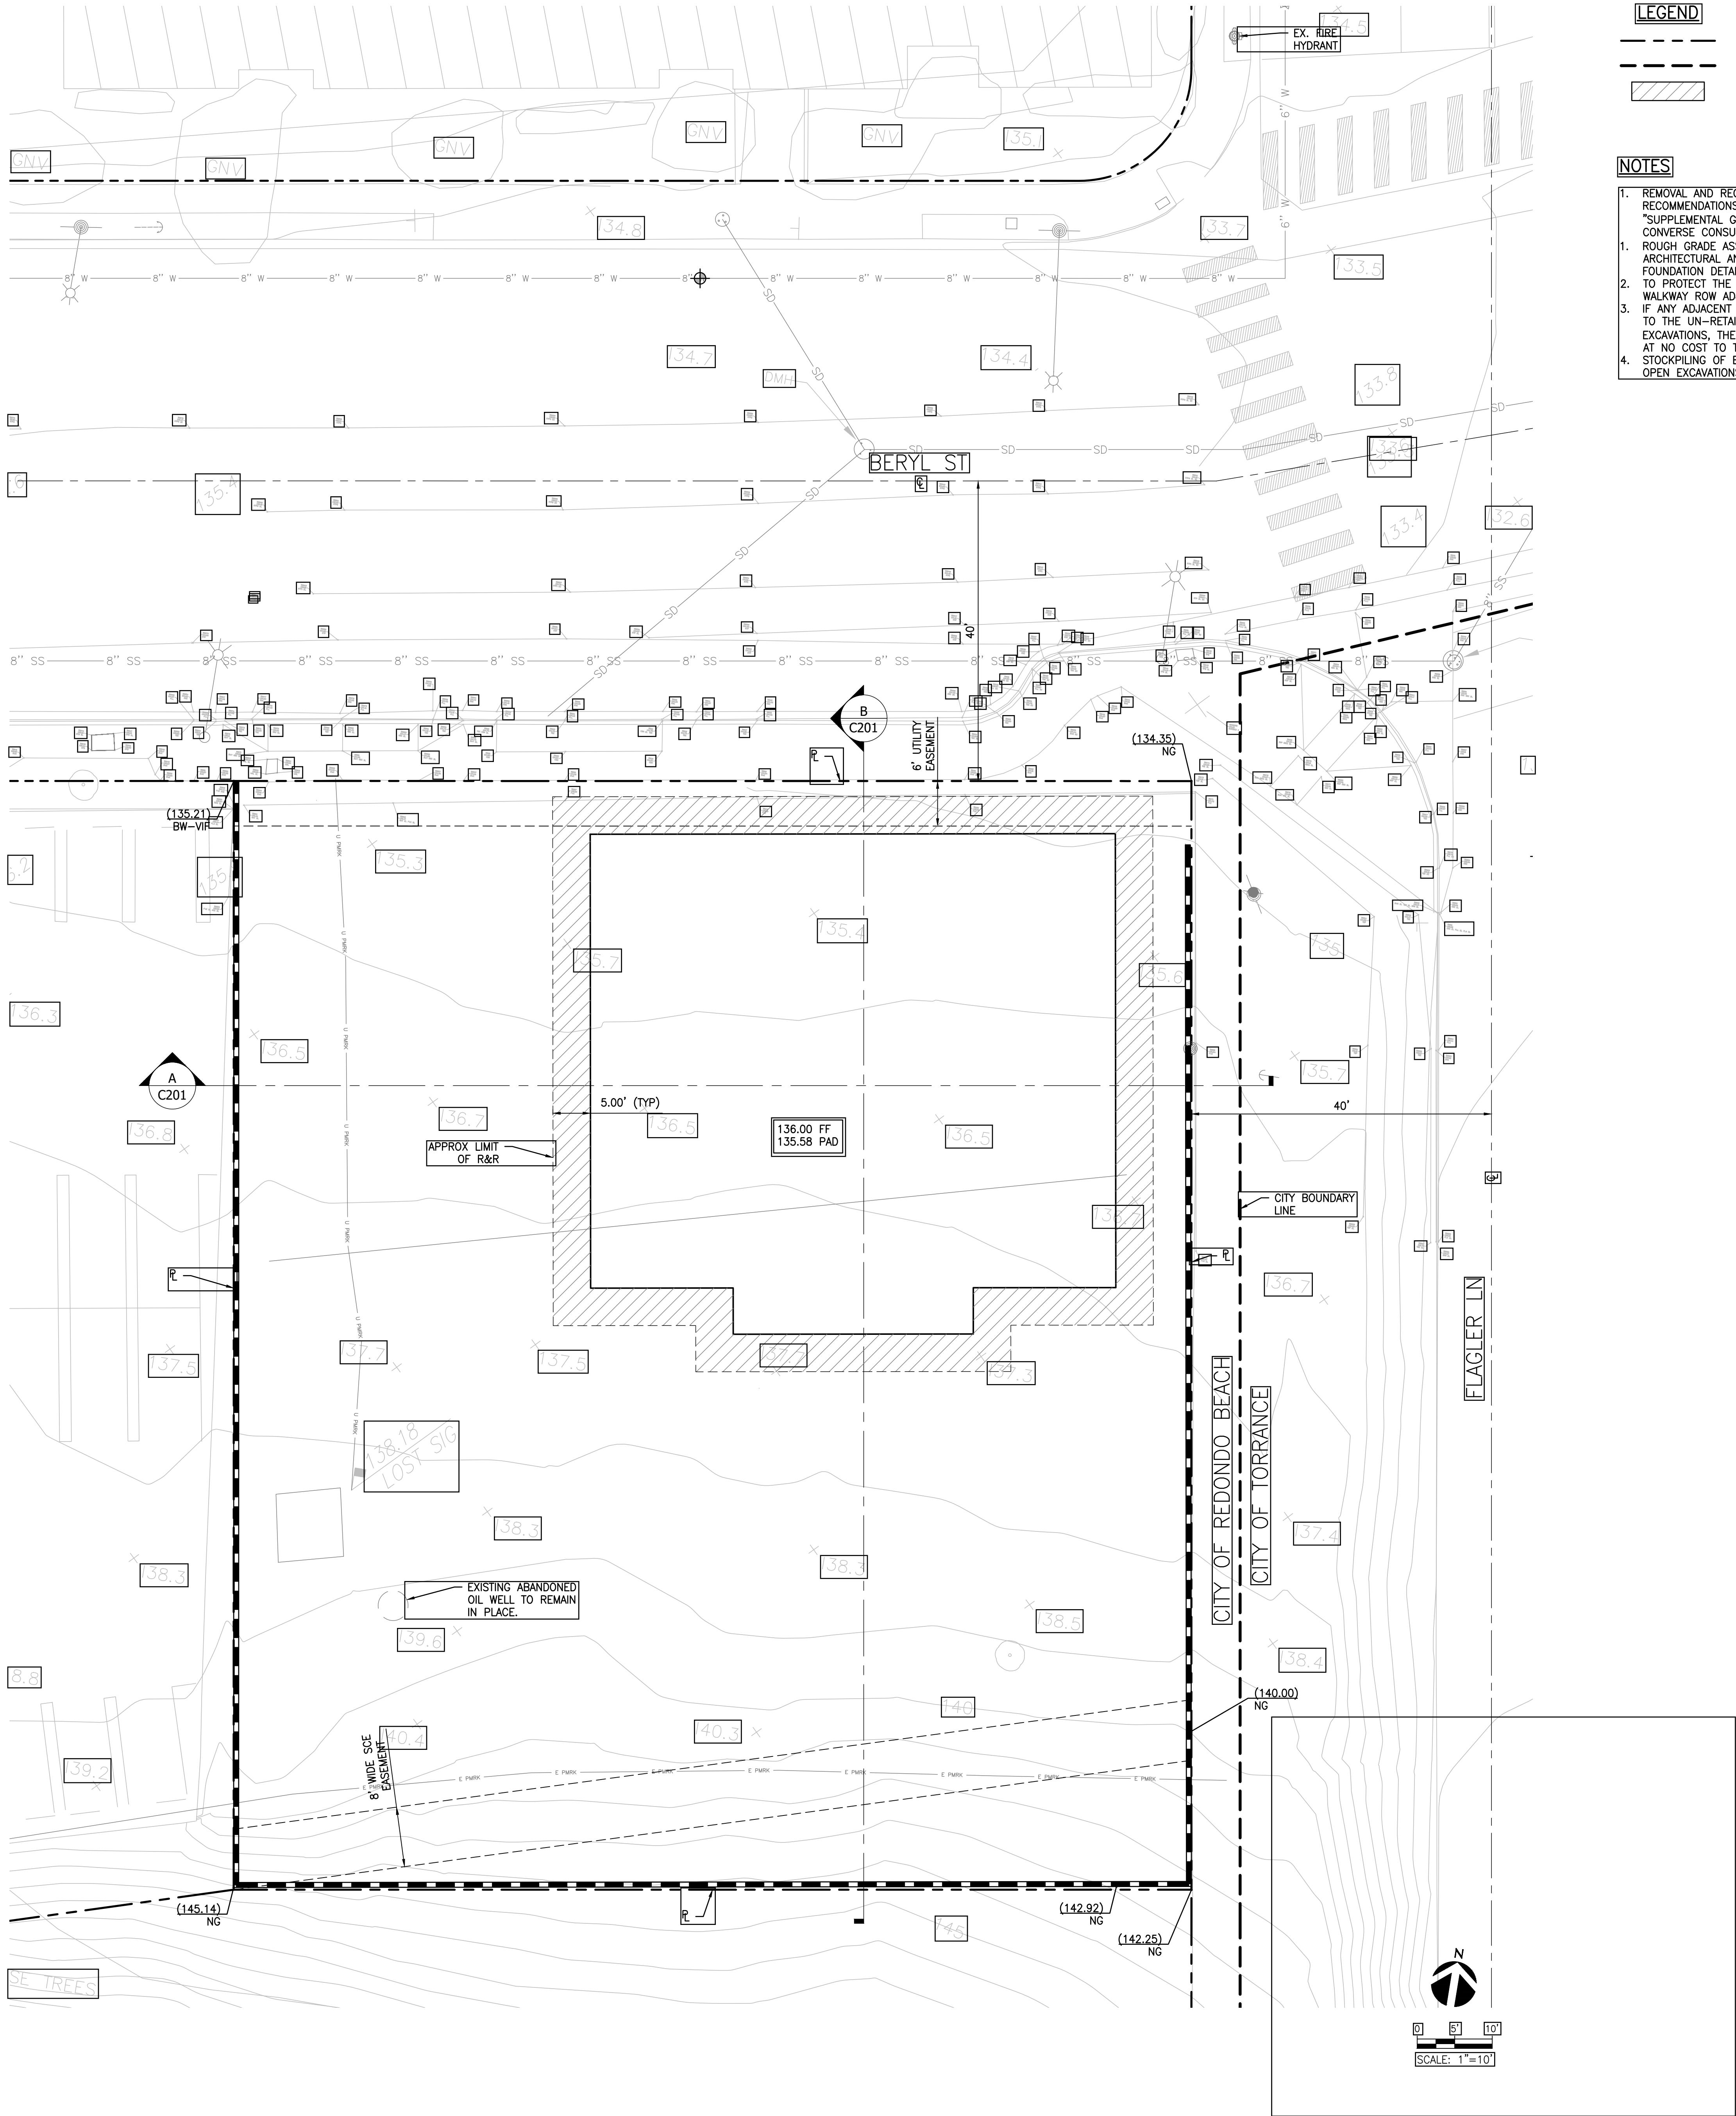
SCALE  
PER PLAN

DATE  
02/28/2024

DRAWN CHECKED  
I.S. F.L.

SHEET NO.  
**C100**







- NOTES**
- REMOVAL AND RECOMPACTION REQUIREMENTS ARE BASED ON THE RECOMMENDATIONS CONTAINED IN THE GEOTECHNICAL INVESTIGATION "SUPPLEMENTAL GEOTECHNICAL STUDY REPORT" DATED MAY 27, 2022 BY CONVERSE CONSULTANTS.
  - ROUGH GRADE ASSUMES PAD IS 5" BENEATH FINISHED FLOOR. SEE ARCHITECTURAL AND STRUCTURAL PLANS FOR FINAL ELEVATIONS AND FOUNDATION DETAILS.
  - TO PROTECT THE PUBLIC, PLEASE PROVIDE PROTECTIVE MEASURES ALONG THE WALKWAY ROW ADJACENT TO SLOT CUTS AND TEMPORARY EXCAVATIONS. IF ANY ADJACENT ROW STRUCTURES AND SUBSTRUCTURES ARE DAMAGED DUE TO THE UN-RETAINED SOILS FROM THE SLOT CUTS AND TEMPORARY EXCAVATIONS, THE DEVELOPING OWNER/CONTRACTOR WILL NEED TO REPAIR IT AT NO COST TO THE CITY OF REDONDO BEACH.
  - STOCKPILING OF EXCAVATED MATERIAL SHALL NOT BE ALLOWED ADJACENT TO OPEN EXCAVATIONS.

**CONSTRUCTION SEQUENCING:**

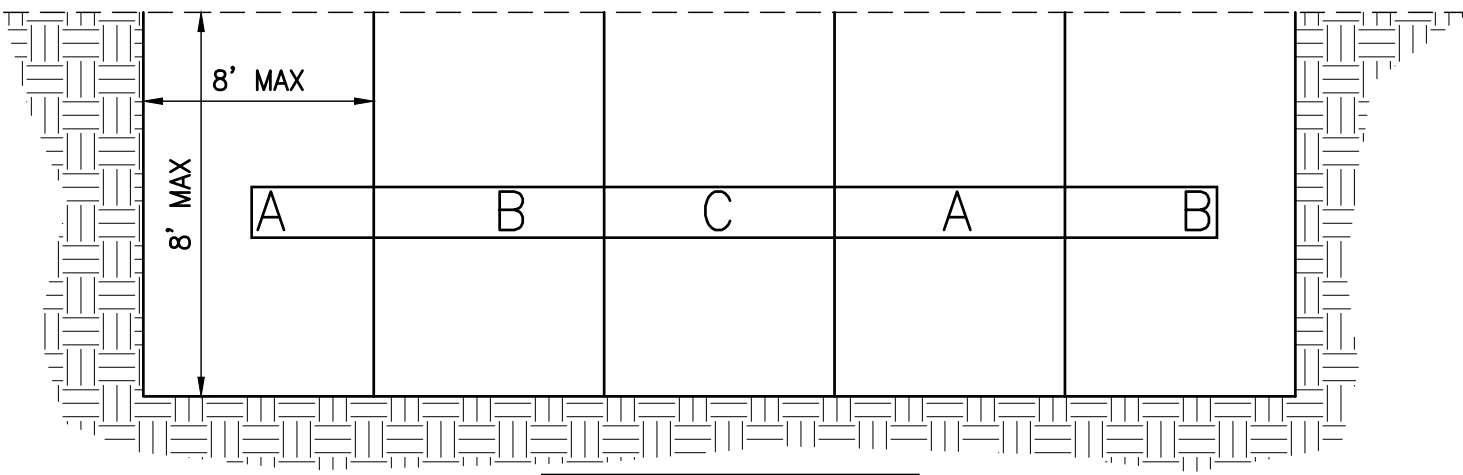
EXCAVATIONS LOCATED ALONG THE PROPERTY LINE MAY BE MADE BY THE SLOT-CUTTING METHOD TO 8 FEET HIGH. THIS METHOD EMPLOYS THE USE OF THE EARTH AS A BUTTRESS AND ALLOWS THE EXCAVATION TO PROCEED IN PHASES. THE INITIAL EXCAVATION IS MADE AT A SLOPE OF 1:1 (H:V). SLOTS ARE CUT, USING THE ABC METHOD, IN WHICH ALL SLOTS ARE OF THE SAME WIDTH. THE INITIAL SLOT "A" IS CUT 8 FEET IN WIDTH, LEAVING THE "B" AND "C" SLOTS TO BUTTRESS THE EXCAVATION. THE "A" SLOT IS BACKFILLED; THE SAME PROCEDURE IS USED FOR THE "B" SLOTS; THEN THE "C" SLOTS.



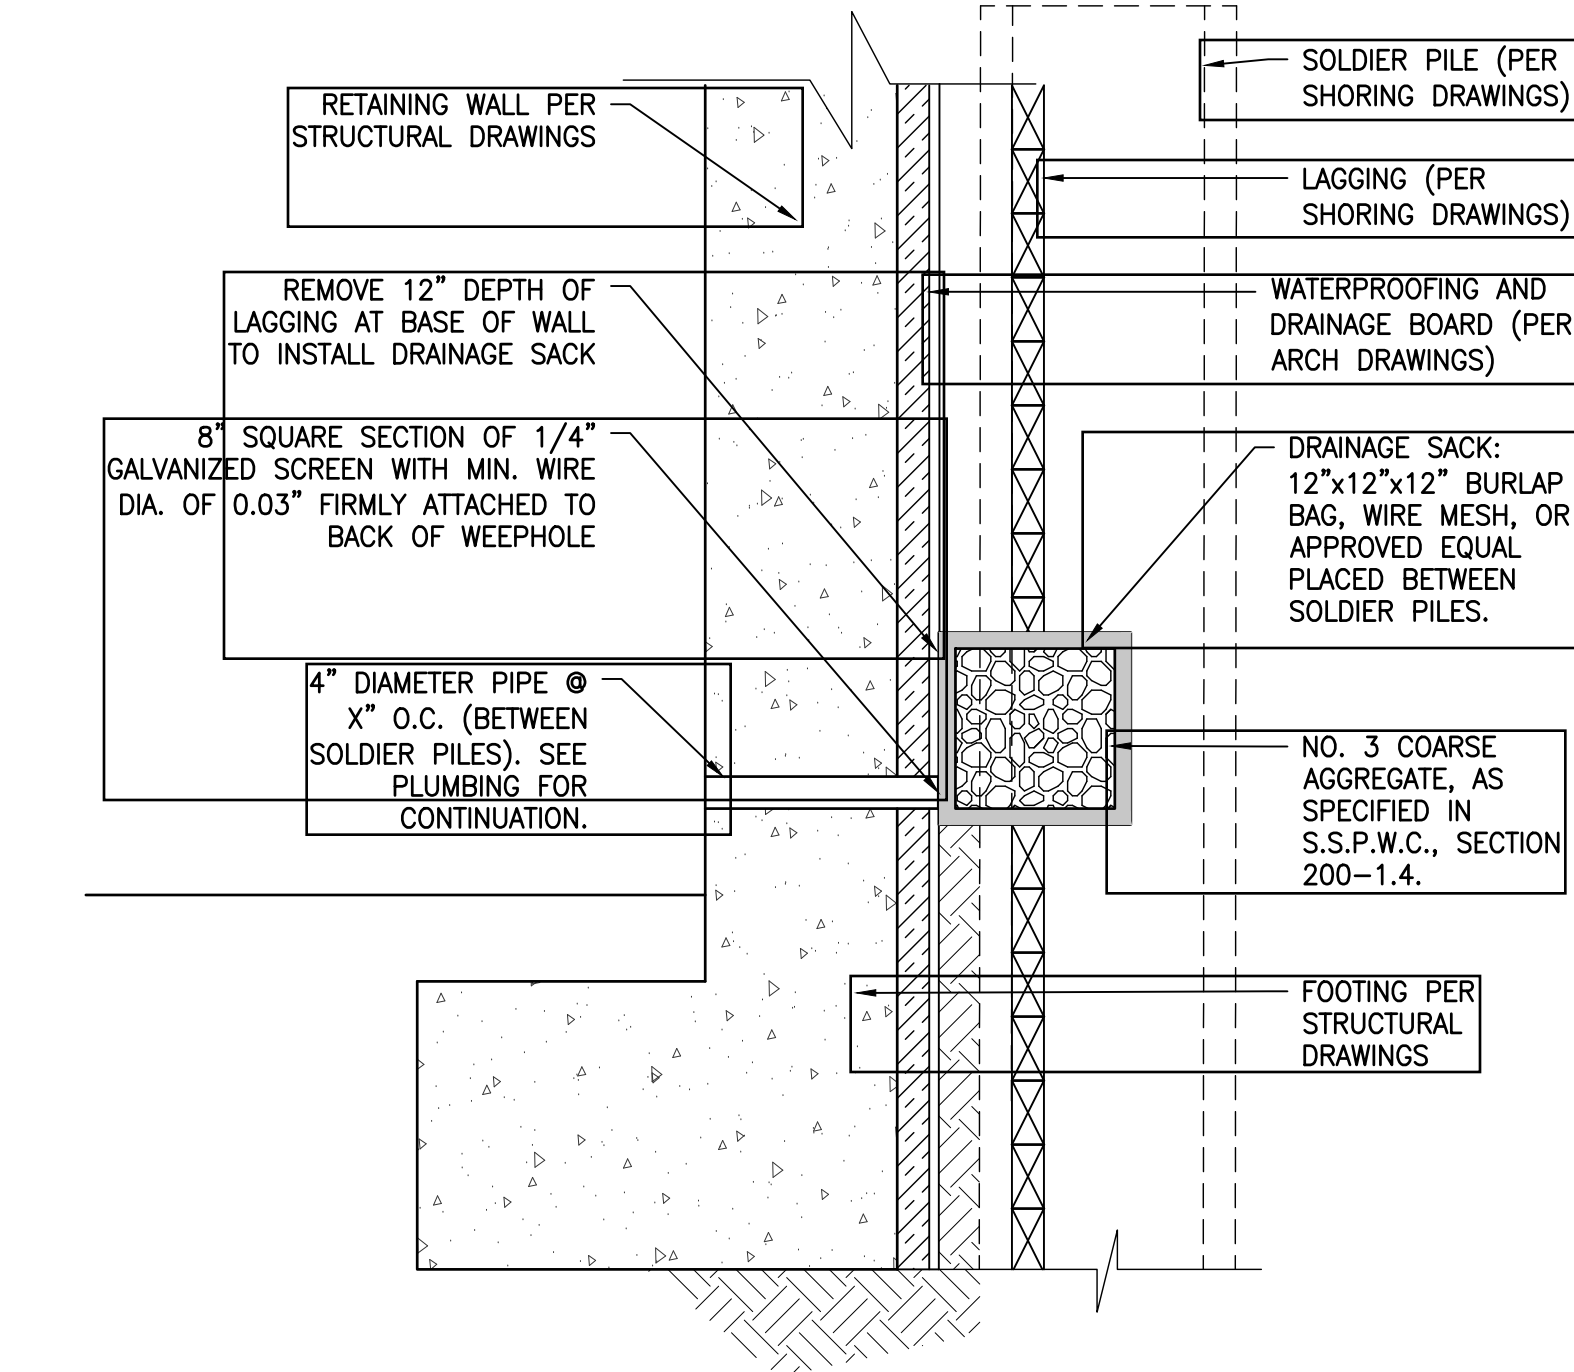- SLOT CUT SEQUENCE (ABC METHOD):**
- EXCAVATE A SLOTS AND BACKFILL COMPLETELY WHILE LEAVING B AND C SLOTS IN PLACE.
  - AFTER A SLOTS ARE FULLY BACKFILLED AND COMPACTED, EXCAVATE B SLOTS AND BACKFILL COMPLETELY WHILE LEAVING A AND C SLOTS IN PLACE.
  - AFTER B SLOTS ARE FULLY BACKFILLED AND COMPACTED, EXCAVATE C SLOTS AND BACKFILL COMPLETELY WHILE LEAVING A AND B SLOTS IN PLACE.



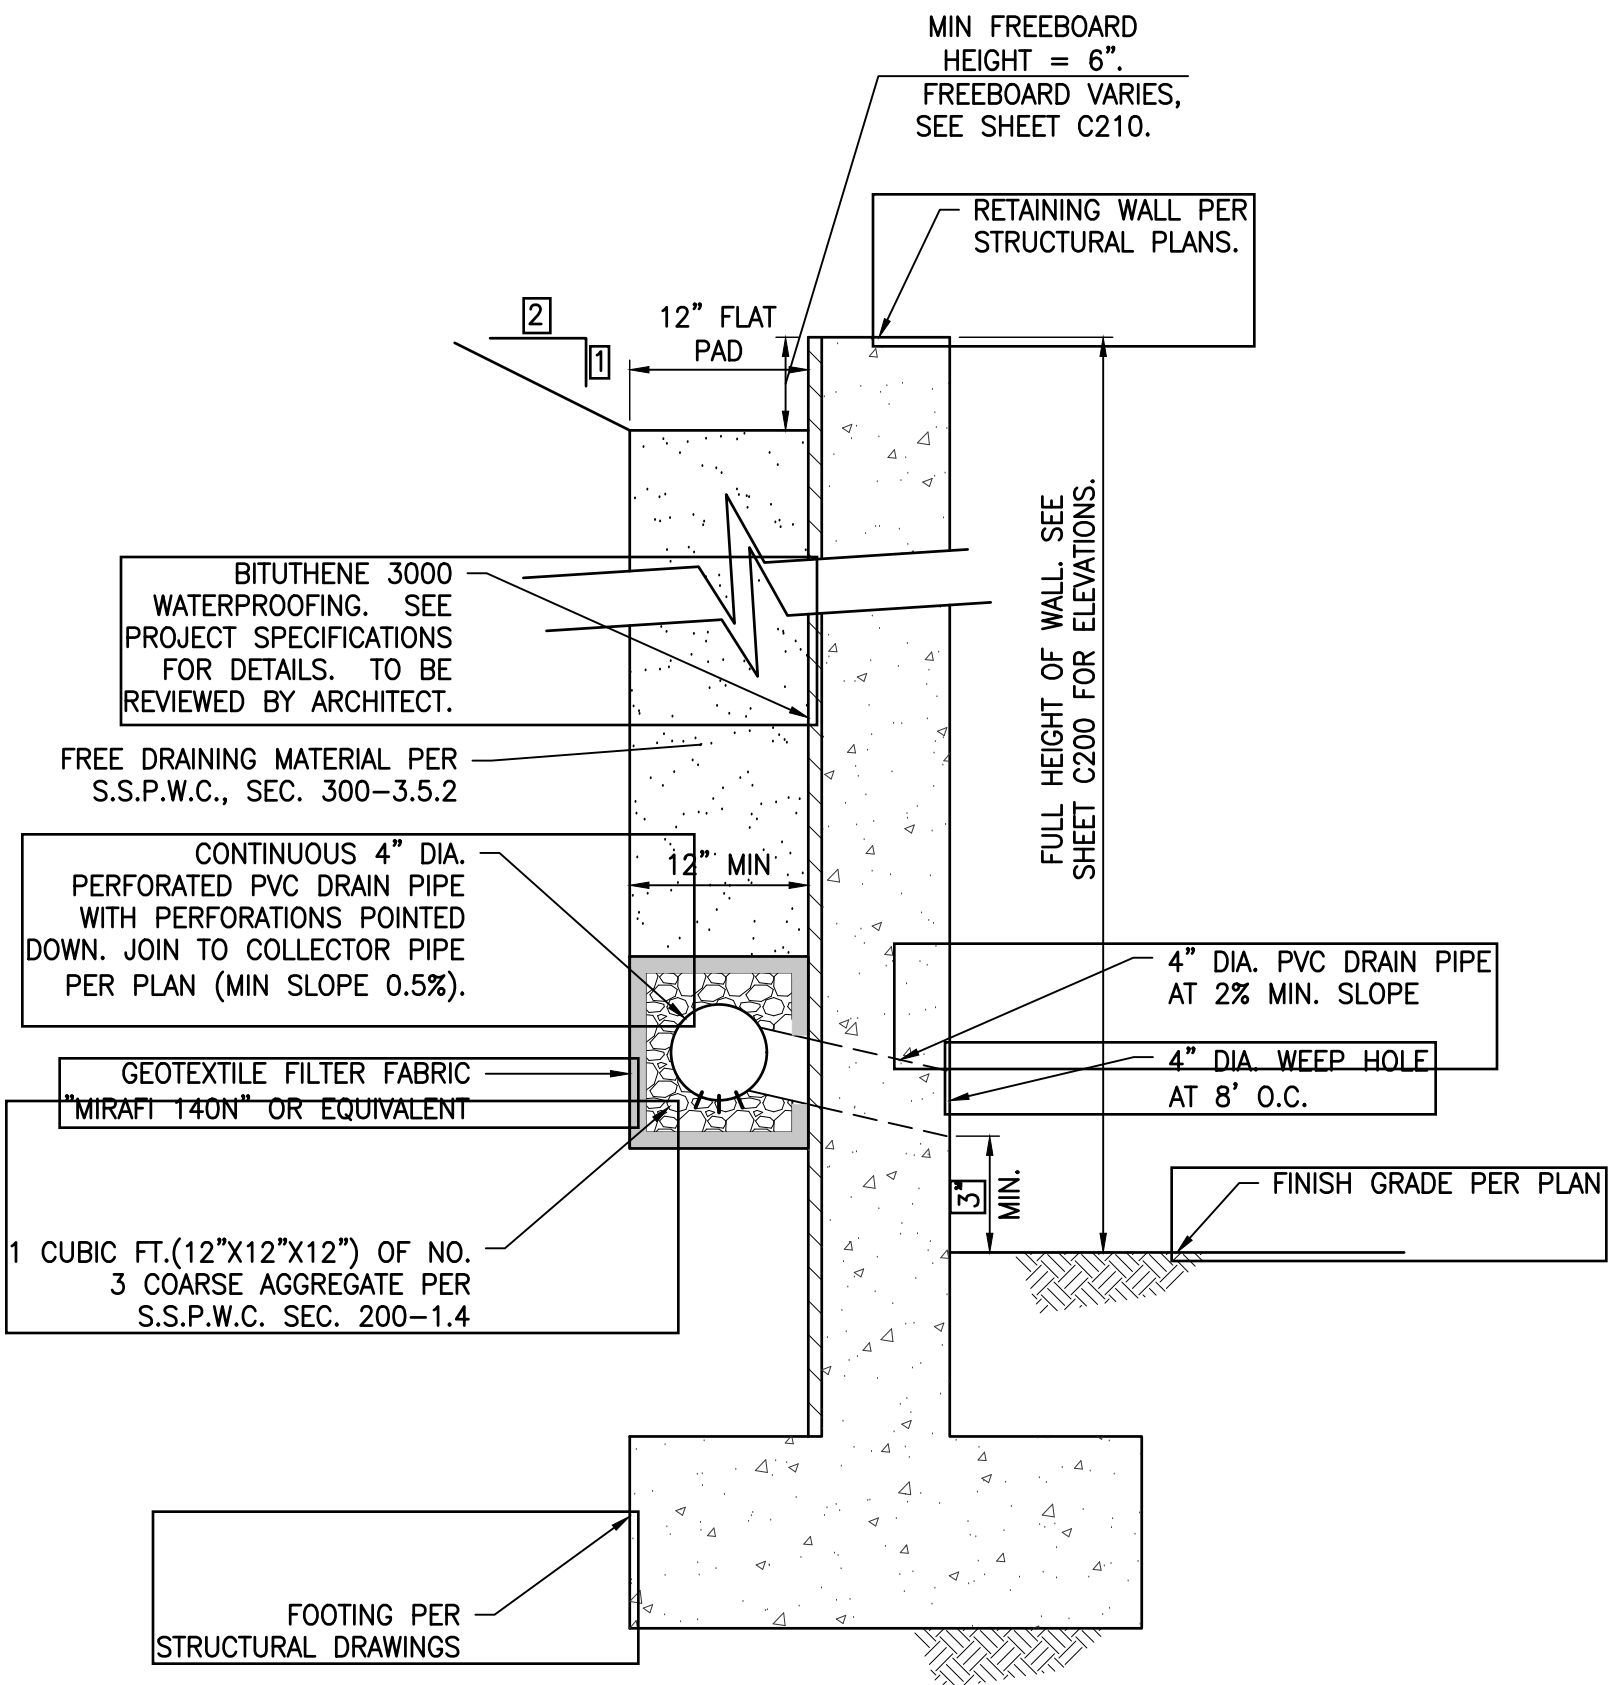- NOTES:**
- FOUNDATION WALL DRAINAGE SHALL ADHERE TO THE LATEST BUILDING ADMINISTRATIVE CODES.
- FOOTING DRAIN DETAIL FOR SHORED CONDITION**



- FOOTING DRAIN DETAIL**

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LFA Job No. 23798

NO. DATE REVISION

**allcove**  
BEACH CITIES  
HEALTH DISTRICT

**100% PRELIMINARY  
DESIGN SUBMITTAL**

PMA PROJECT NO.  
23007

DRAWING TITLE  
**ROUGH GRADING  
PLAN**

SCALE  
PER PLAN


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I.S. F.L.


SHEET NO.

**C200**



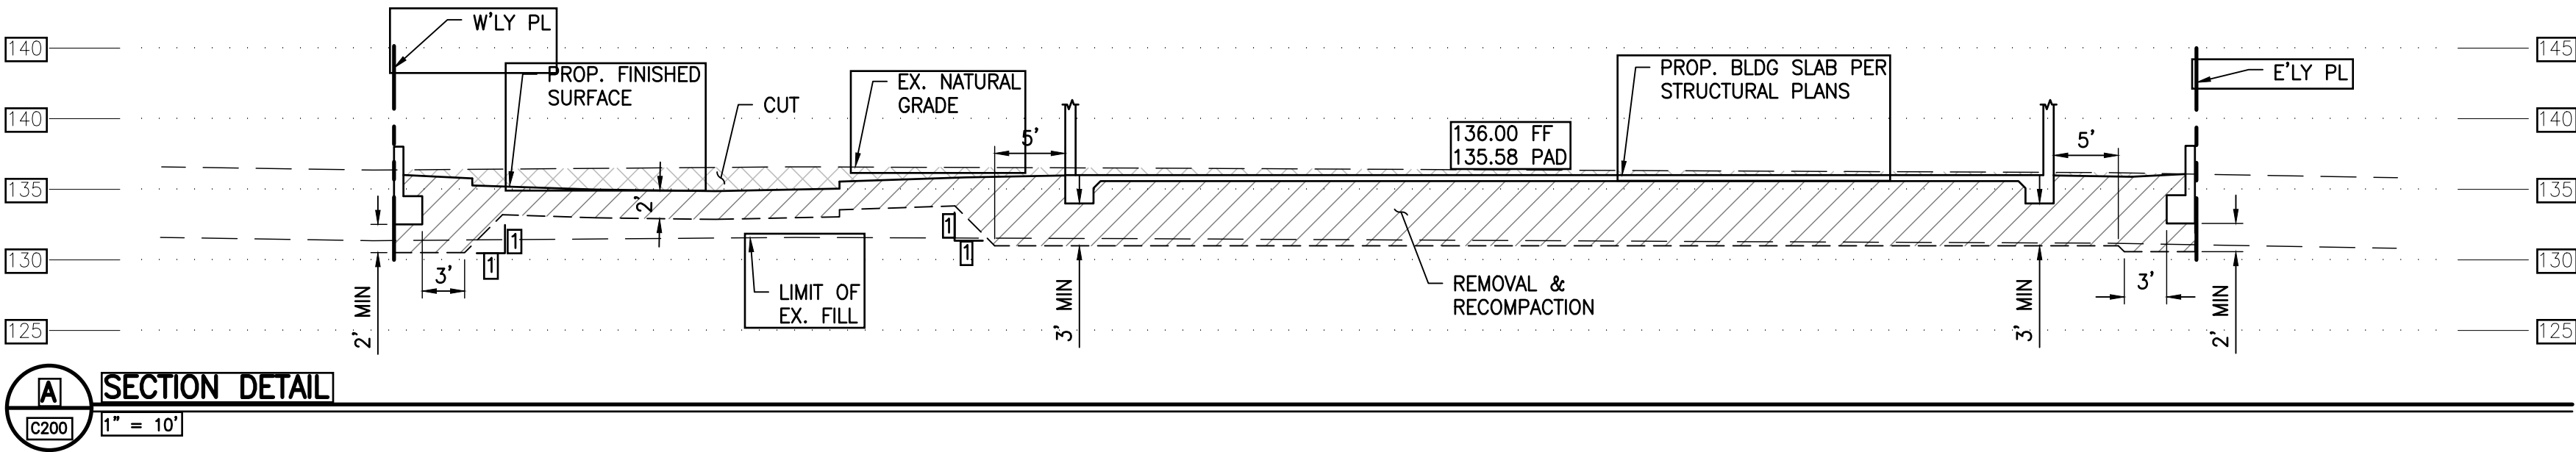

**A** SECTION DETAIL  
(C200) 1" = 10'

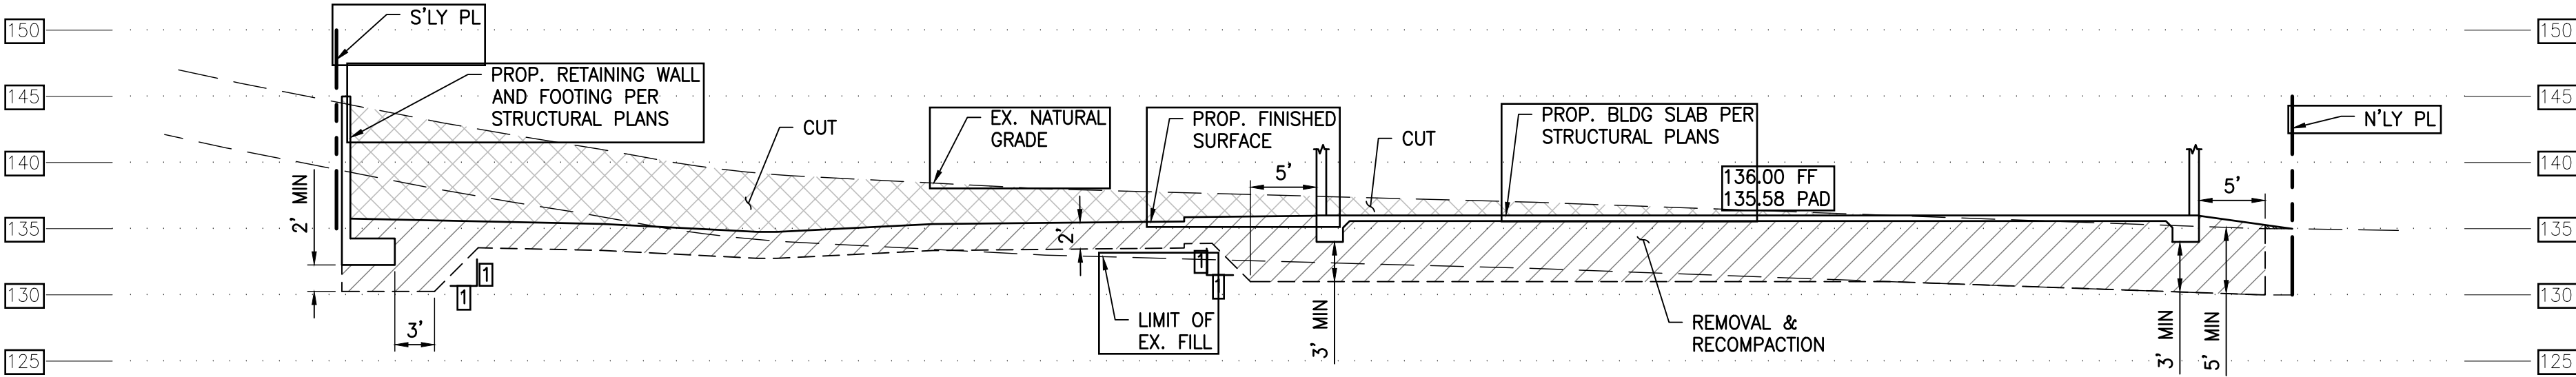

**B** SECTION DETAIL  
(C200) 1" = 10'



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PMA PROJECT NO.

23007

DRAWING TITLE

**ROUGH GRADING  
SECTIONS**

SCALE

PER PLAN

DATE

02/28/2024

DRAWN

CHECKED


I.S.

F.L.

SHEET NO.

**C201**




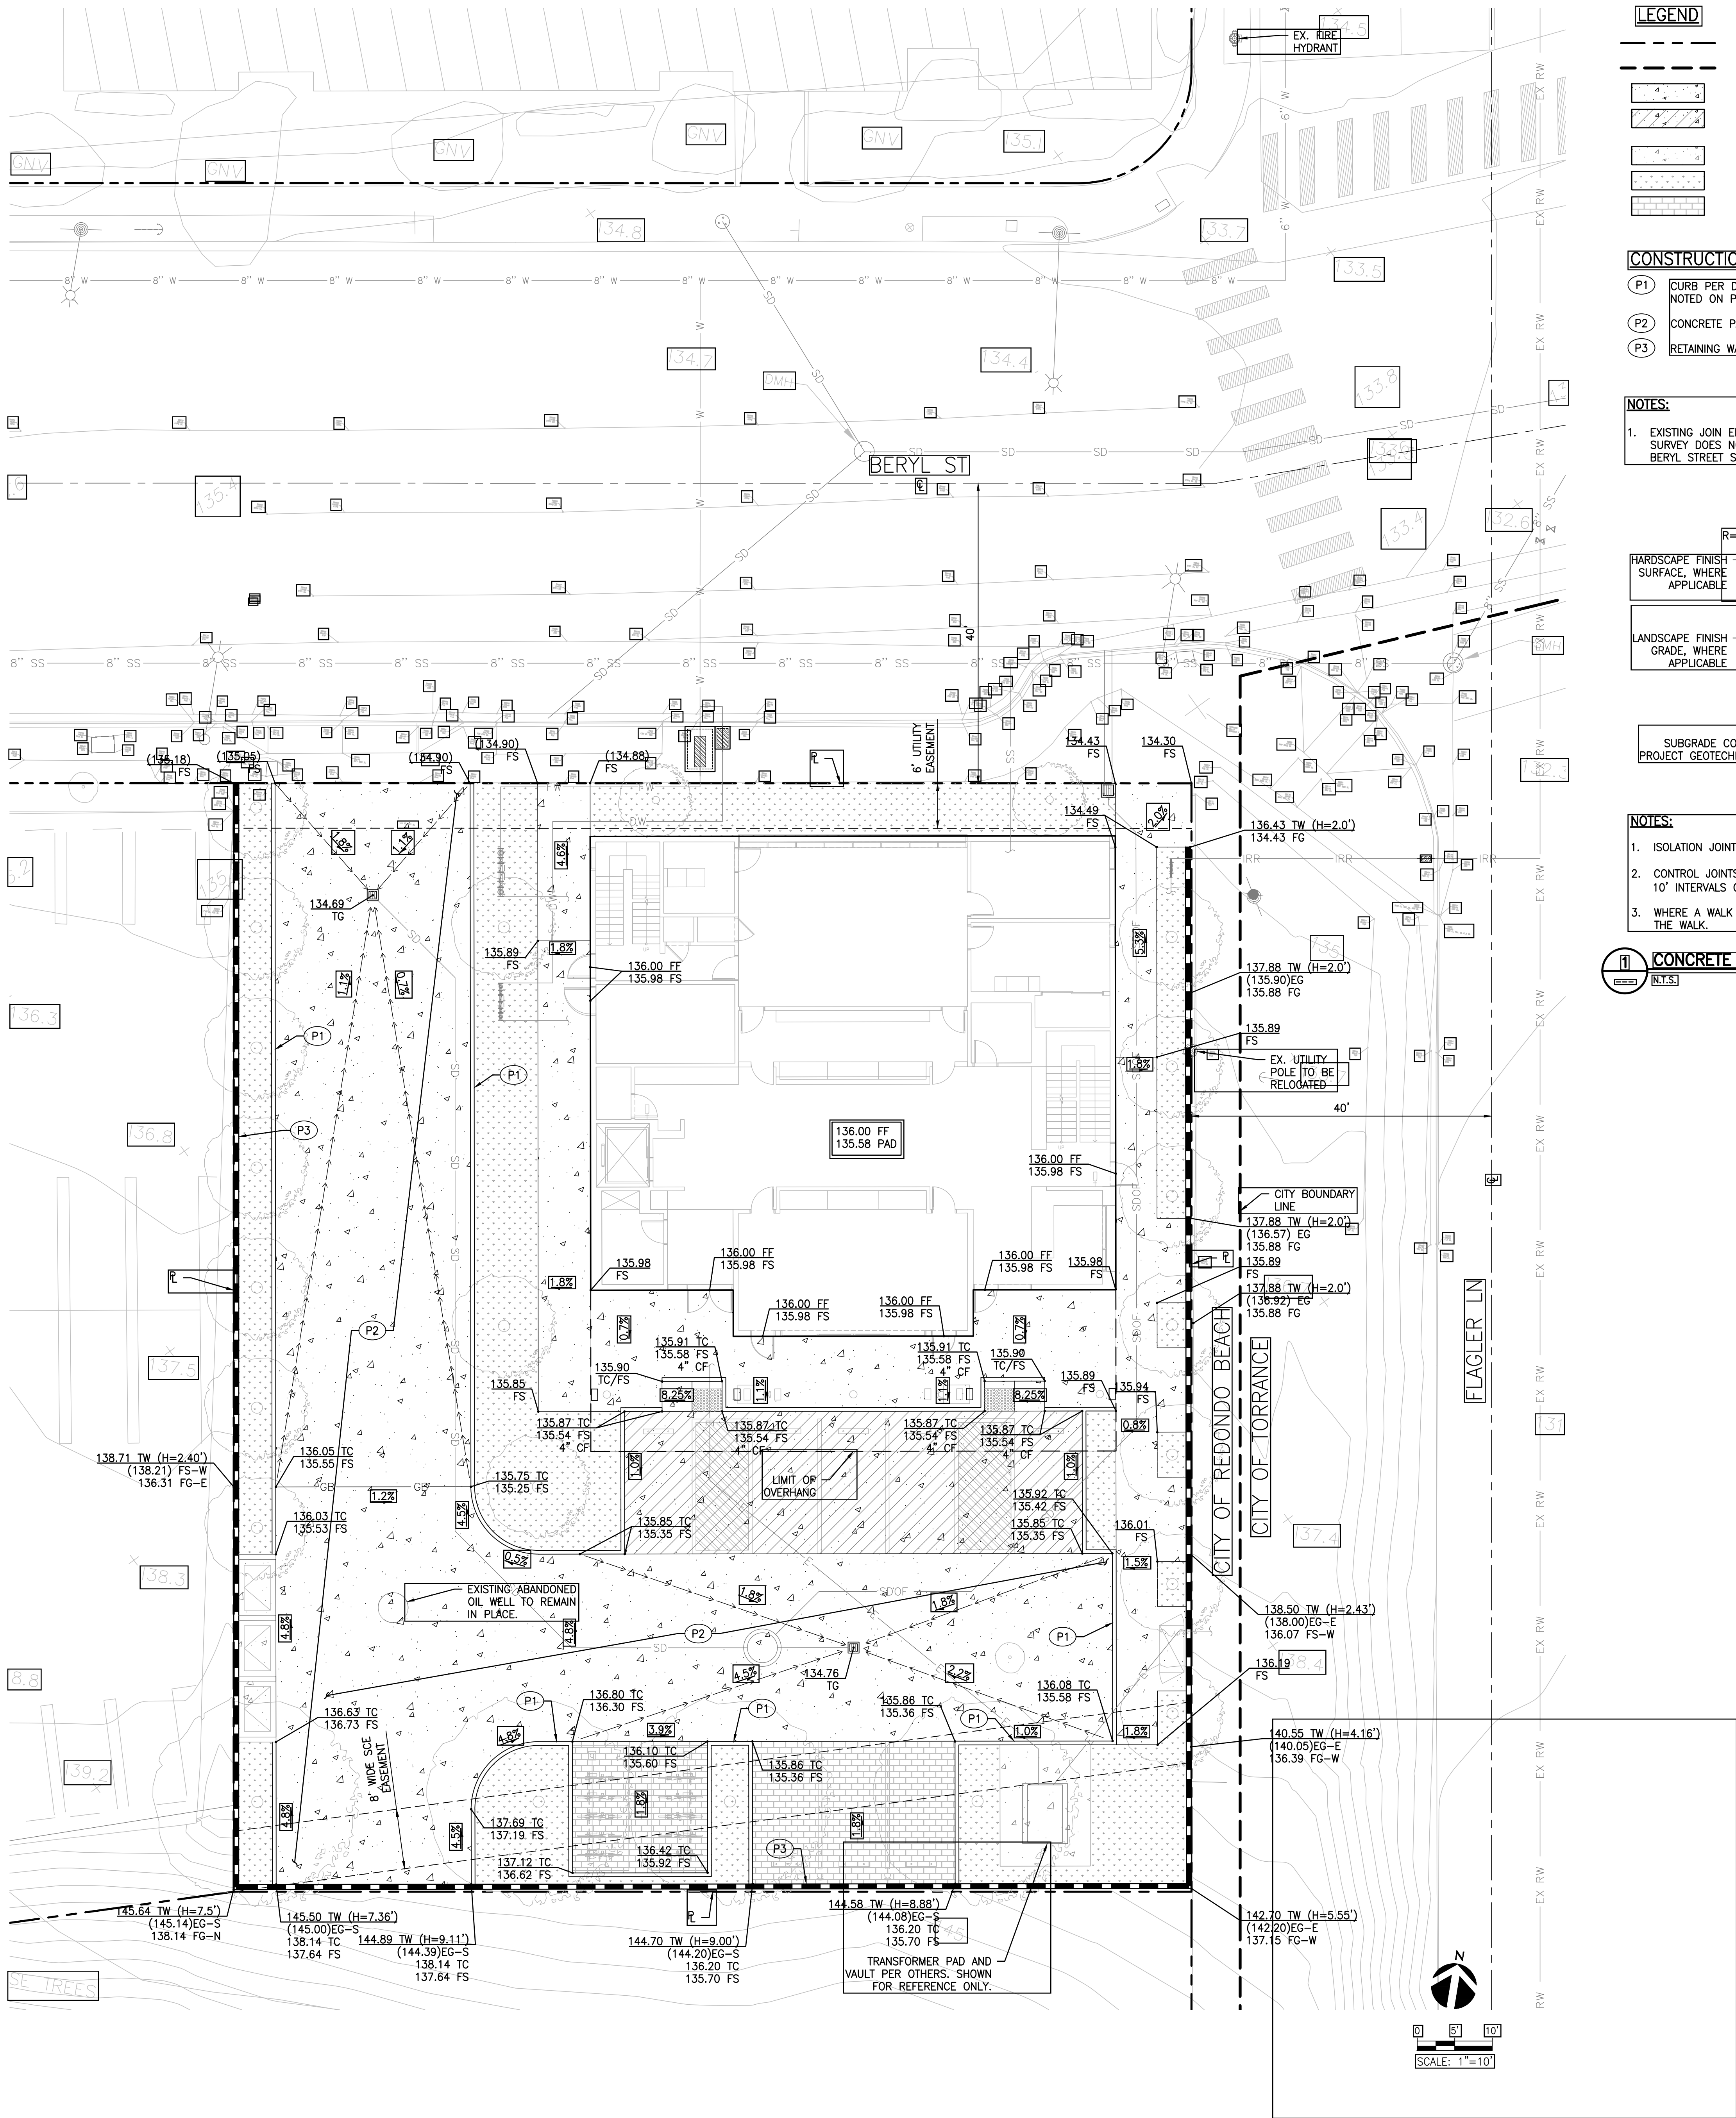

LEGEND	
	PROPERTY LINE
	CITY BOUNDARY
	PROPOSED CONCRETE
	PROPOSED CONCRETE, COLOR AND SCORE PATTERNS PER LANDSCAPE PLANS.
	PROPOSED CONCRETE PER OTHERS
	LANDSCAPE PER LANDSCAPE PLANS
	PERMEABLE PAVERS PER LANDSCAPE PLANS

CONSTRUCTION NOTES	
P1	CURB PER DETAIL 1, HEREON. 6" CURB FACE UNLESS OTHERWISE NOTED ON PLAN.
P2	CONCRETE PAVEMENT PER DETAIL 2, HEREON.
P3	RETAINING WALL PER STRUCTURAL PLANS.


NOTES:	
1.	EXISTING JOIN ELEVATIONS SHALL BE VERIFIED IN FIELD. SURVEY DOES NOT INCLUDE UPDATED ELEVATIONS FOR BERYL STREET STREET IMPROVEMENTS.

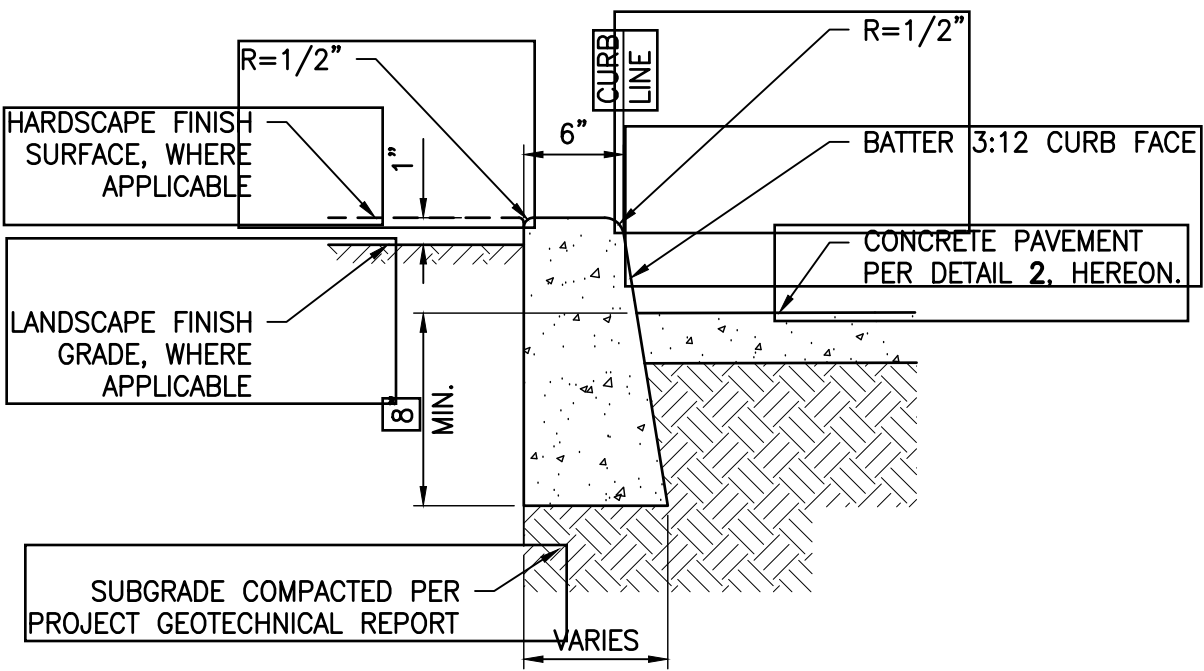

NOTES:	
1.	ISOLATION JOINTS SHALL BE PLACED ONLY AS SPECIFIED.
2.	CONTROL JOINTS CONSISTING OF 1" DEEP SCORES SHALL BE PLACED AT 10' INTERVALS O.C.
3.	WHERE A WALK IS ADJACENT TO THE CURB, THE JOINTS SHALL ALIGN WITH JOINTS IN THE WALK.

#### 1 CONCRETE CURB

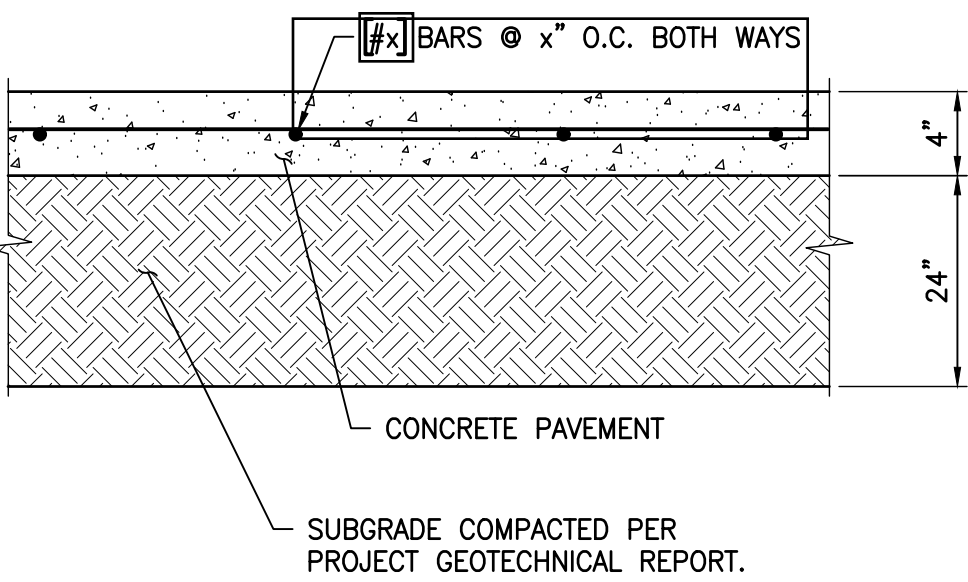N.T.S.



NOTES:	
1.	PAVEMENT SECTIONS ARE BASED ON RECOMMENDATIONS FROM THE PROJECT GEOTECHNICAL REPORT.
2.	REFER TO ARCHITECTURAL PLANS FOR CONCRETE COLOR, PATTERN, TEXTURE, AND FINISH.
3.	SEE PLAN FOR LOCATION OF CONTROL JOINTS.

#### 2 CONCRETE PAVEMENT SECTION

N.T.S.

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LFA Job No. 23798

NO. DATE REVISION  
**allcove**  
BEACH CITIES  
HEALTH DISTRICT

100% PRELIMINARY  
DESIGN SUBMITTAL

PMA PROJECT NO.  
23007

DRAWING TITLE

GRADING AND  
DRAINAGE PLAN

SCALE  
PER PLAN

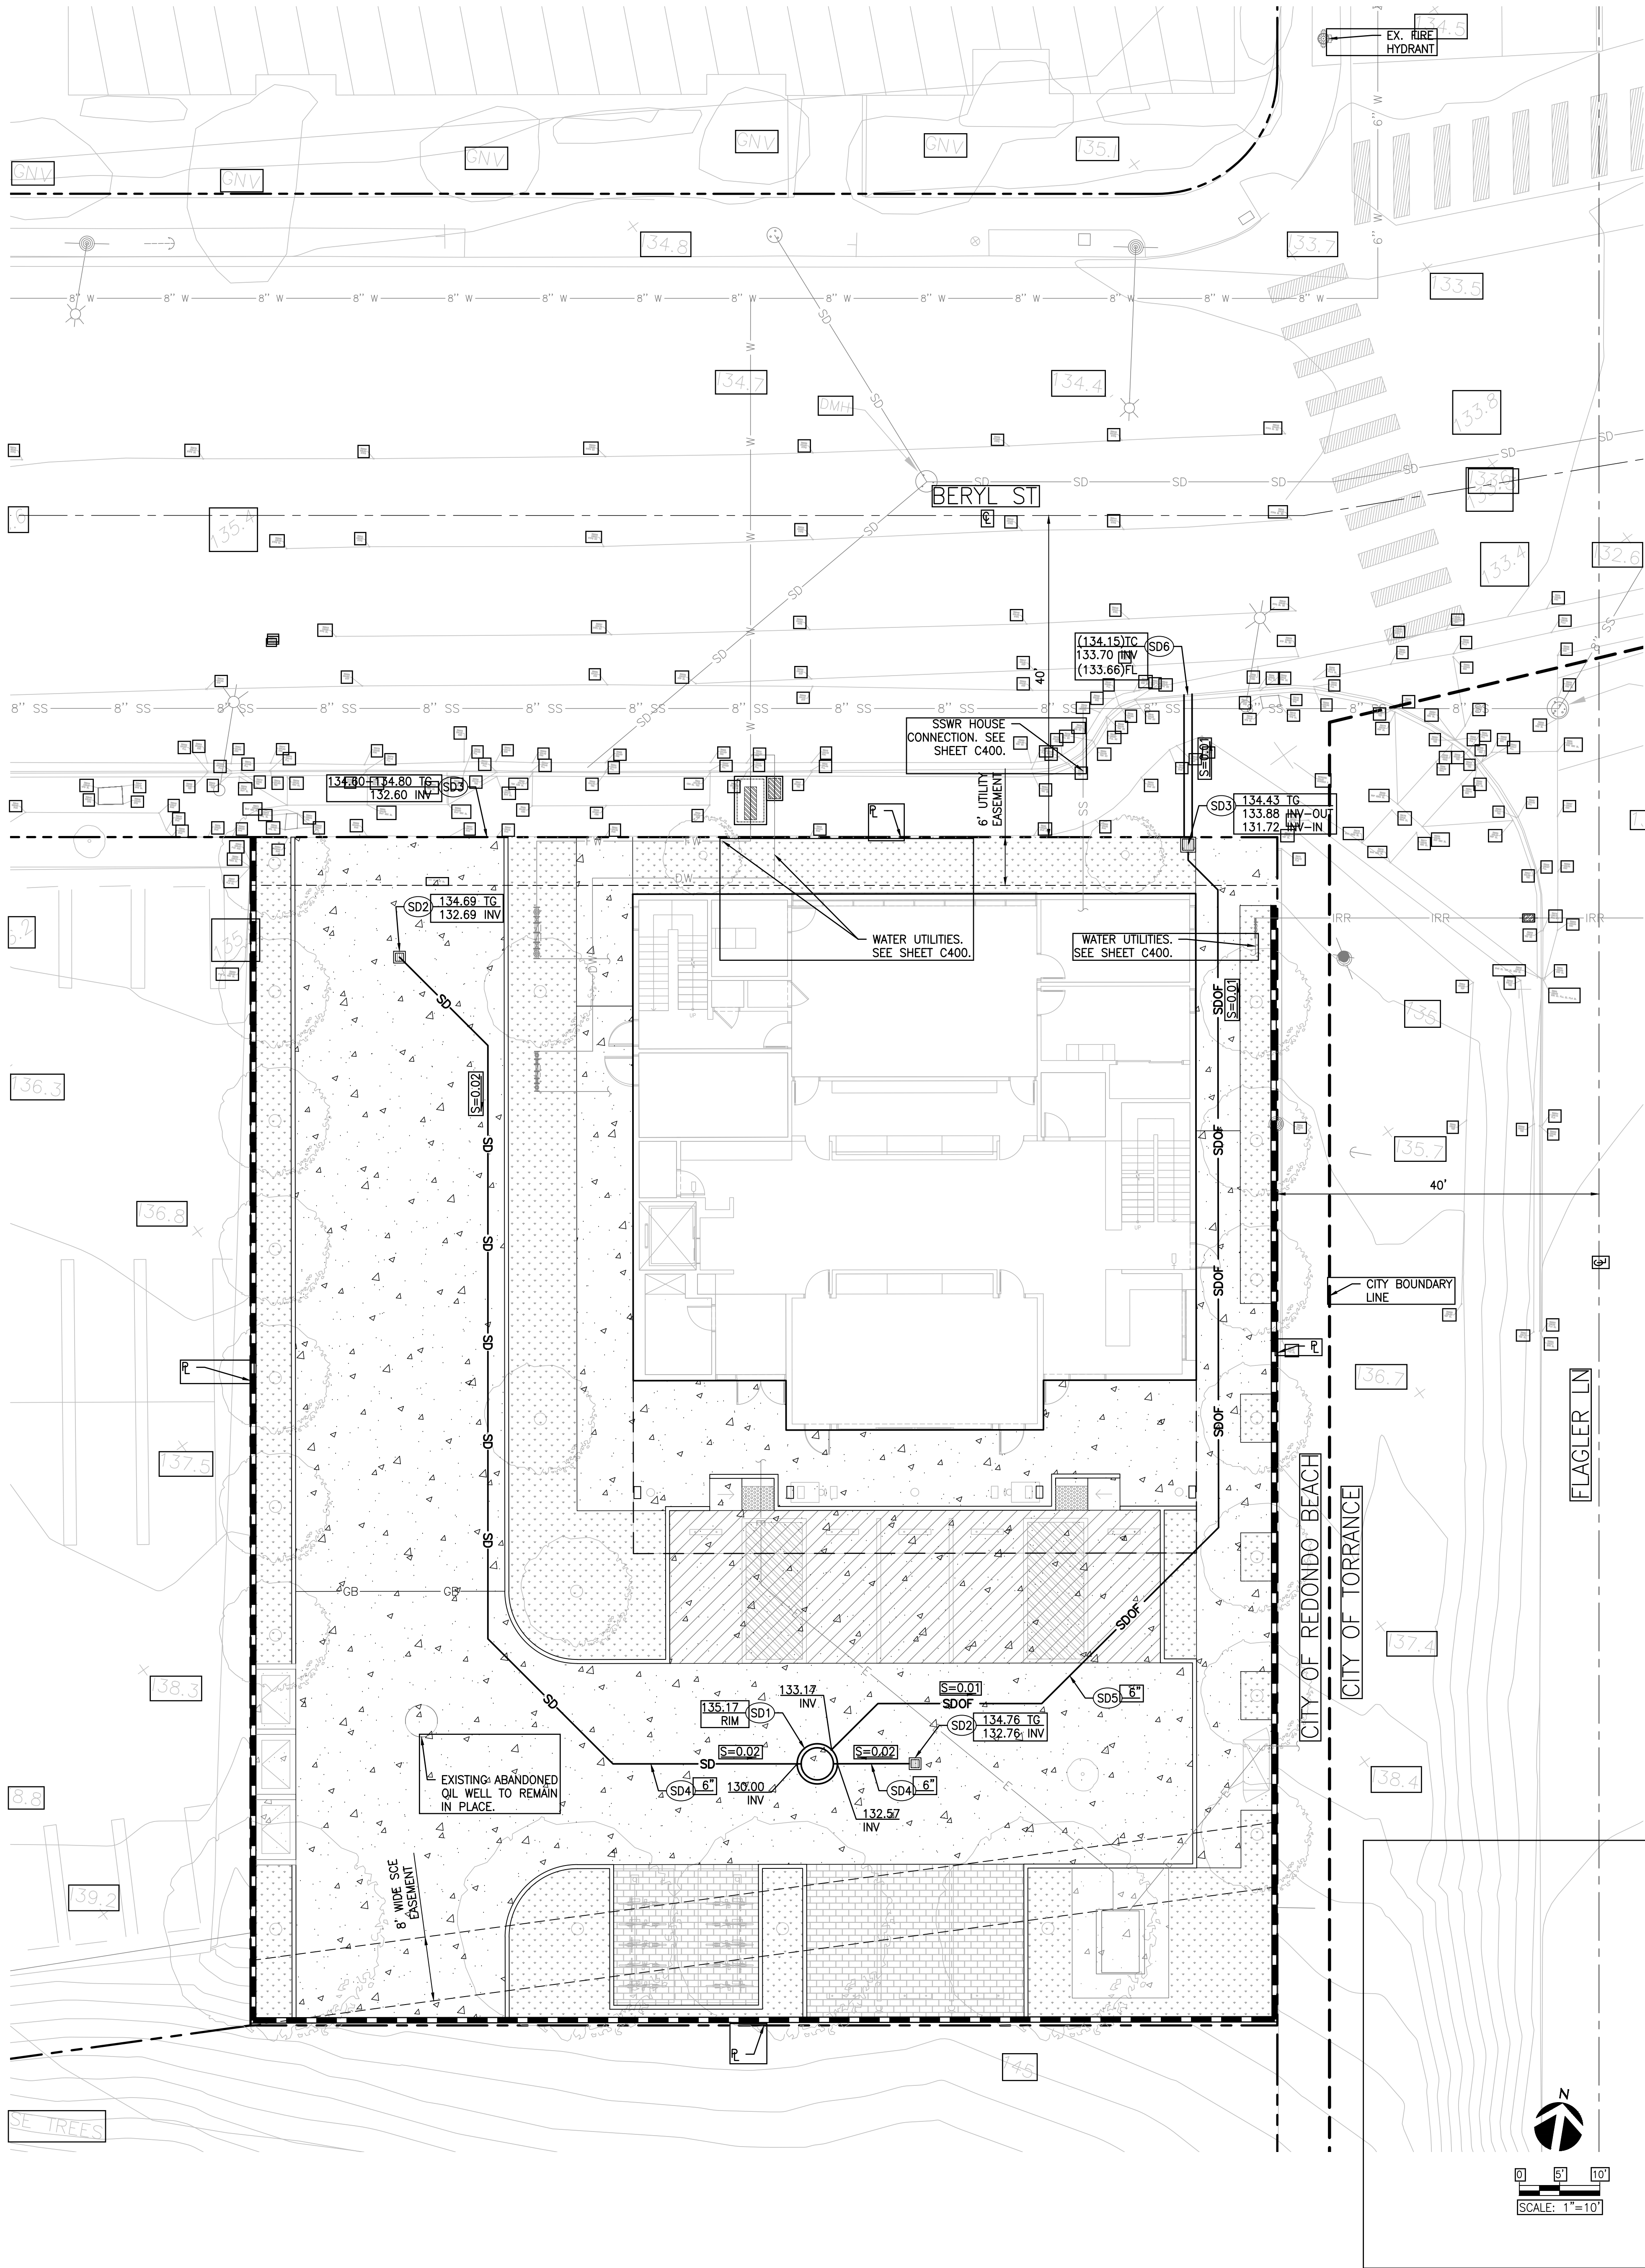
DATE  
02/28/2024

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SHEET NO.

C210





**LEGEND**

- PROPERTY LINE
- CITY BOUNDARY
- PROPOSED CONCRETE
- PROPOSED CONCRETE, COLOR AND SCORE PATTERNS PER LANDSCAPE PLANS.
- PROPOSED CONCRETE PER OTHERS
- LANDSCAPE PER LANDSCAPE PLANS
- PERMEABLE PAVERS PER LANDSCAPE PLANS
- STORM DRAIN PIPE
- AREA DRAIN/CATCH BASIN

**CONSTRUCTION NOTES**

- SD1 DRYWELL PER DETAIL 1, HEREON.
- SD2 12"x12" CATCH BASIN BY NDS PRO OR APPROVED EQUAL.
- SD3 18"x18" BUBBLER BOX PER DETAIL 2, HEREON.
- SD4 PVC STORM DRAIN PIPE. SIZE PER PLAN.
- SD5 PVC OVERFLOW STORM DRAIN PIPE.
- SD6 PARKWAY DRAIN PER APWA STD PLAN 151-3. S=12"

PROJECT SITE CHARACTERISTICS	
	QUANTITIES
TOTAL SITE AREA (S.F.)	18,864
IMPERVIOUS AREA (S.F.)	14,942
% IMPERVIOUS	79%
*LANDSCAPE (S.F.)	3,094
PERMEABLE PAVERS (S.F.)	828
TOTAL PERVIOUS AREA (S.F.)	3,922
RAINFALL DEPTH (IN.) - 95th	1.42
DESIGN VOLUME (C.F.)	1,621
*LANDSCAPE AREA UNDER OVER HANG NOT INCLUDED.	

**The MaxWell® IV**  
DRAINAGE SYSTEM DETAILS AND SPECIFICATIONS  
BCHD Allcove Facility - 95th  
Redondo Beach, CA

**ITEM NUMBERS**

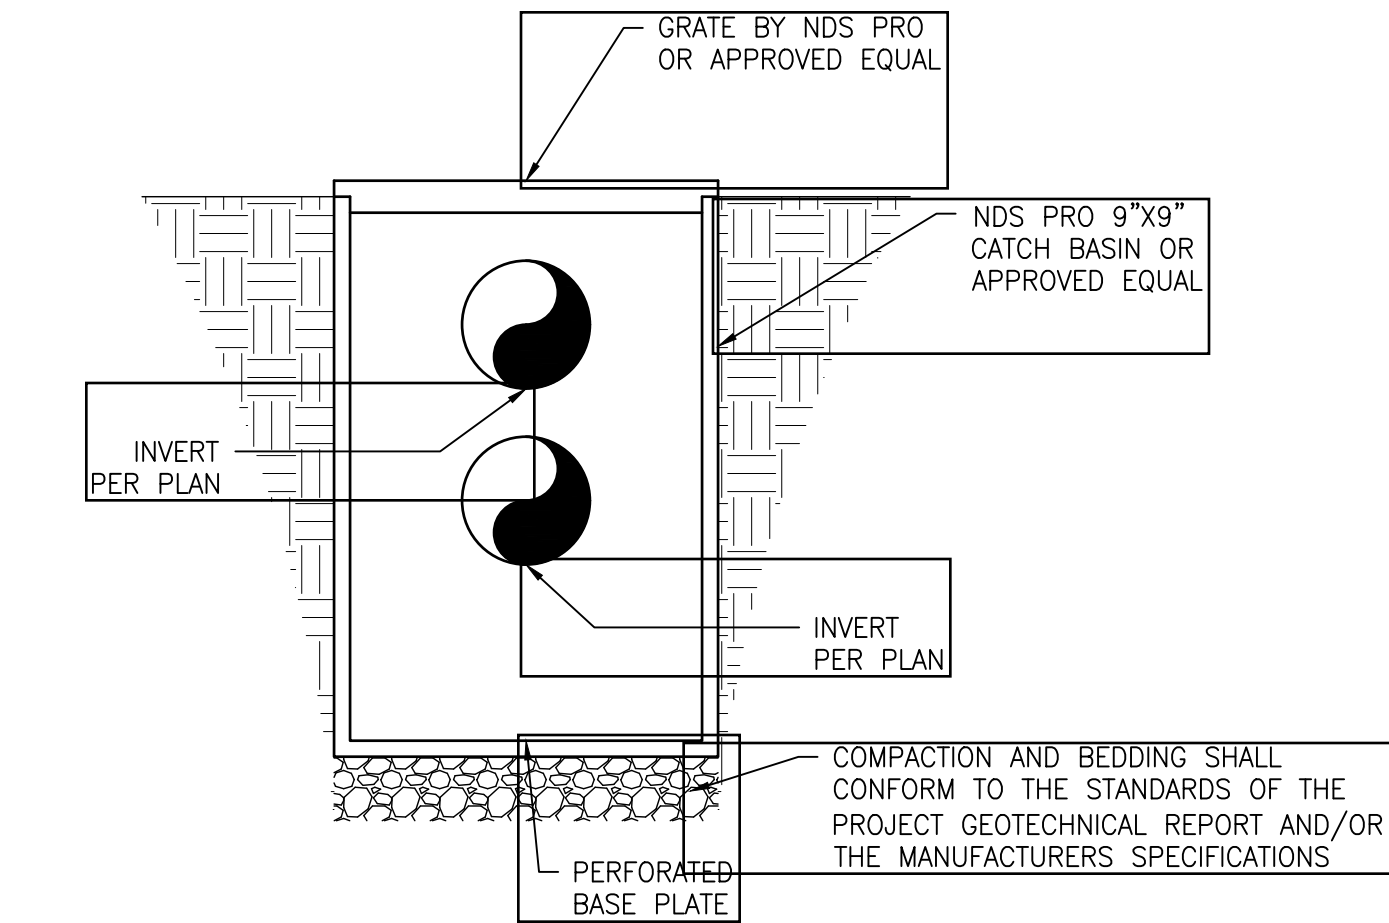
- MANHOLE CONE - MODIFIED FLAT BOTTOM.
- MIN 6" Ø DRILLED SHAFT.
- STABILIZED BACKFILL - TWO-SACK SLURRY MIX.
- NOT USED.
- INLET PIPE/OUTLET PIPE (BY OTHERS).  
SEE SEPARATE PLAN FOR INVERT ELEVATIONS.
- GRADED BASIN OR PAVING (BY OTHERS).
- COMPACTED BASE MATERIAL, IF REQUIRED (BY OTHERS).
- FREEBOARD DEPTH VARIES WITH INLET PIPE ELEVATION.  
INCREASE SETTLING CHAMBER DEPTH AS NEEDED TO MAINTAIN ALL INLET PIPE ELEVATIONS ABOVE RISER PIPE.
- NON-WOVEN GEOTEXTILE SLEEVE - MIRAF 140 NL MIN. 6 FT Ø, HELD APPROX. 10 FEET OFF THE BOTTOM OF EXCAVATION.
- PUREFLO® DEBRIS SHIELD - ROLLED 16 GA. STEEL X 24" LENGTH WITH VENTED ANTI-SIPHON AND INTERNAL 0.25" MAX. SWG FLATTENED EXPANDED STEEL SCREEN X 12" LENGTH. FUSION BONDED EPOXY COATED.
- MIN. 6" Ø DRILLED SHAFT.
- RISER PIPE - SCH. 40 PVC MATED TO DRAINAGE PIPE AT BASE SEAL.
- DRAINAGE PIPE - ADS HIGHWAY GRADE OR SCH. 40 PVC WITH TRI-A COUPLER, SUSPEND PIPE DURING BACKFILL OPERATIONS. DIAMETER AS NOTED.
- ROCK - WASHED, SIZED BETWEEN 3/8" AND 1-1/2".
- FLOFAST® DRAINAGE SCREEN - SCH. 40 PVC X 120" SLOTTED WELL SCREEN WITH MIN. 32 SLOTS PER ROW/FT. OVERALL LENGTH VARIES, UP TO 120" WITH TRI-B COUPLER.
- ABSORBENT - HYDROPHOBIC PETROCHEMICAL SPONGE. MIN. 128 OZ. CAPACITY. TYPICAL 2 PER CHAMBER.
- FABRIC SEAL - U.V. RESISTANT GEOTEXTILE. TO BE REMOVED BY CUSTOMER AT PROJECT COMPLETION. GRATED ONLY.
- BOLTED RING & GRATE/COVER - DIAMETER & TYPE AS SHOWN. CLEAN CAST IRON WITH WORDING "STORM WATER ONLY" IN RAISED LETTERS. BOLTED IN 2 LOCATIONS AND SECURE TO CONE WITH MORTAR. RIM ELEVATION ±0.02' OF PLANS.
- BASE SEAL - GEOTEXTILE.
- PRE-CAST LINER - 4000 PSI CONCRETE 48" ID. X 54" OD. CENTER IN HOLE AND ALIGN SECTIONS TO MAXIMIZE BEARING SURFACE.

ESTIMATED TOTAL DEPTH WITH 10' PENETRATION INTO PERMEABLE SOILS

DETAIL: IV-4-CS-CA  
DRAWN ON: 07-20-23  
REVIEWED BY: RJA  
REVISED DATE: 02-23-24  
SCALE: N.T.S.

Manufactured and Installed by  
**TorrentResources**  
An evolution of McCusker Drilling  
www.torrentresources.com

**1 DRYWELL DETAIL**  
N.T.S.



**2 BUBBLER BOX DETAIL**  
N.T.S.



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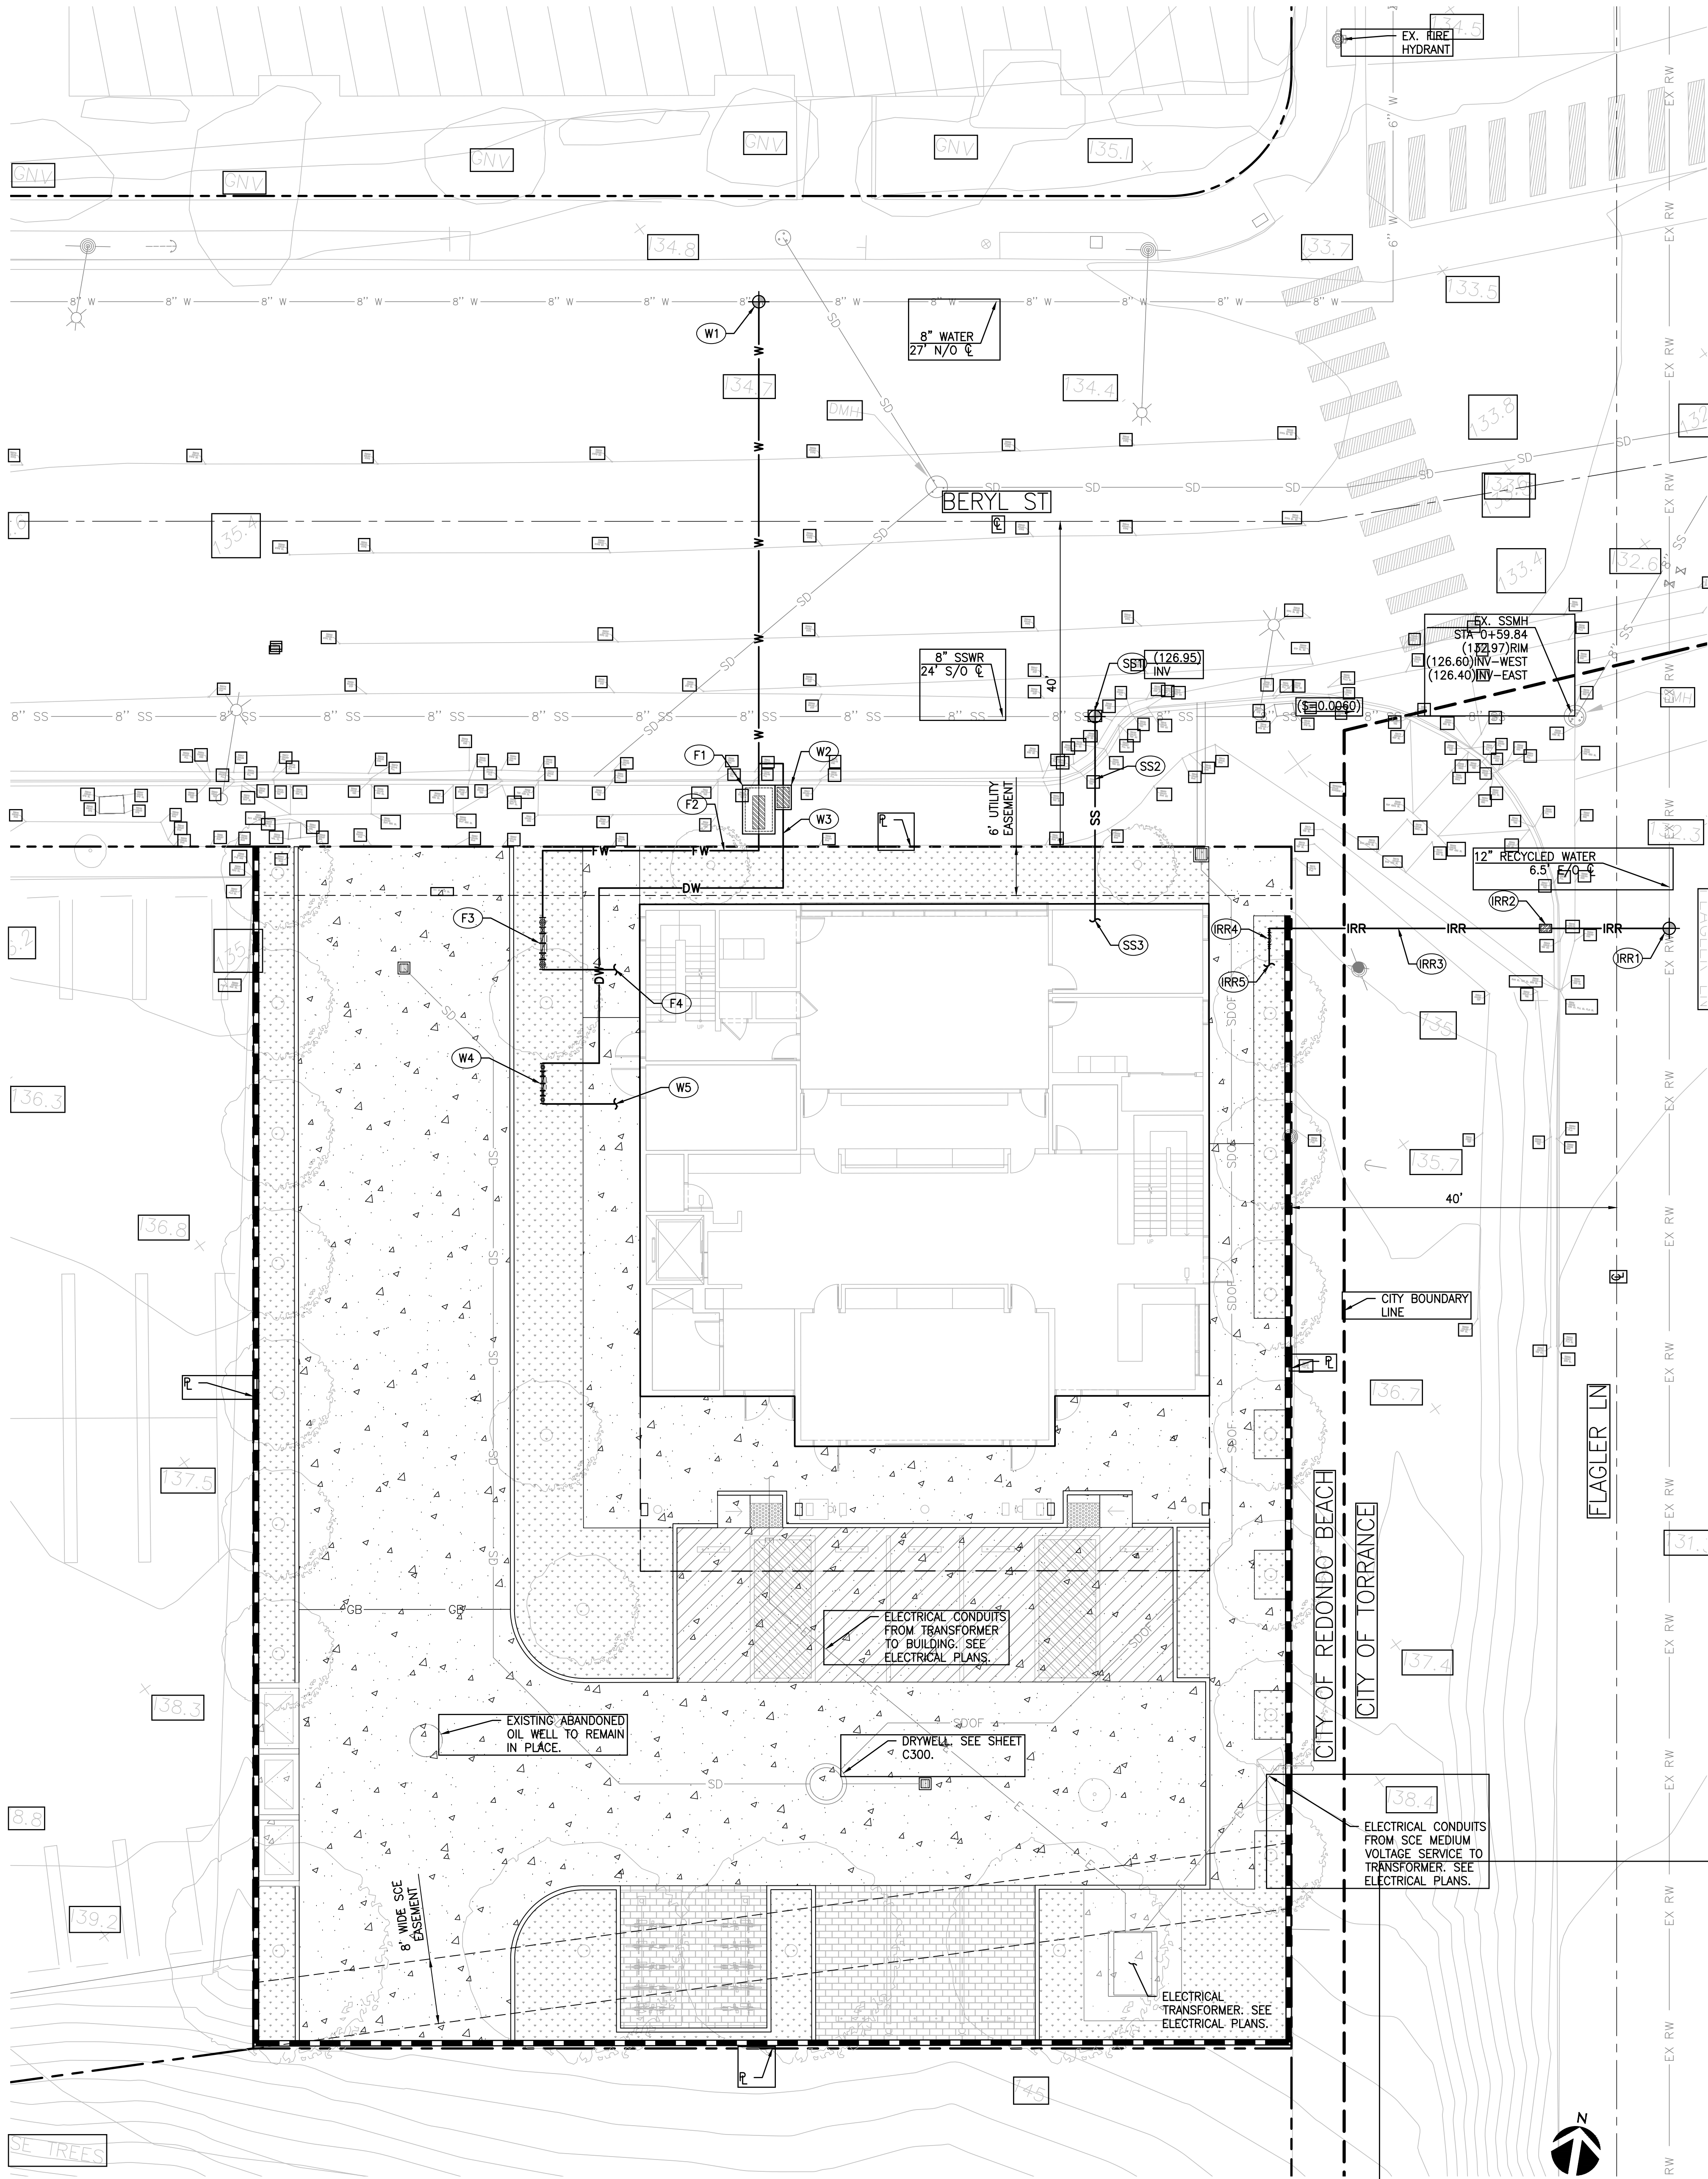
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NO.	DATE	REVISION
<b>allcove</b> BEACH CITIES HEALTH DISTRICT		
100% PRELIMINARY DESIGN SUBMITTAL		
PMA PROJECT NO. 23007		
DRAWING TITLE LOW IMPACT DEVELOPMENT PLAN		
SCALE PER PLAN		
DATE 02/28/2024		
DRAWN I.S.		
CHECKED F.L.		
SHEET NO. C300		





LEGEND	
	PROPERTY LINE
	CITY BOUNDARY
	POINT OF CONNECTION
	COORDINATION POINT
	BACKFLOW ASSEMBLY
	WATER METER VAULT

#### CONSTRUCTION NOTES

##### SANITARY SEWER

- (SS1) INSTALL SEWER HOUSE CONNECTION PER APWA STANDARD PLAN 222-1, TYPE A.
- (SS2) SDR-35 PVC SANITARY SEWER PIPE. 2% MIN. SLOPE. SIZE TO BE DETERMINED BY PLUMBING ENGINEER.
- (SS3) POINT OF CONNECTION 5 FEET FROM BUILDING FACE. SEE PLUMBING PLANS FOR CONTINUATION. DEPTH AND SIZE TO BE DETERMINED BY PLUMBING ENGINEER.

##### IRRIGATION WATER

- (IR1) CONTRACTOR TO ORDER AND COORDINATE NEW IRRIGATION WATER SERVICE CONNECTION FROM WEST BASIN MUNICIPAL WATER DISTRICT.
- (IR2) IRRIGATION WATER METER. CONTRACTOR TO COORDINATE WATER SERVICE CONNECTION WITH WEST BASIN MUNICIPAL WATER DISTRICT. SIZE TO BE DETERMINED BY LANDSCAPE ARCHITECT.
- (IR3) SCHEDULE 40 PVC WATER PIPE. SIZE TO BE DETERMINED BY DESIGN-BUILD CONTRACTOR.
- (IR4) WEST BASIN MUNICIPAL WATER DISTRICT APPROVED REDUCED PRESSURE BACK FLOW PREVENTER. SEE IRRIGATION PLANS FOR DETAILS. SIZE TO BE DETERMINED BY DESIGN-BUILD CONTRACTOR.
- (IR5) POINT OF CONNECTION TO IRRIGATION SYSTEM. SEE IRRIGATION PLANS FOR CONTINUATION, DETAILS, AND SPECIFICATIONS.

##### DOMESTIC WATER

- (W1) CONTRACTOR TO ORDER AND COORDINATE NEW DOMESTIC WATER AND FIRE WATER COMBO SERVICE CONNECTION FROM CALIFORNIA WATER SERVICE.
- (W2) X" DOMESTIC WATER METER. CONTRACTOR TO COORDINATE WATER SERVICE CONNECTION WITH CALIFORNIA WATER SERVICE. SIZE TO BE DETERMINED BY PLUMBING ENGINEER.
- (W3) X" SCHEDULE 40 PVC WATER PIPE. SIZE TO BE DETERMINED BY PLUMBING ENGINEER.
- (W4) CALIFORNIA WATER SERVICE APPROVED REDUCED PRESSURE BACK FLOW PREVENTER. SEE PLUMBING PLANS FOR DETAILS. SIZE TO BE DETERMINED BY PLUMBING ENGINEER.
- (W5) POINT OF CONNECTION 5' FROM BUILDING FACE. SEE PLUMBING PLANS FOR CONTINUATION, DETAILS, AND SPECIFICATIONS.

##### FIRE WATER

- (F1) FIRE WATER METER TO BE VERIFIED BY DESIGN/BUILD FIRE SPRINKLER PLANS. CONTRACTOR TO COORDINATE WATER SERVICE CONNECTION WITH CALIFORNIA WATER SERVICE. SIZE TO BE DETERMINED BY FIRE SPRINKLER ENGINEER.
- (F2) C-900 PVC WATER PIPE. SIZE TO BE DETERMINED BY FIRE SPRINKLER ENGINEER.
- (F3) CALIFORNIA WATER SERVICE APPROVED DOUBLE CHECK DETECTOR BACK FLOW PREVENTER. SEE FIRE SPRINKLER PLANS FOR DETAILS. SIZE TO BE DETERMINED BY FIRE SPRINKLER ENGINEER.
- (F4) POINT OF CONNECTION 5' FROM BUILDING FACE. SEE FIRE SPRINKLER PLANS FOR CONTINUATION, DETAILS, AND SPECIFICATIONS.

#### NOTES:

1. THE LOCALLY AVAILABLE MUNICIPAL RECLAIMED WATER IRRIGATION SYSTEM IS TO BE UTILIZED FOR THIS PROJECT. THE CONTRACTOR SHALL DESIGN THE SYSTEM TO MEET THE REQUIREMENTS OF LA COUNTY PUBLIC HEALTH AND THE WEST BASIN MUNICIPAL WATER DISTRICT FOR RECLAIMED WATER IRRIGATION SYSTEMS.

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ARCHITECTS

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BEACH CITIES  
HEALTH DISTRICT

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DESIGN SUBMITTAL

PMA PROJECT NO.  
23007

DRAWING TITLE  
UTILITY PLAN

SCALE  
PER PLAN

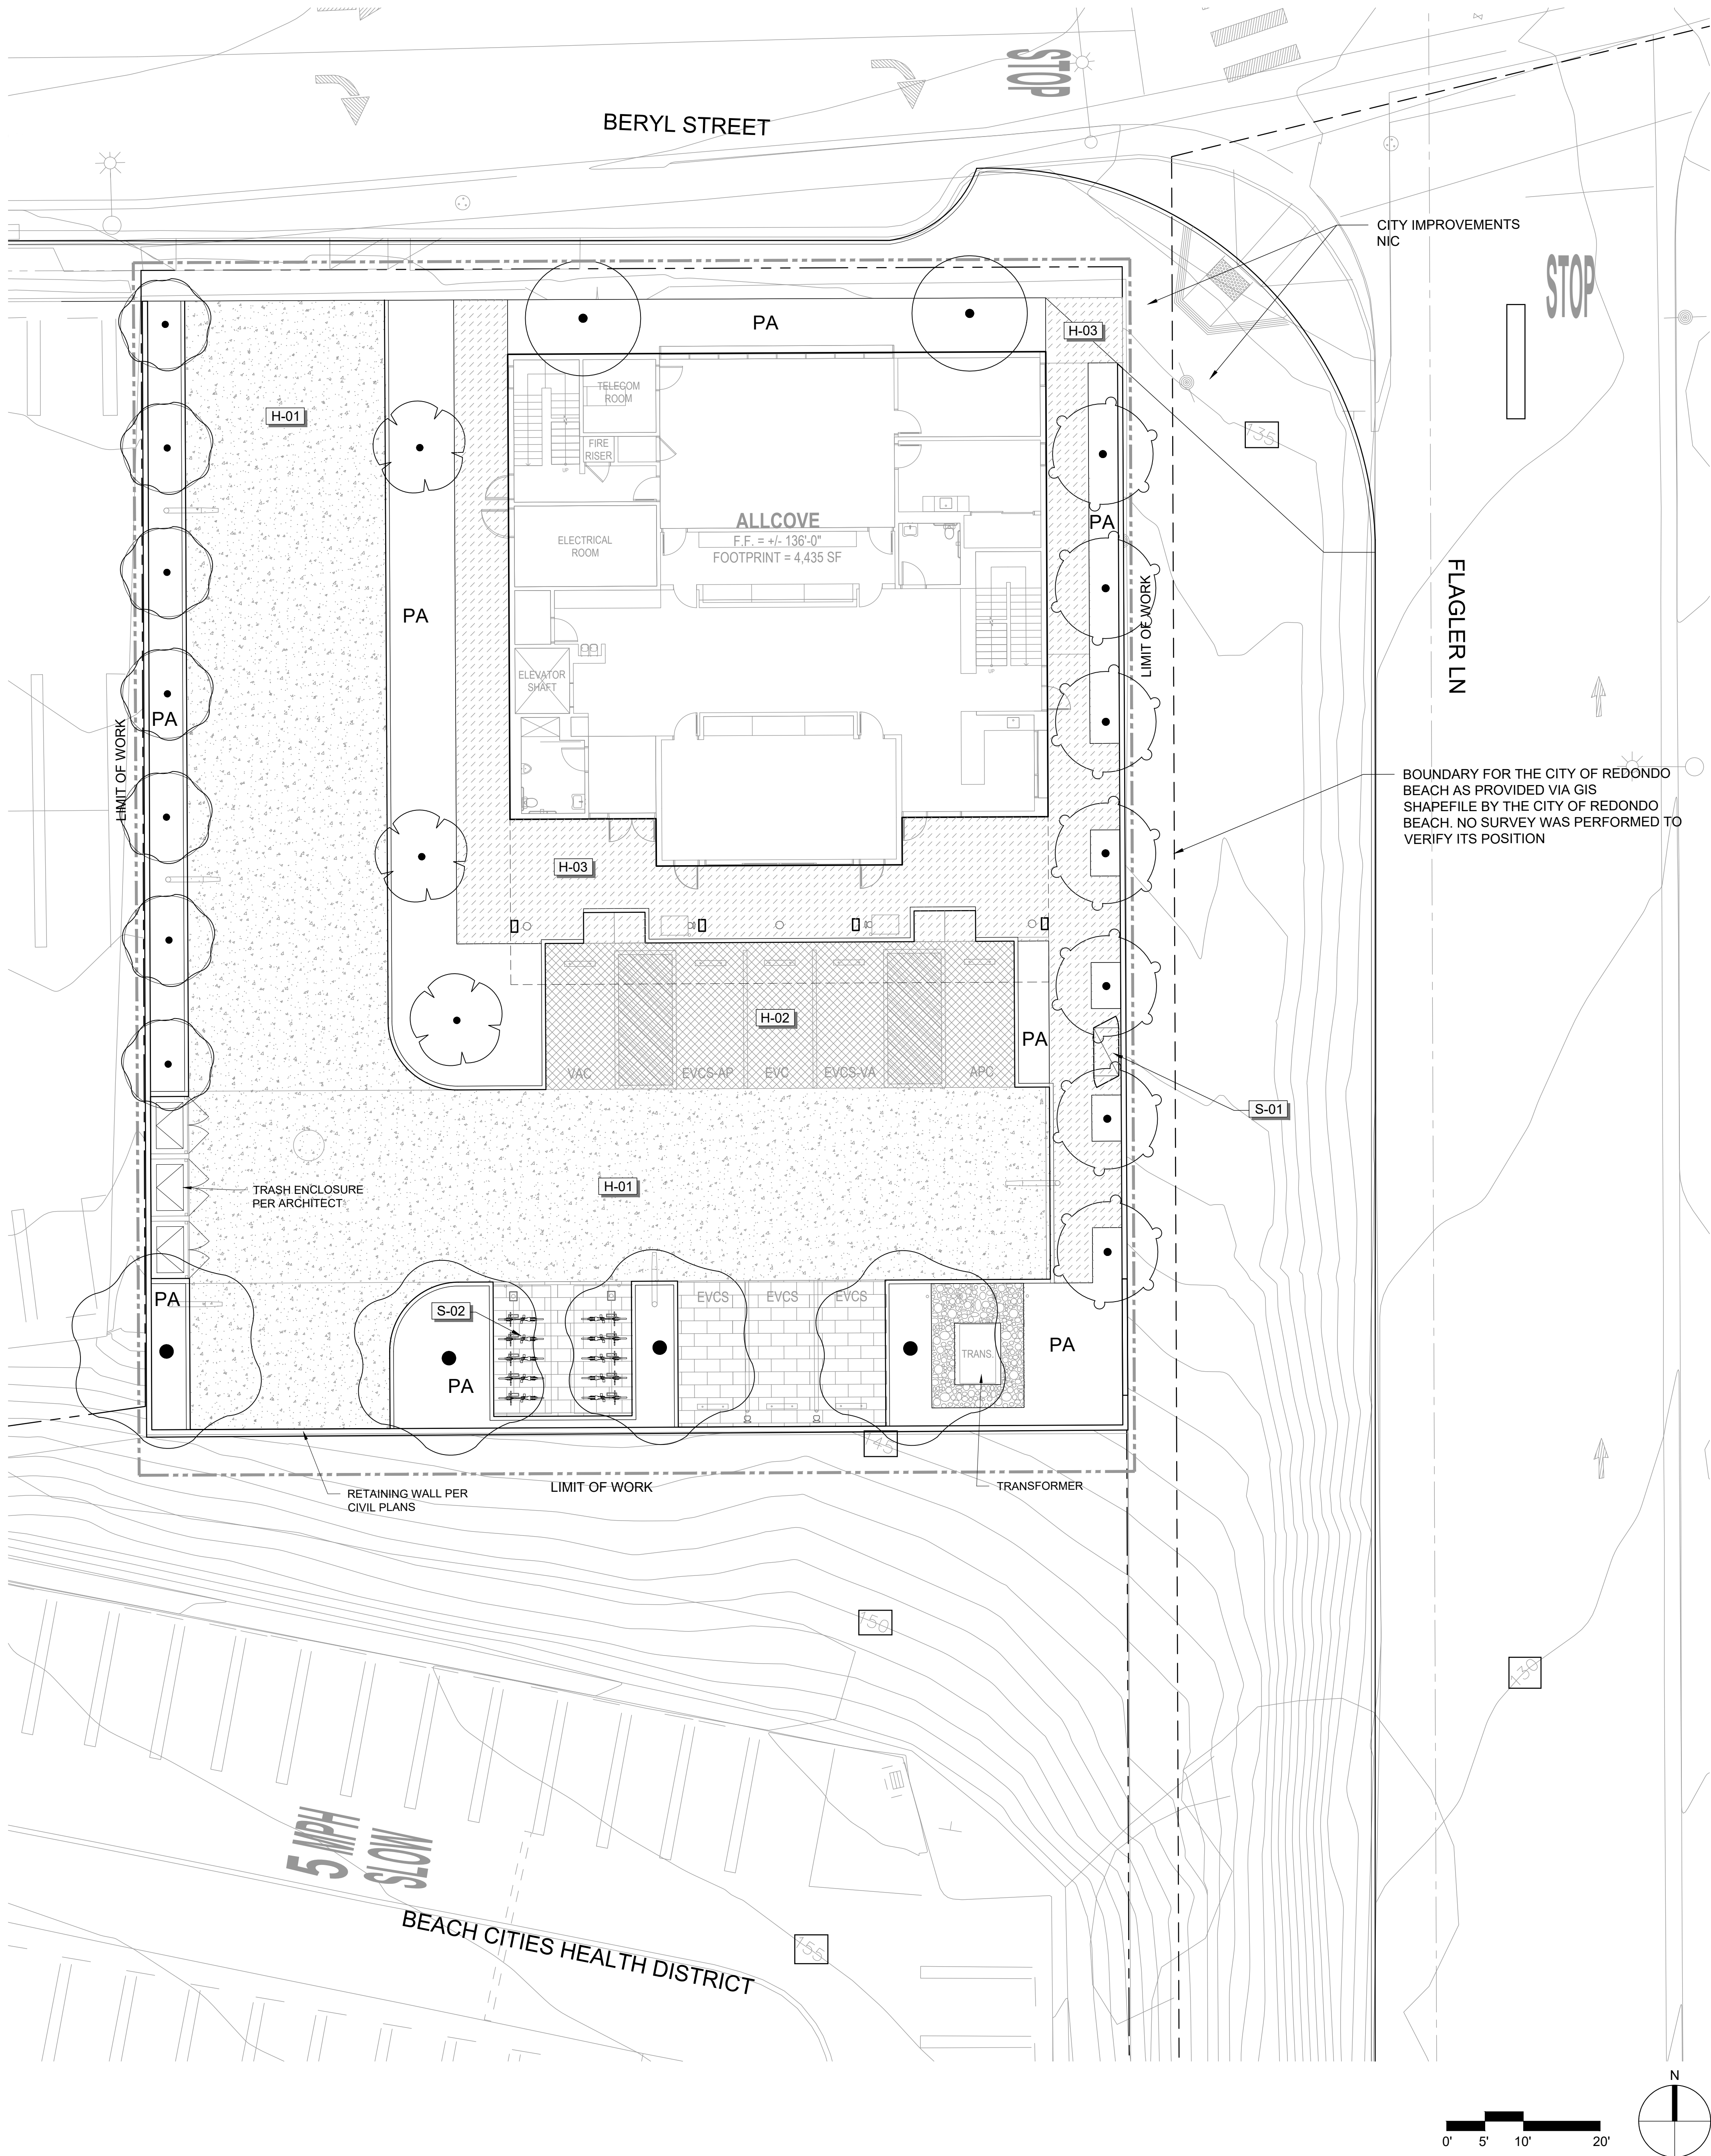
DATE  
02/28/2024

DRAWN CHECKED  
I.S. F.L.

SHEET NO.

C400





REFERENCE NOTES SCHEDULE

SYMBOL	HARDSCAPE DESCRIPTION	DETAIL
	<b>H-01</b> VEHICULAR CONCRETE PAVING - NATURAL GREY CONCRETE WITH TOPCAST FINISH - SEE CIVIL DOCUMENTS	
	<b>H-02</b> DECORATIVE VEHICULAR CONCRETE PAVING - INTEGRAL COLOR CONCRETE - FINISH: TOPCAST OR EQUAL - COLOR: DAVIS COLORS 'OUTBACK' OR EQUAL - SAWCUT JOINTS	
	<b>H-03</b> PEDESTRIAN CONCRETE PAVING - INTEGRAL COLOR CONCRETE - FINISH: TOPCAST OR EQUAL - COLOR: DAVIS COLORS 'OUTBACK' OR EQUAL - SAWCUT JOINTS	3/L300
	<b>H-04</b> PERMEABLE PAVERS 100 MM TRAFFIC RATED - AQUALINA PAVING STONES BY ANGELUS PAVING STONES OR APPROVED EQUAL - BLENDED COLORS: DARK GRAY- PEWTER- CHARCOAL - SIZE VARIES - RUNNING BOND PATTERN	5/L300
	<b>H-05</b> GRAVEL MULCH - SIZE: 3/8" CRUSHED - COLOR: GRAY	1/L300
SYMBOL	SITE AMENITIES DESCRIPTION	DETAIL
	<b>S-01</b> BICYCLE LOCKER - PROVIDE PARKING FOR 2 BIKES	
	<b>S-02</b> BIKE RACKS WITH ELECTRIC CHARGING - PROVIDE PARKING FOR 10 BIKES	

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PMA PROJECT NO.  
23007

DRAWING TITLE  
**HARDSCAPE  
PLAN**

SCALE  
AS SHOWN


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BB DC,MSM

SHEET NO.

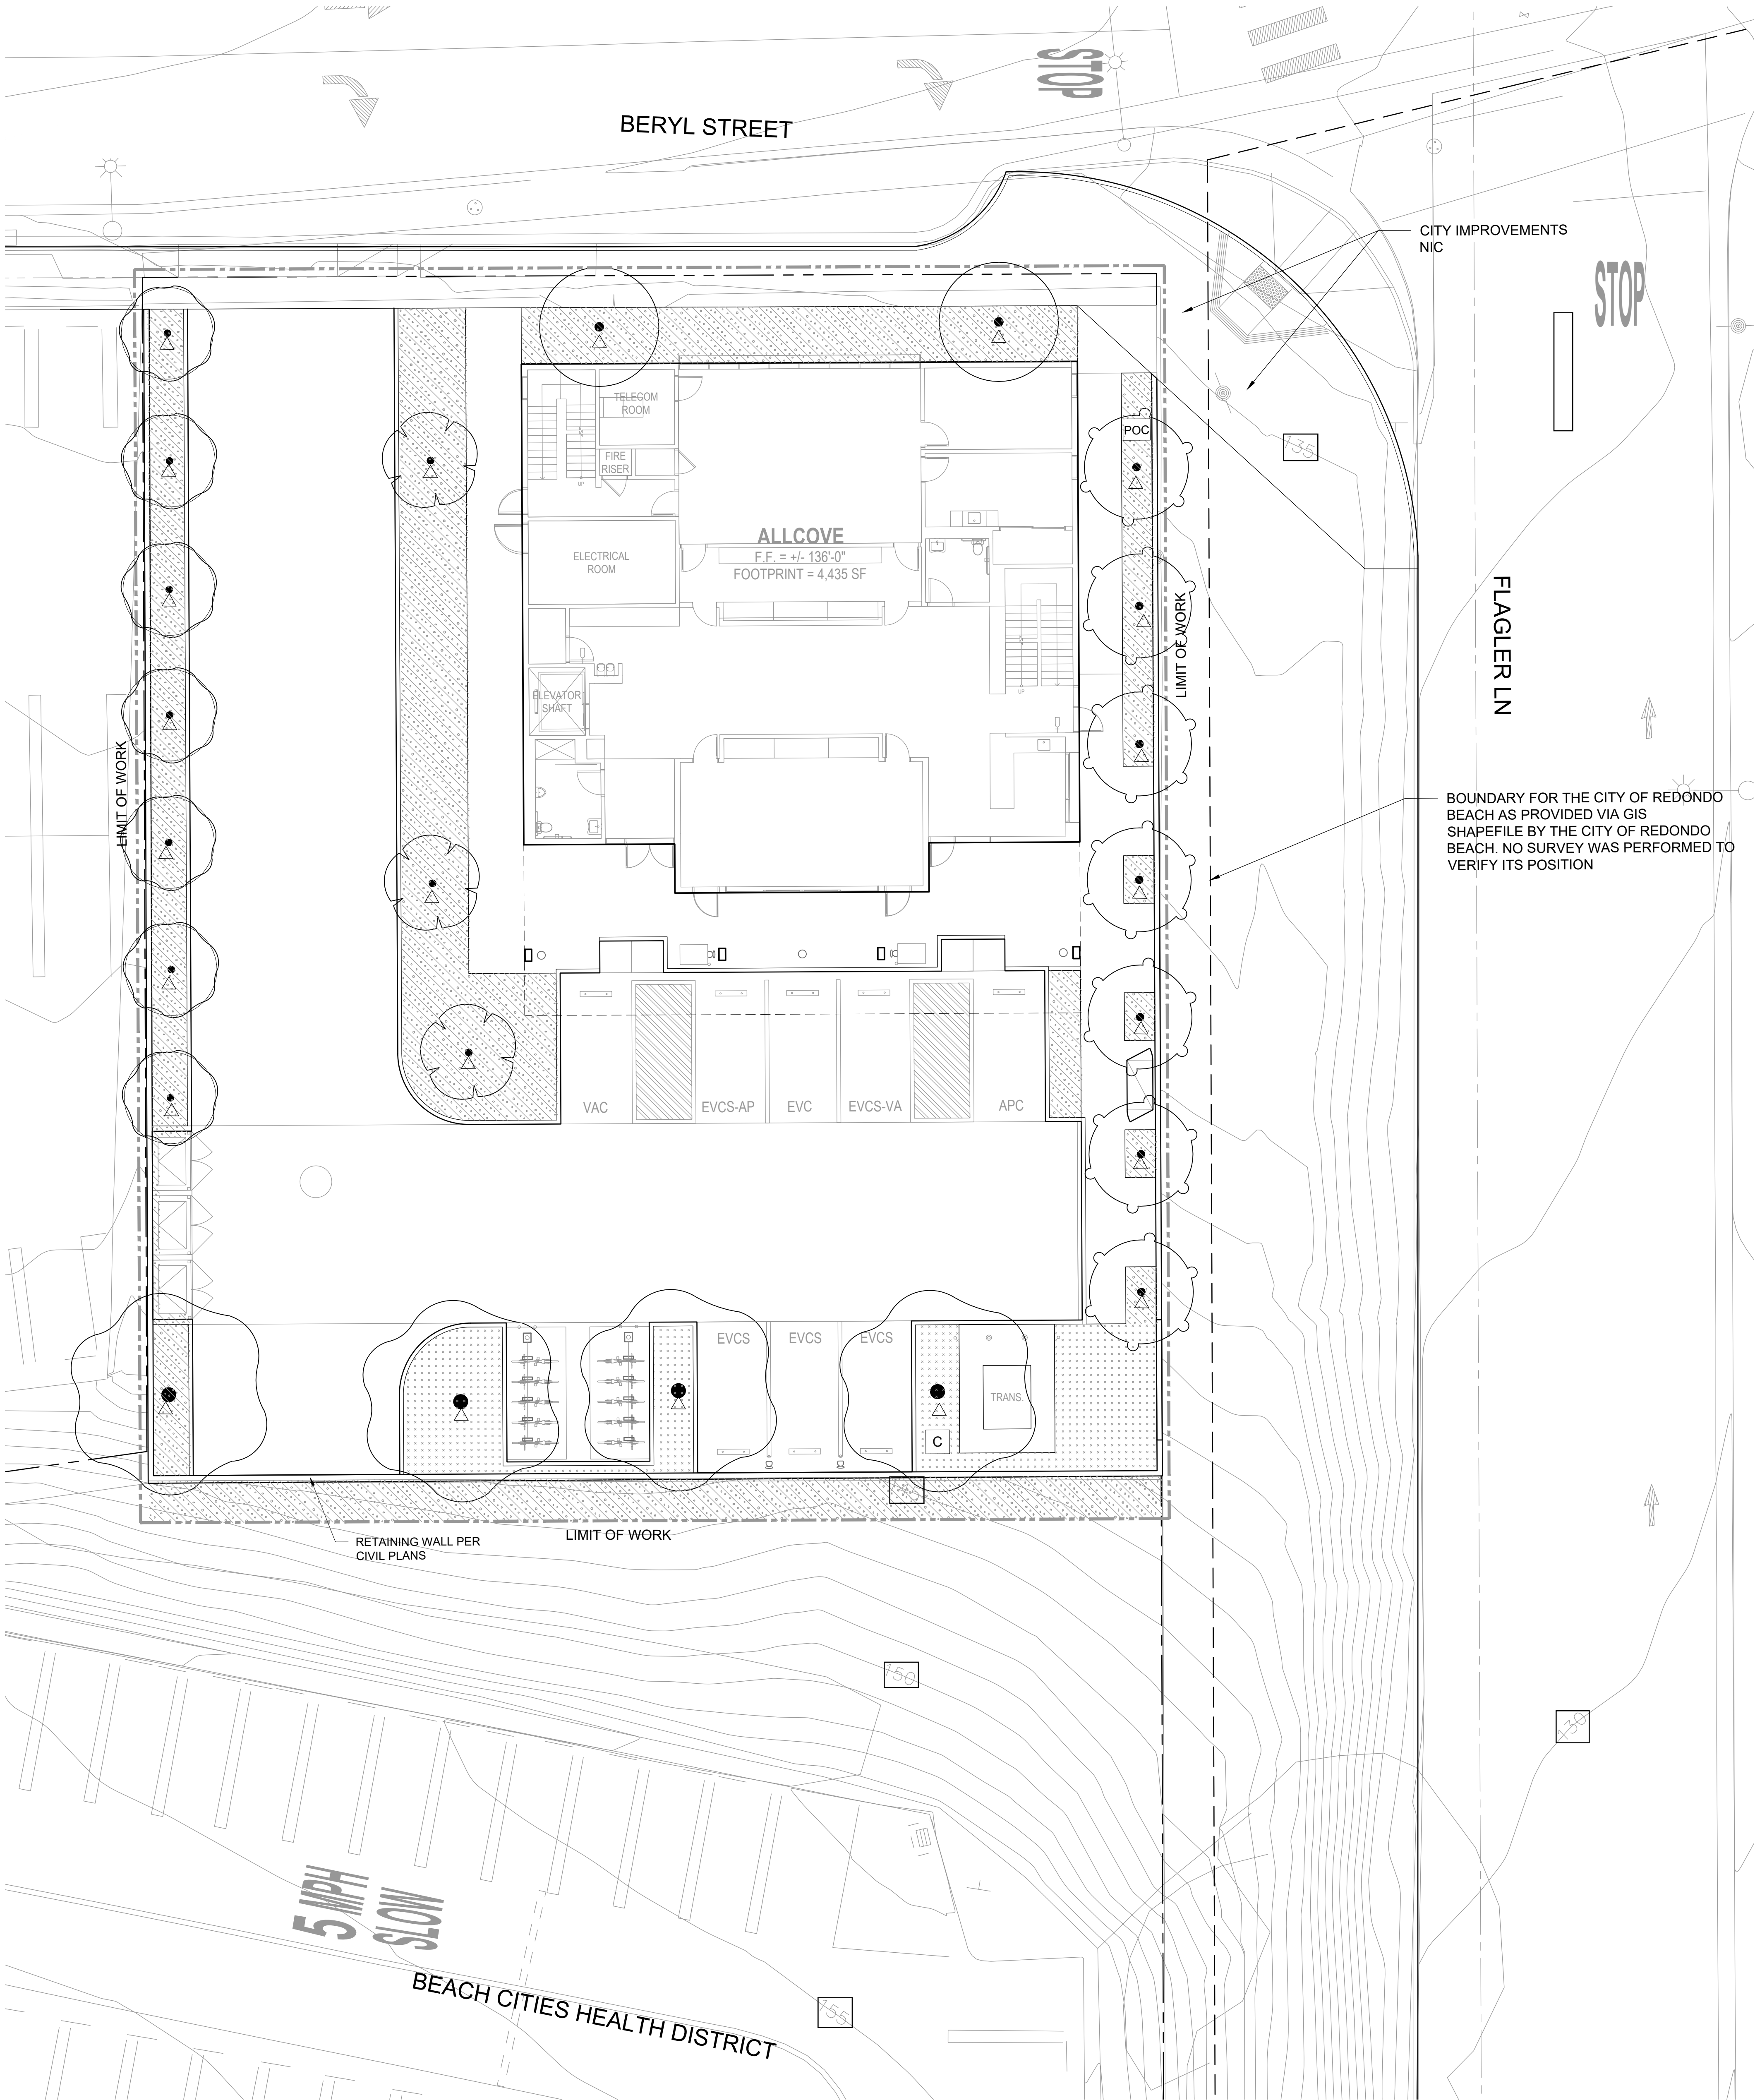L100





TREE PLANTING PALETTE

SYMBOL	BOTANICAL NAME	COMMON NAME	CONT	WUCOLS	QTY
TREES					
	CERCIS CANADENSIS 'FOREST PANSY'	FOREST PANSY EASTERN REDBUD	36" BOX	M	3
	GEIJERA PARVIFLORA	AUSTRALIAN WILLOW	36" BOX	L	2
	GINKGO BILOBA 'PRINCETON SENTRY'	PRINCETON SENTRY MAIDENHAIR TREE	36" BOX	M	7
	LOPHOSTEMON CONFERTUS	BRISBANE BOX	36" BOX	M	7
	PLATANUS X ACERIFOLIA 'COLUMBIA'	COLUMBIA LONDON PLANE TREE	36" BOX	M	4

SHRUB PLANTING SCHEDULE

	CONT./	WUCOLS	SPACING
	PLANT MIX 1		
	BACCHARIS PILULARIS 'PIGEON POINT' / PIGEON POINT COYOTE BRUSH	1 GAL, L	36" oc
	CEANOTHUS GRISEUS HORIZONTALIS 'YANKEE POINT' / YANKEE POINT CARMEL CREEPER	1 GAL, L	36" oc
	DIANELLA REVOLUTA 'LITTLE REV' / LITTLE REV FLAX LILY	1 GAL, L	18" oc
	DIETES BICOLOR / FORTNIGHT LILY	5 GAL, L	24" oc
	LANTANA MONTEVIDENSIS / PURPLE TRAILING LANTANA	5 GAL, L	48" oc
	PHLOMIS FRUTICOSA / JERUSALEM SAGE	5 GAL, L	36" oc
	SALVIA X 'ALLEN CHICKERING' / SAGE	5 GAL, L	42" oc
	WESTRINGIA FRUTICOSA 'SMOKEY' / SMOKEY WESTRINGIA	5 GAL, L	30" oc
	PLANT MIX 2		
	AGAVE ATTENUATA / FOXTAIL AGAVE	5 GAL, L	36" oc
	BOUTELOUA GRACILIS 'BLONDE AMBITION' / BLONDE AMBITION BLUE GRAMA	1 GAL, L	18" oc
	CAREX DIVULSA / EUROPEAN GREY SEDGE	1 GAL, L	18" oc

PLANTING NOTES

- FINAL LOCATIONS OF TREES TO BE DETERMINED. PENDING FINAL DESIGN OF UNDERGROUND UTILITY LINES. ALL TREES WILL BE PLANTED A MINIMUM OF 10' AWAY FROM ALL UNDERGROUND UTILITIES.
- PROVIDE 3" LAYER OF BARK MULCH IN ALL PLANTING AREAS.
- PROVIDE ROOT BARRIERS FOR TREES WITHIN 5' OF PAVING.

IRRIGATION LEGEND

	TREE BUBBLERS, TWO PER TREE, TYP.
	RECLAIMED WATER IRRIGATION SYSTEM POINT OF CONNECTION, REFER TO CIVIL PLANS AND NOTES BELOW
	SMART IRRIGATION CONTROLLER, PEDESTAL MOUNTED, MODEL TBD. PROVIDE 120V POWER

IRRIGATION NOTES

- ALL PLANTING AREAS SHALL BE IRRIGATED TO COMPLY WITH STATE OF CALIFORNIA MODEL WATER EFFICIENT LANDSCAPE ORDINANCE (MWELO) REGULATIONS.
- PROVIDE SELF-ADJUSTING WEATHER BASED IRRIGATION CONTROLLER IN A STAINLESS STEEL PEDESTAL ENCLOSURE
- THE LOCALLY AVAILABLE MUNICIPAL RECLAIMED WATER IRRIGATION SYSTEM IS TO BE UTILIZED FOR THIS PROJECT. THE CONTRACTOR SHALL DESIGN THE SYSTEM TO MEET THE REQUIREMENTS OF LA COUNTY PUBLIC HEALTH AND THE WEST BASIN MUNICIPAL WATER DISTRICT FOR RECLAIMED WATER IRRIGATION SYSTEMS.

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23007

DRAWING TITLE  
PLANTING  
PLAN

SCALE  
AS SHOWN


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BB


CHECKED  
DC,MSM

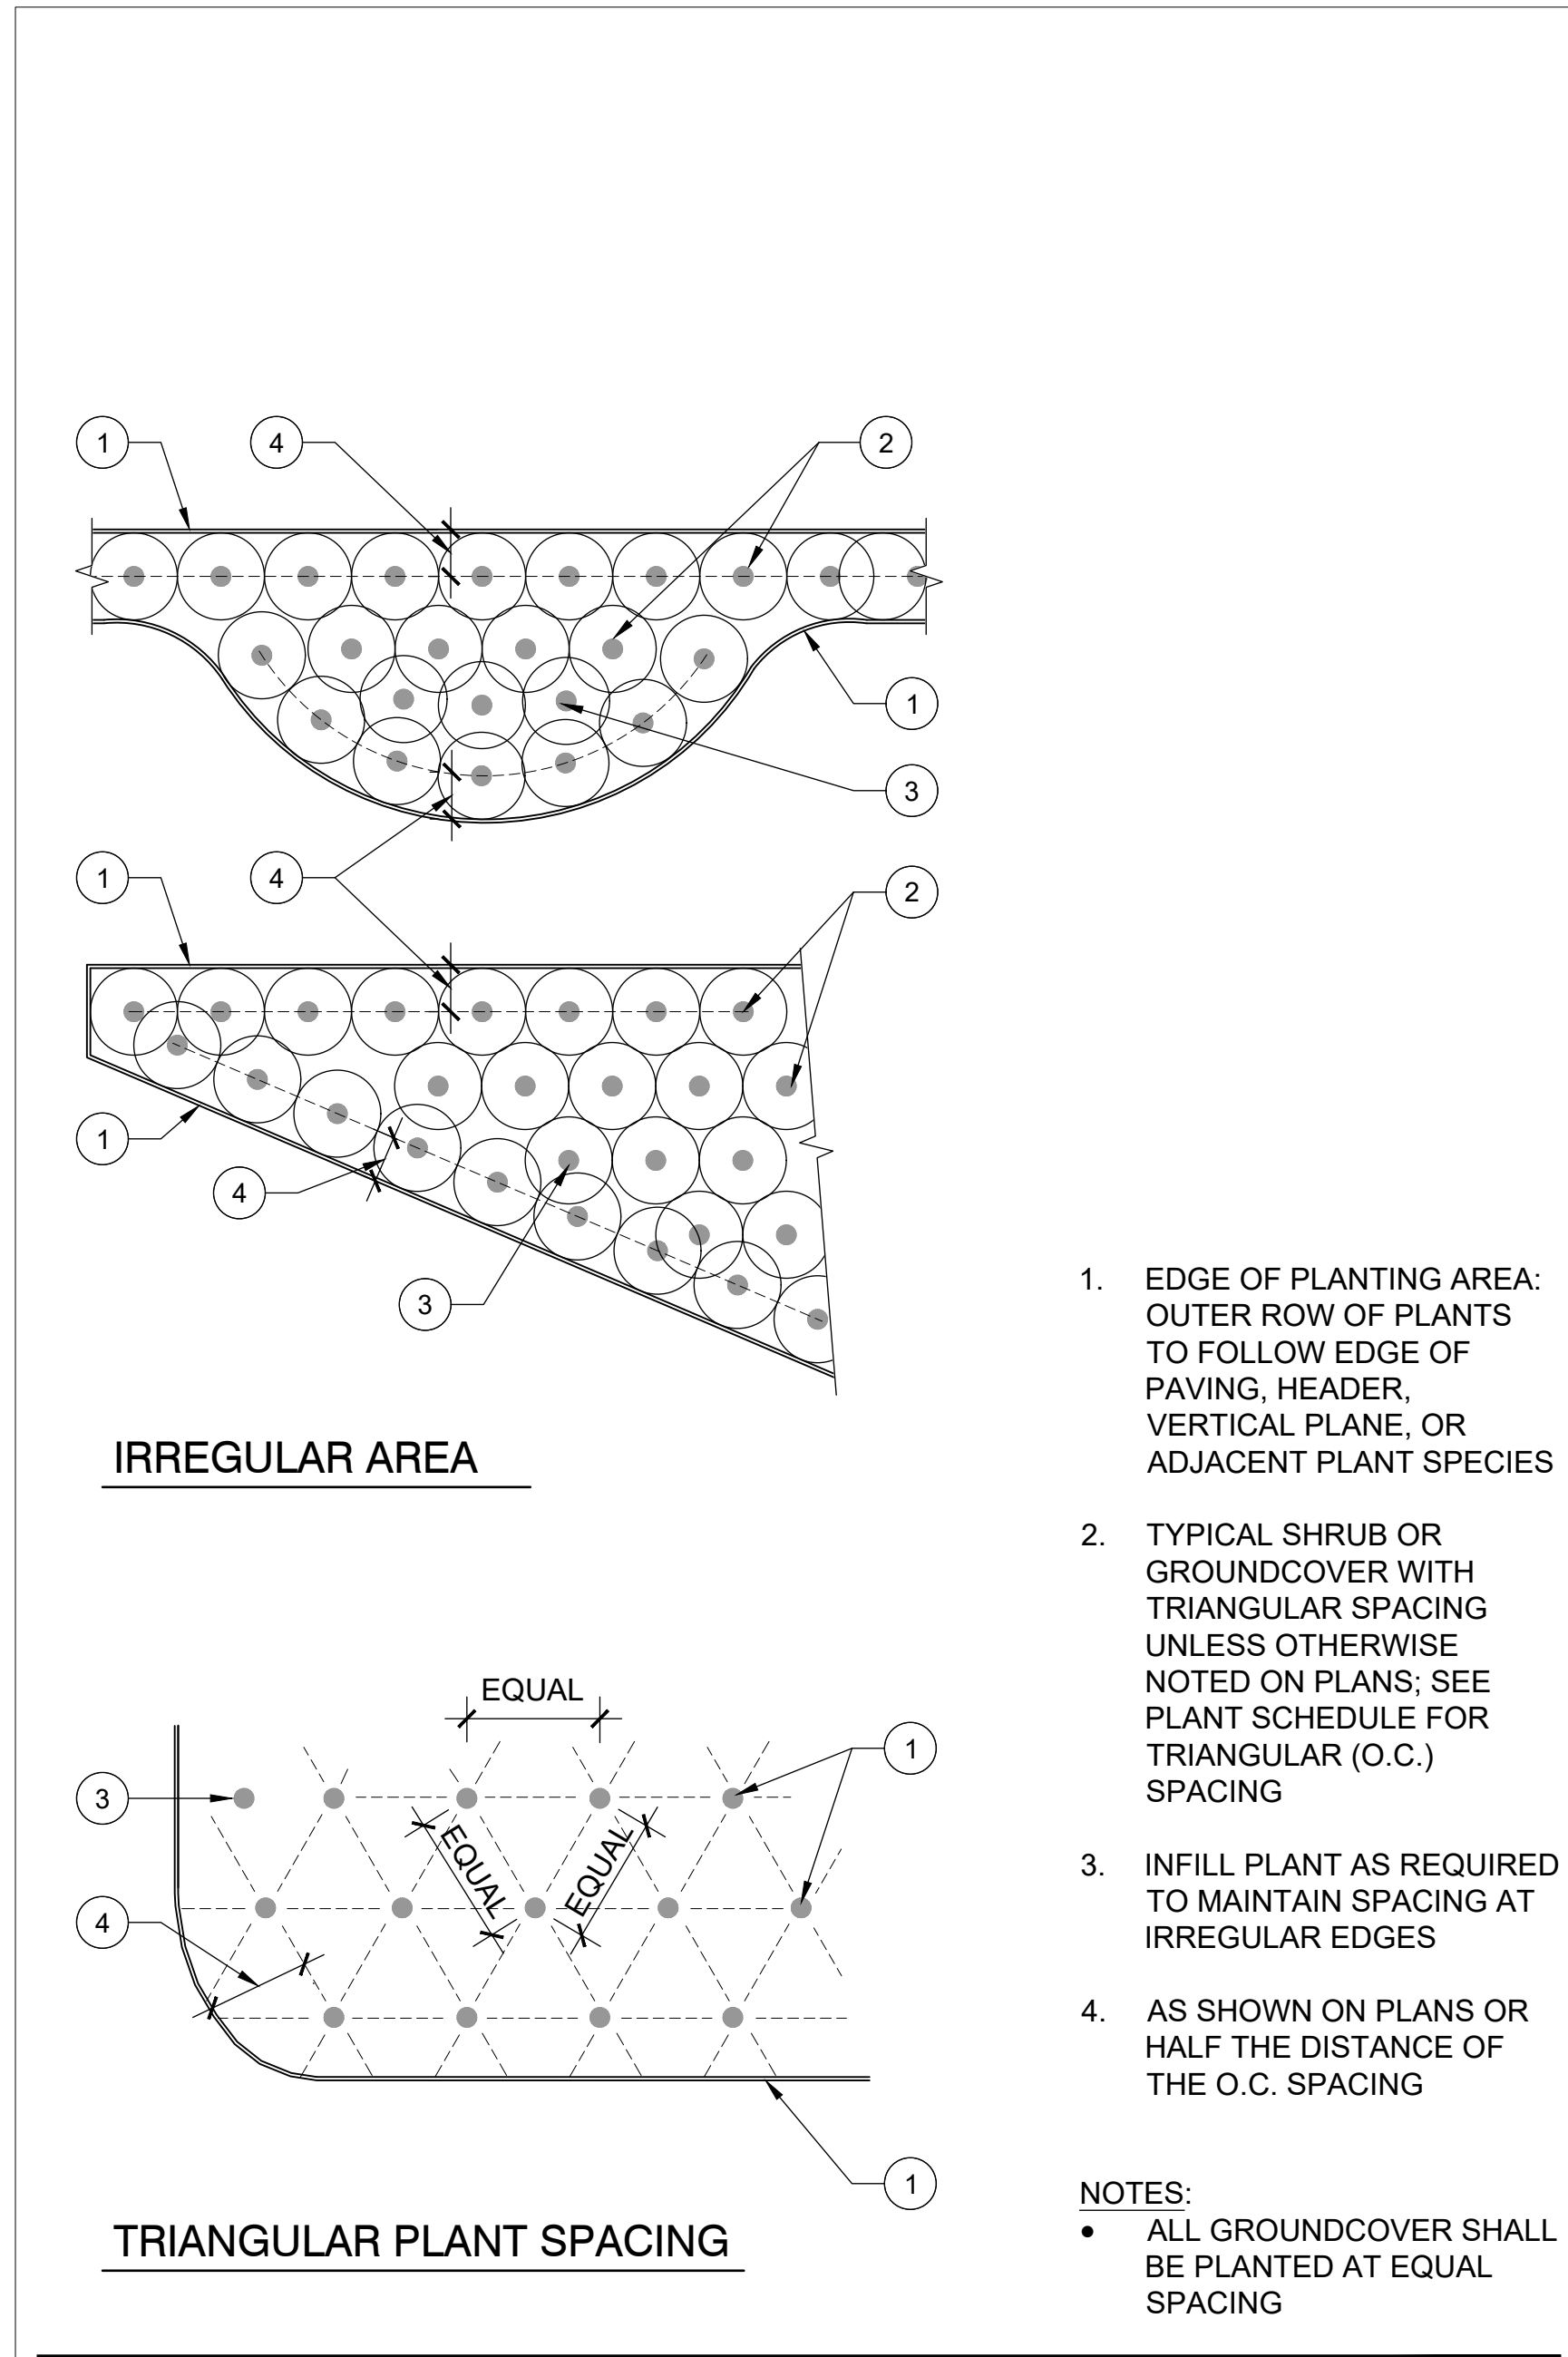SHEET NO.  
L200






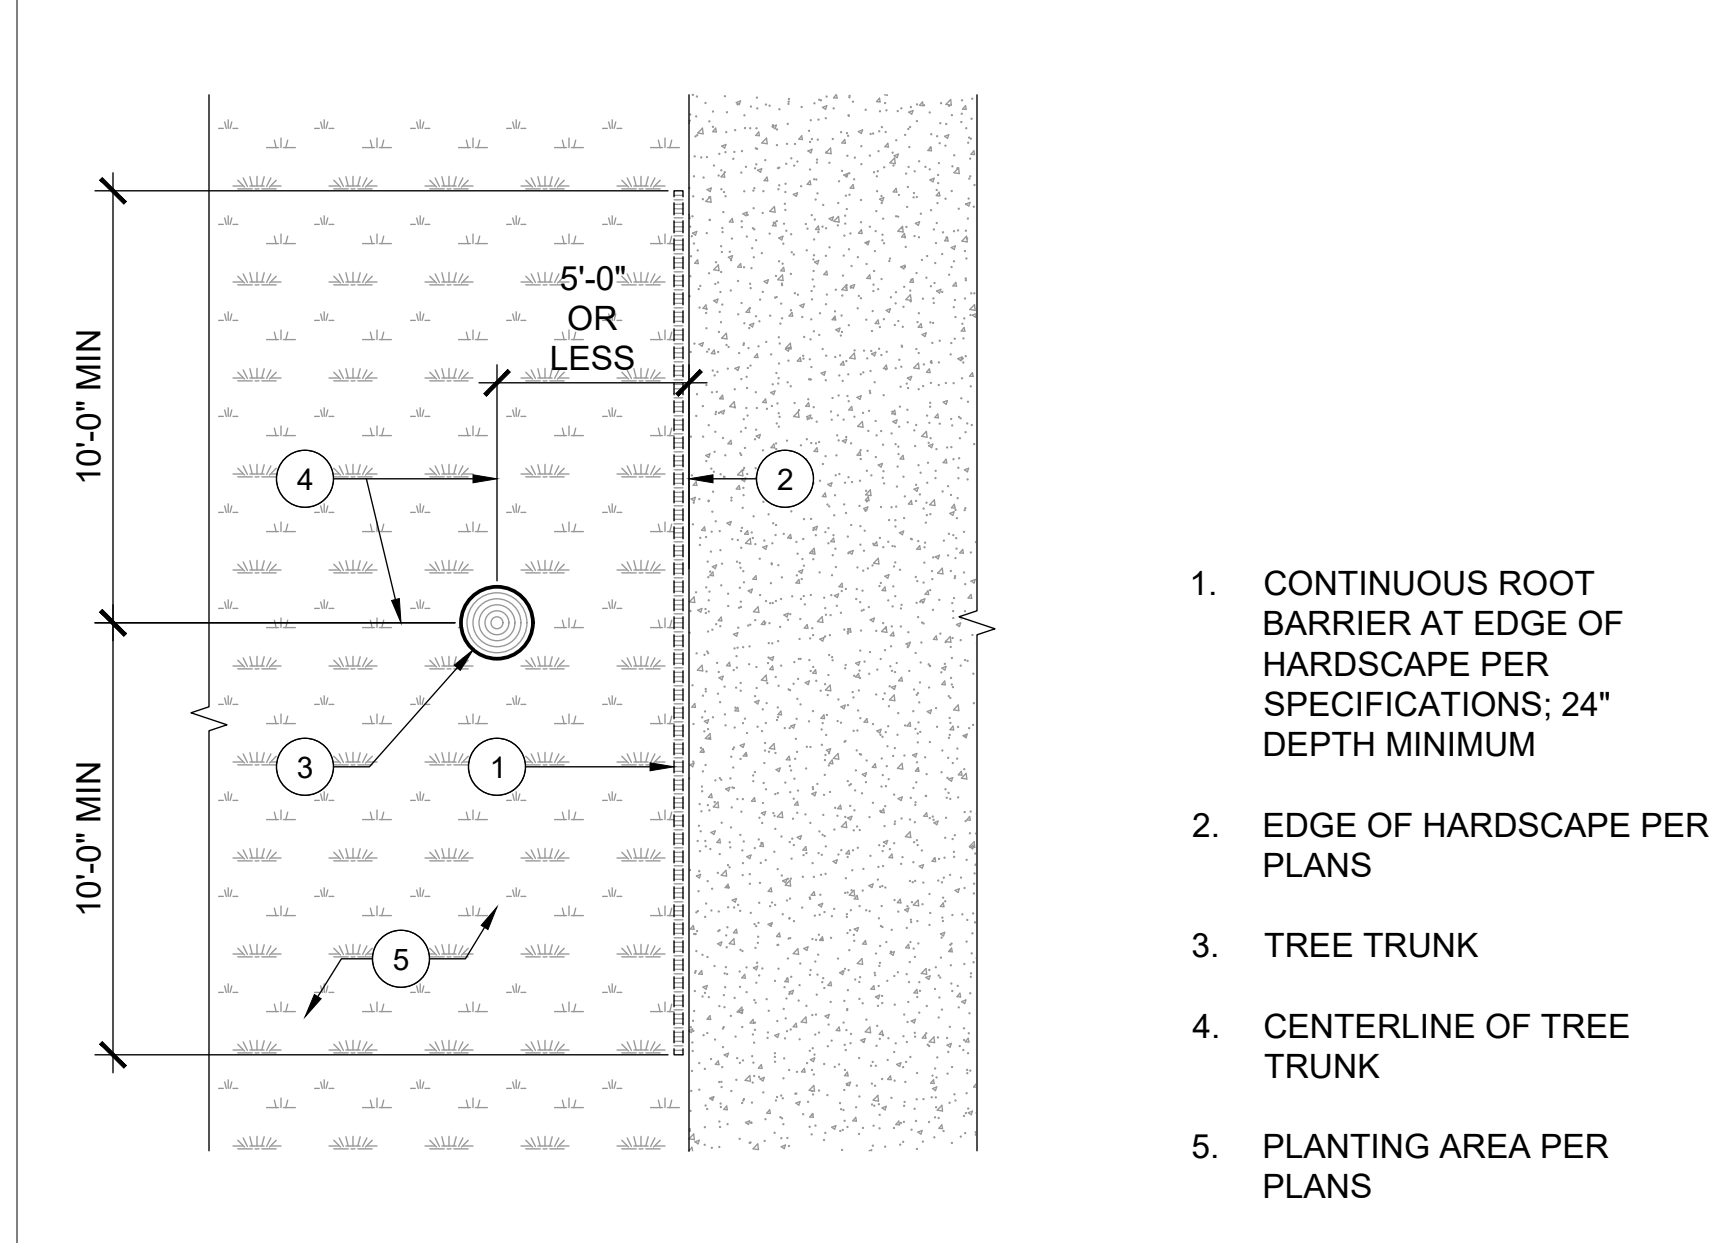
**14** SHRUB AND GROUNDCOVER SPACING NOT TO SCALE



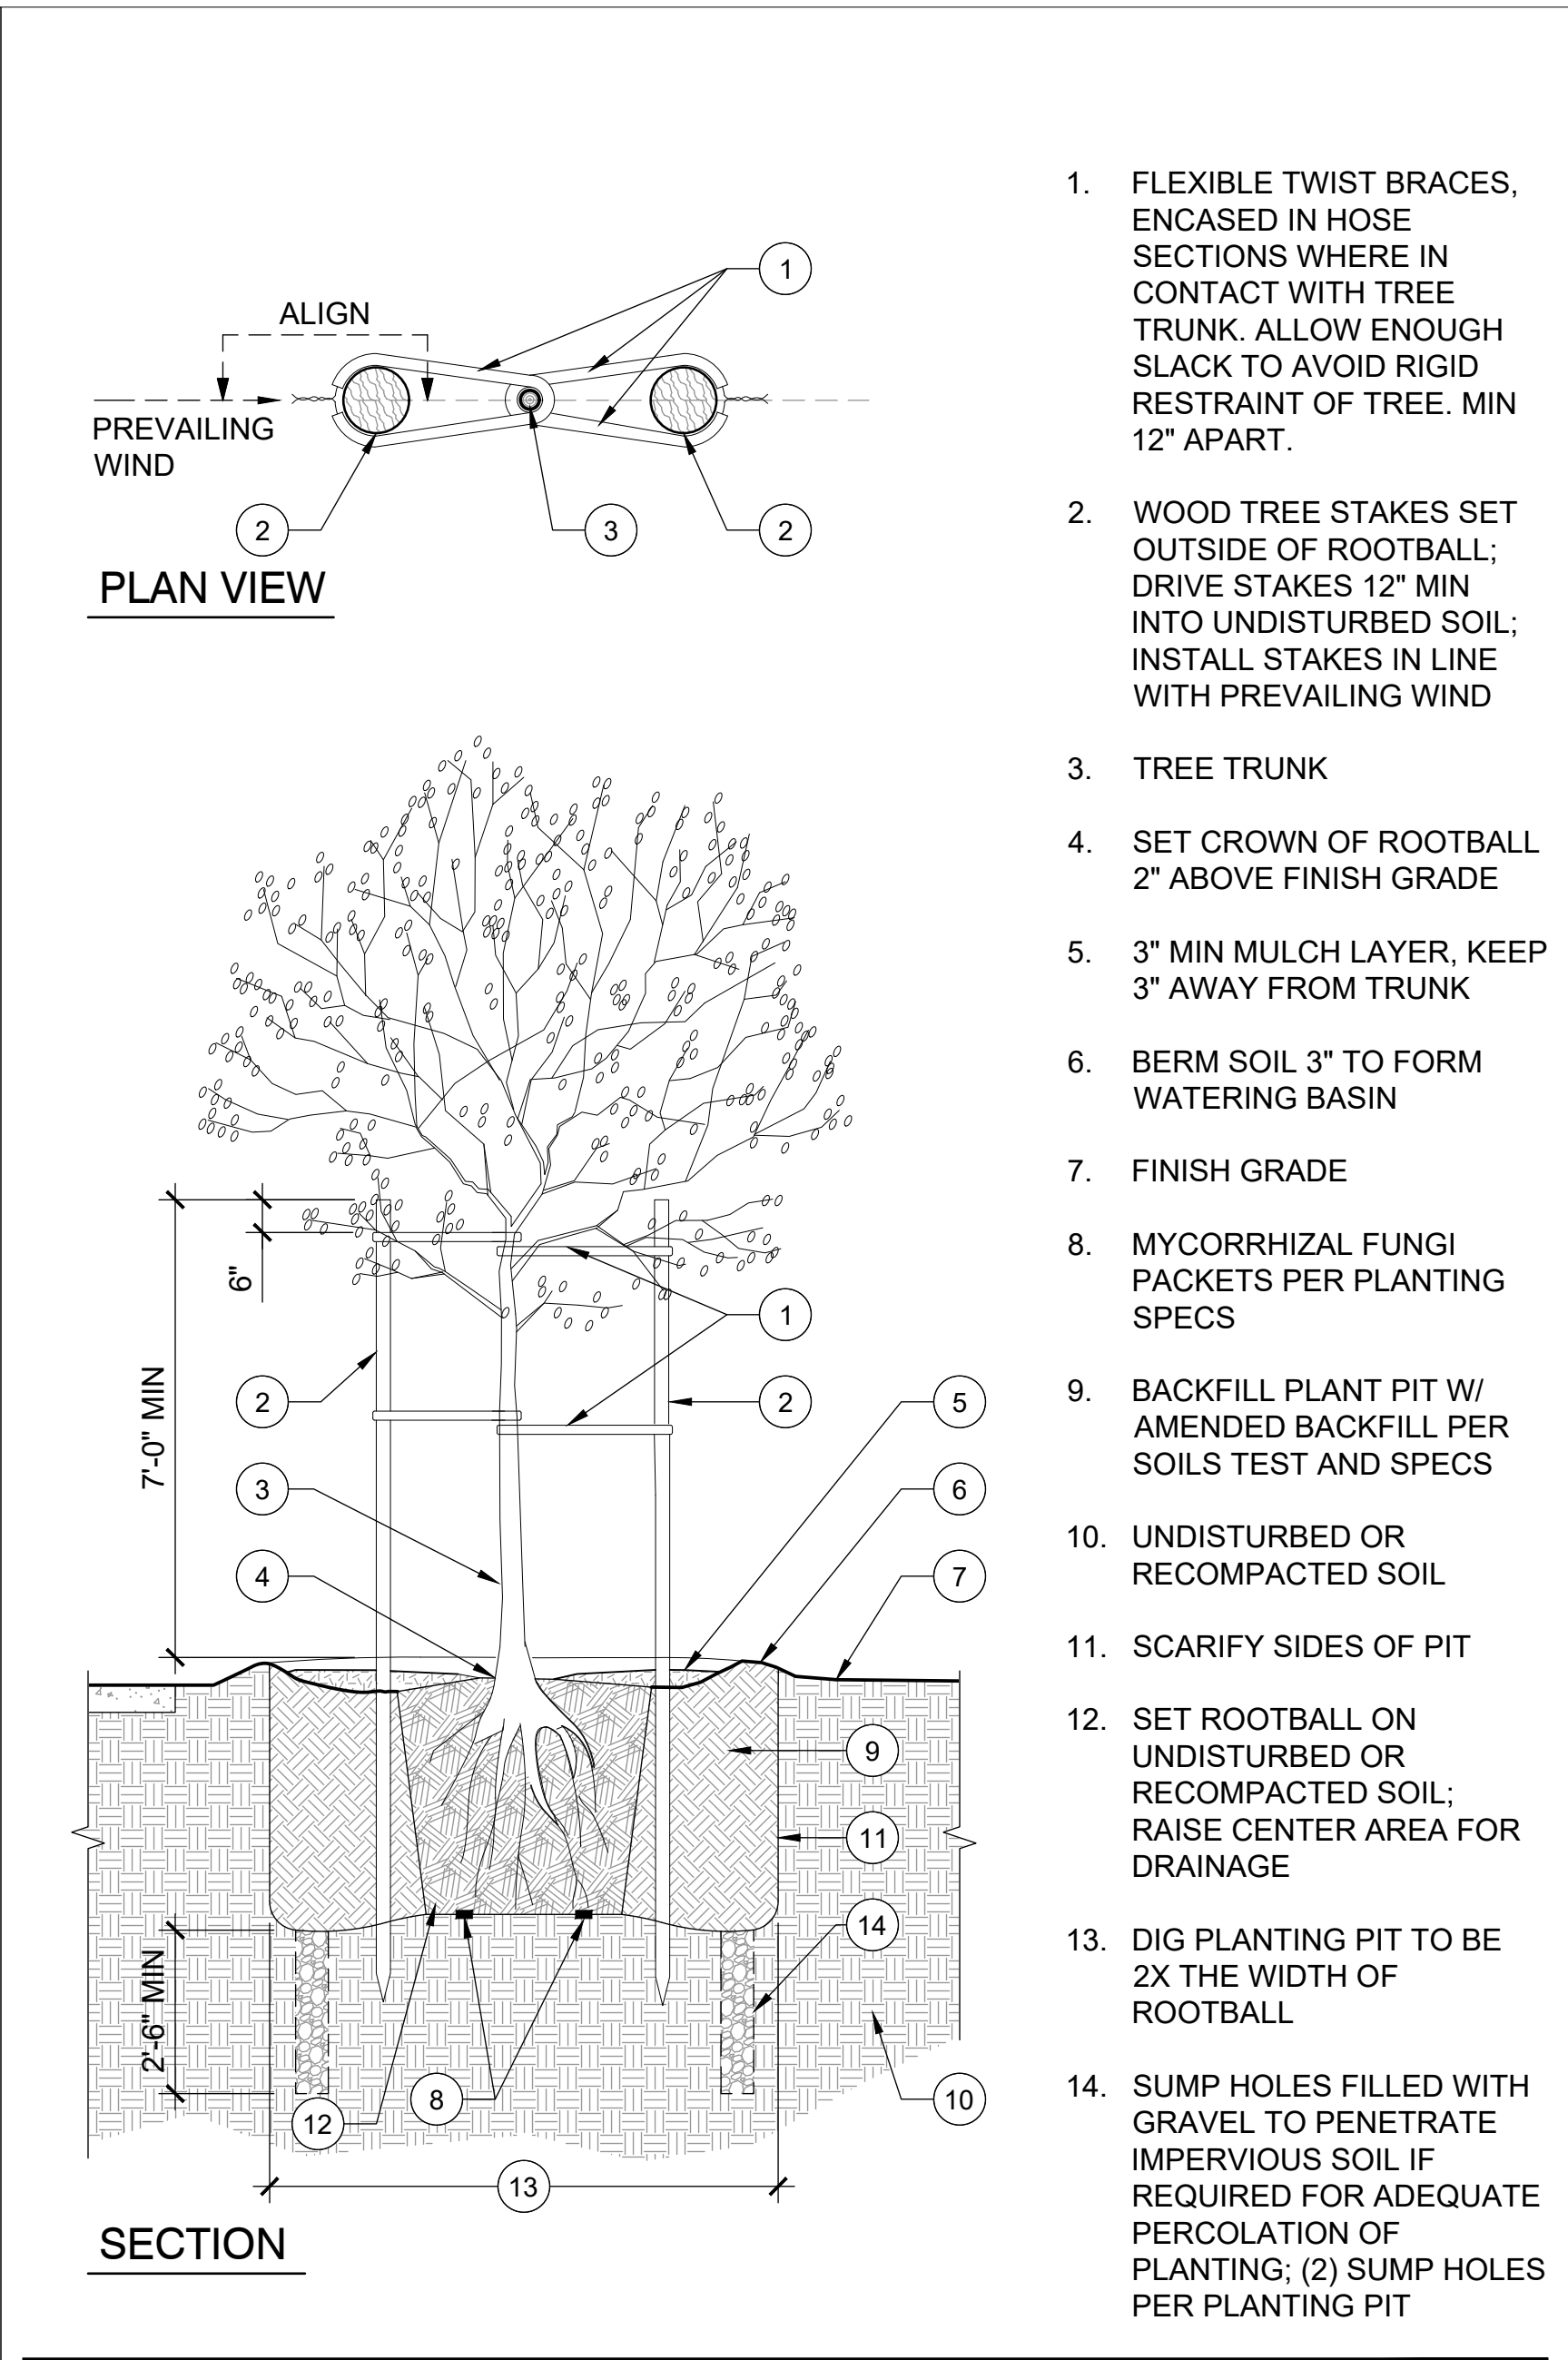**13** TYPICAL ROOT BARRIER (PLAN VIEW) NOT TO SCALE



**10** TREE PLANTING NOT TO SCALE

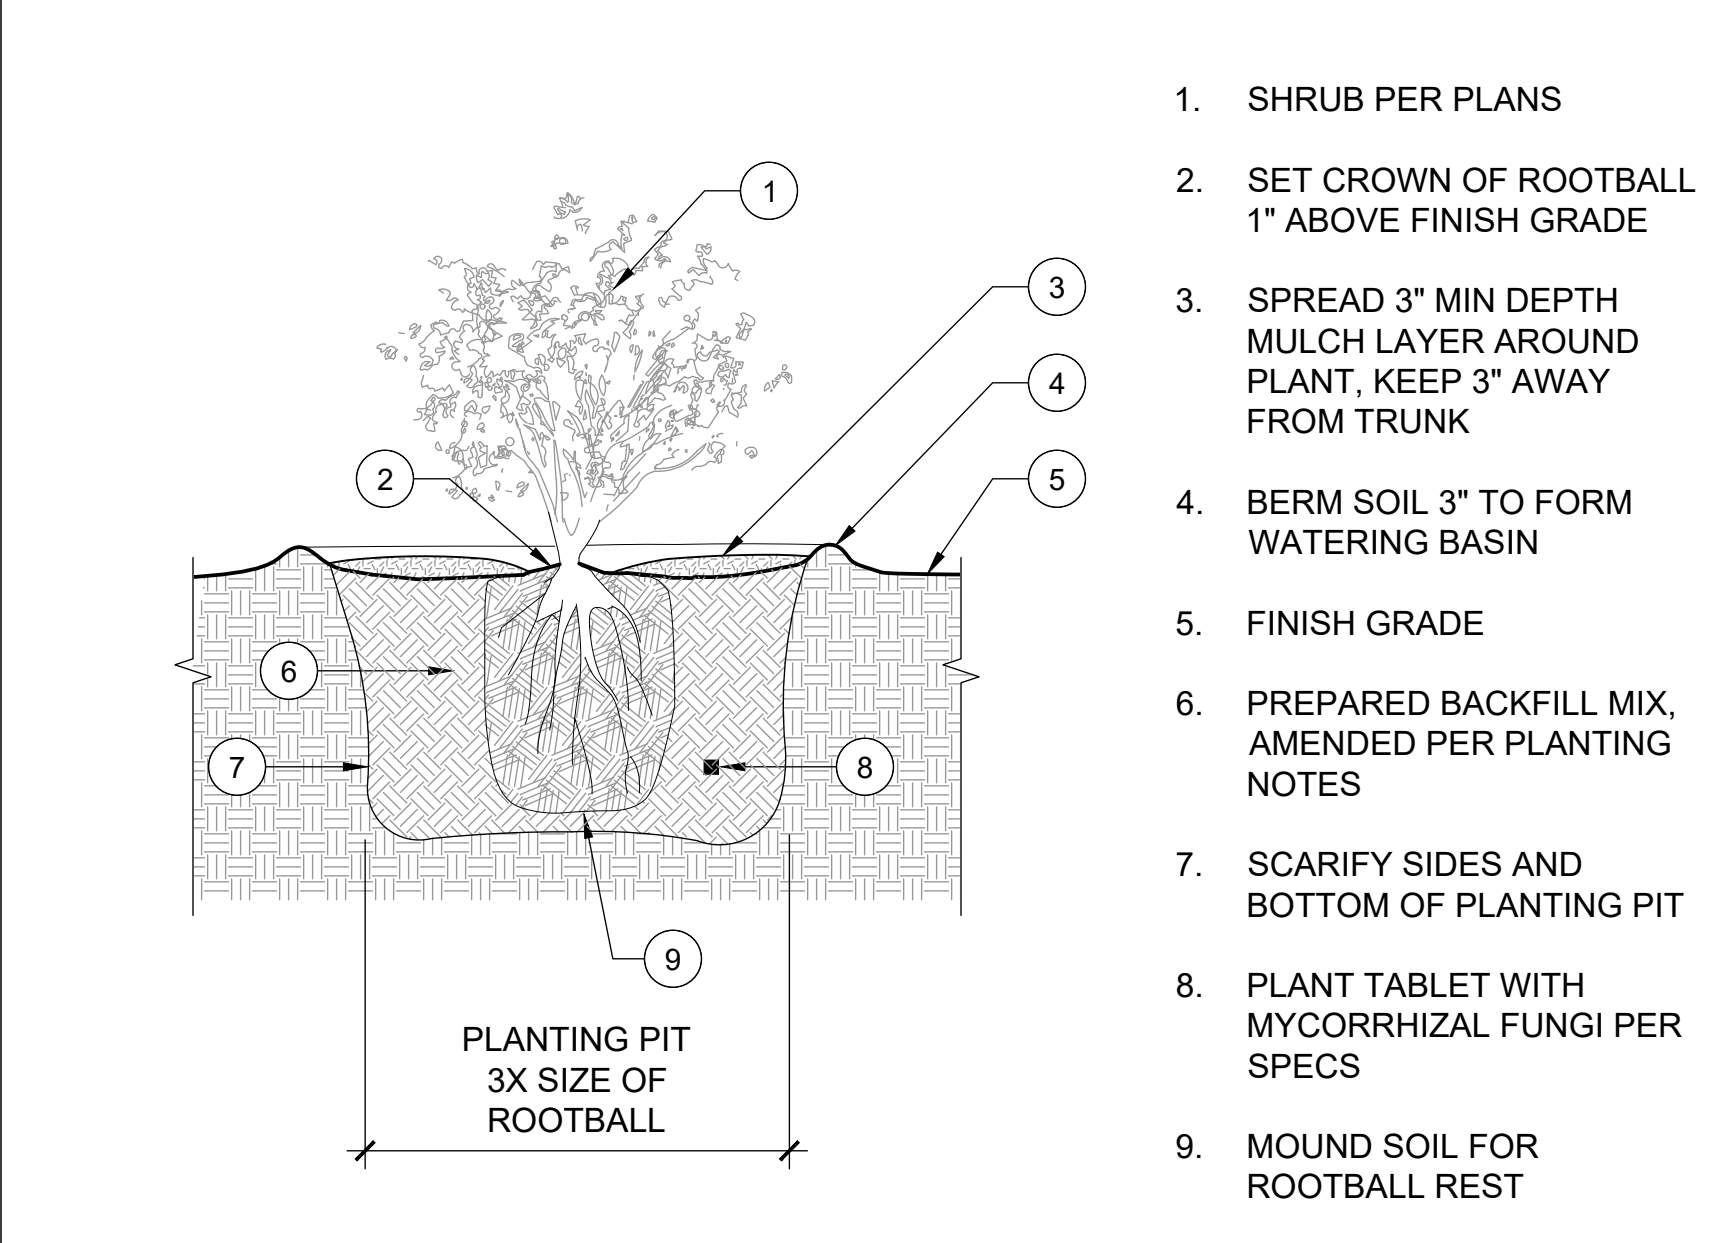

**9** SHRUB PLANTING NOT TO SCALE

AQUALINA PAVING STONES  
BY ANGELUS PAVING STONES

### Typical PICP System

**1** Pavers conform to ASTM C936. Installation by hand or machine

**2** Open-graded crushed stone recommended for all aggregates

**3** Edge restraint—concrete curbs

**4** Joint filling stone gradation: ASTM No. 8, 89, or 9

**5** 100% permeable surface

**6** Bedding gradation: ASTM No. 8

**7** Base gradation: ASTM No. 57

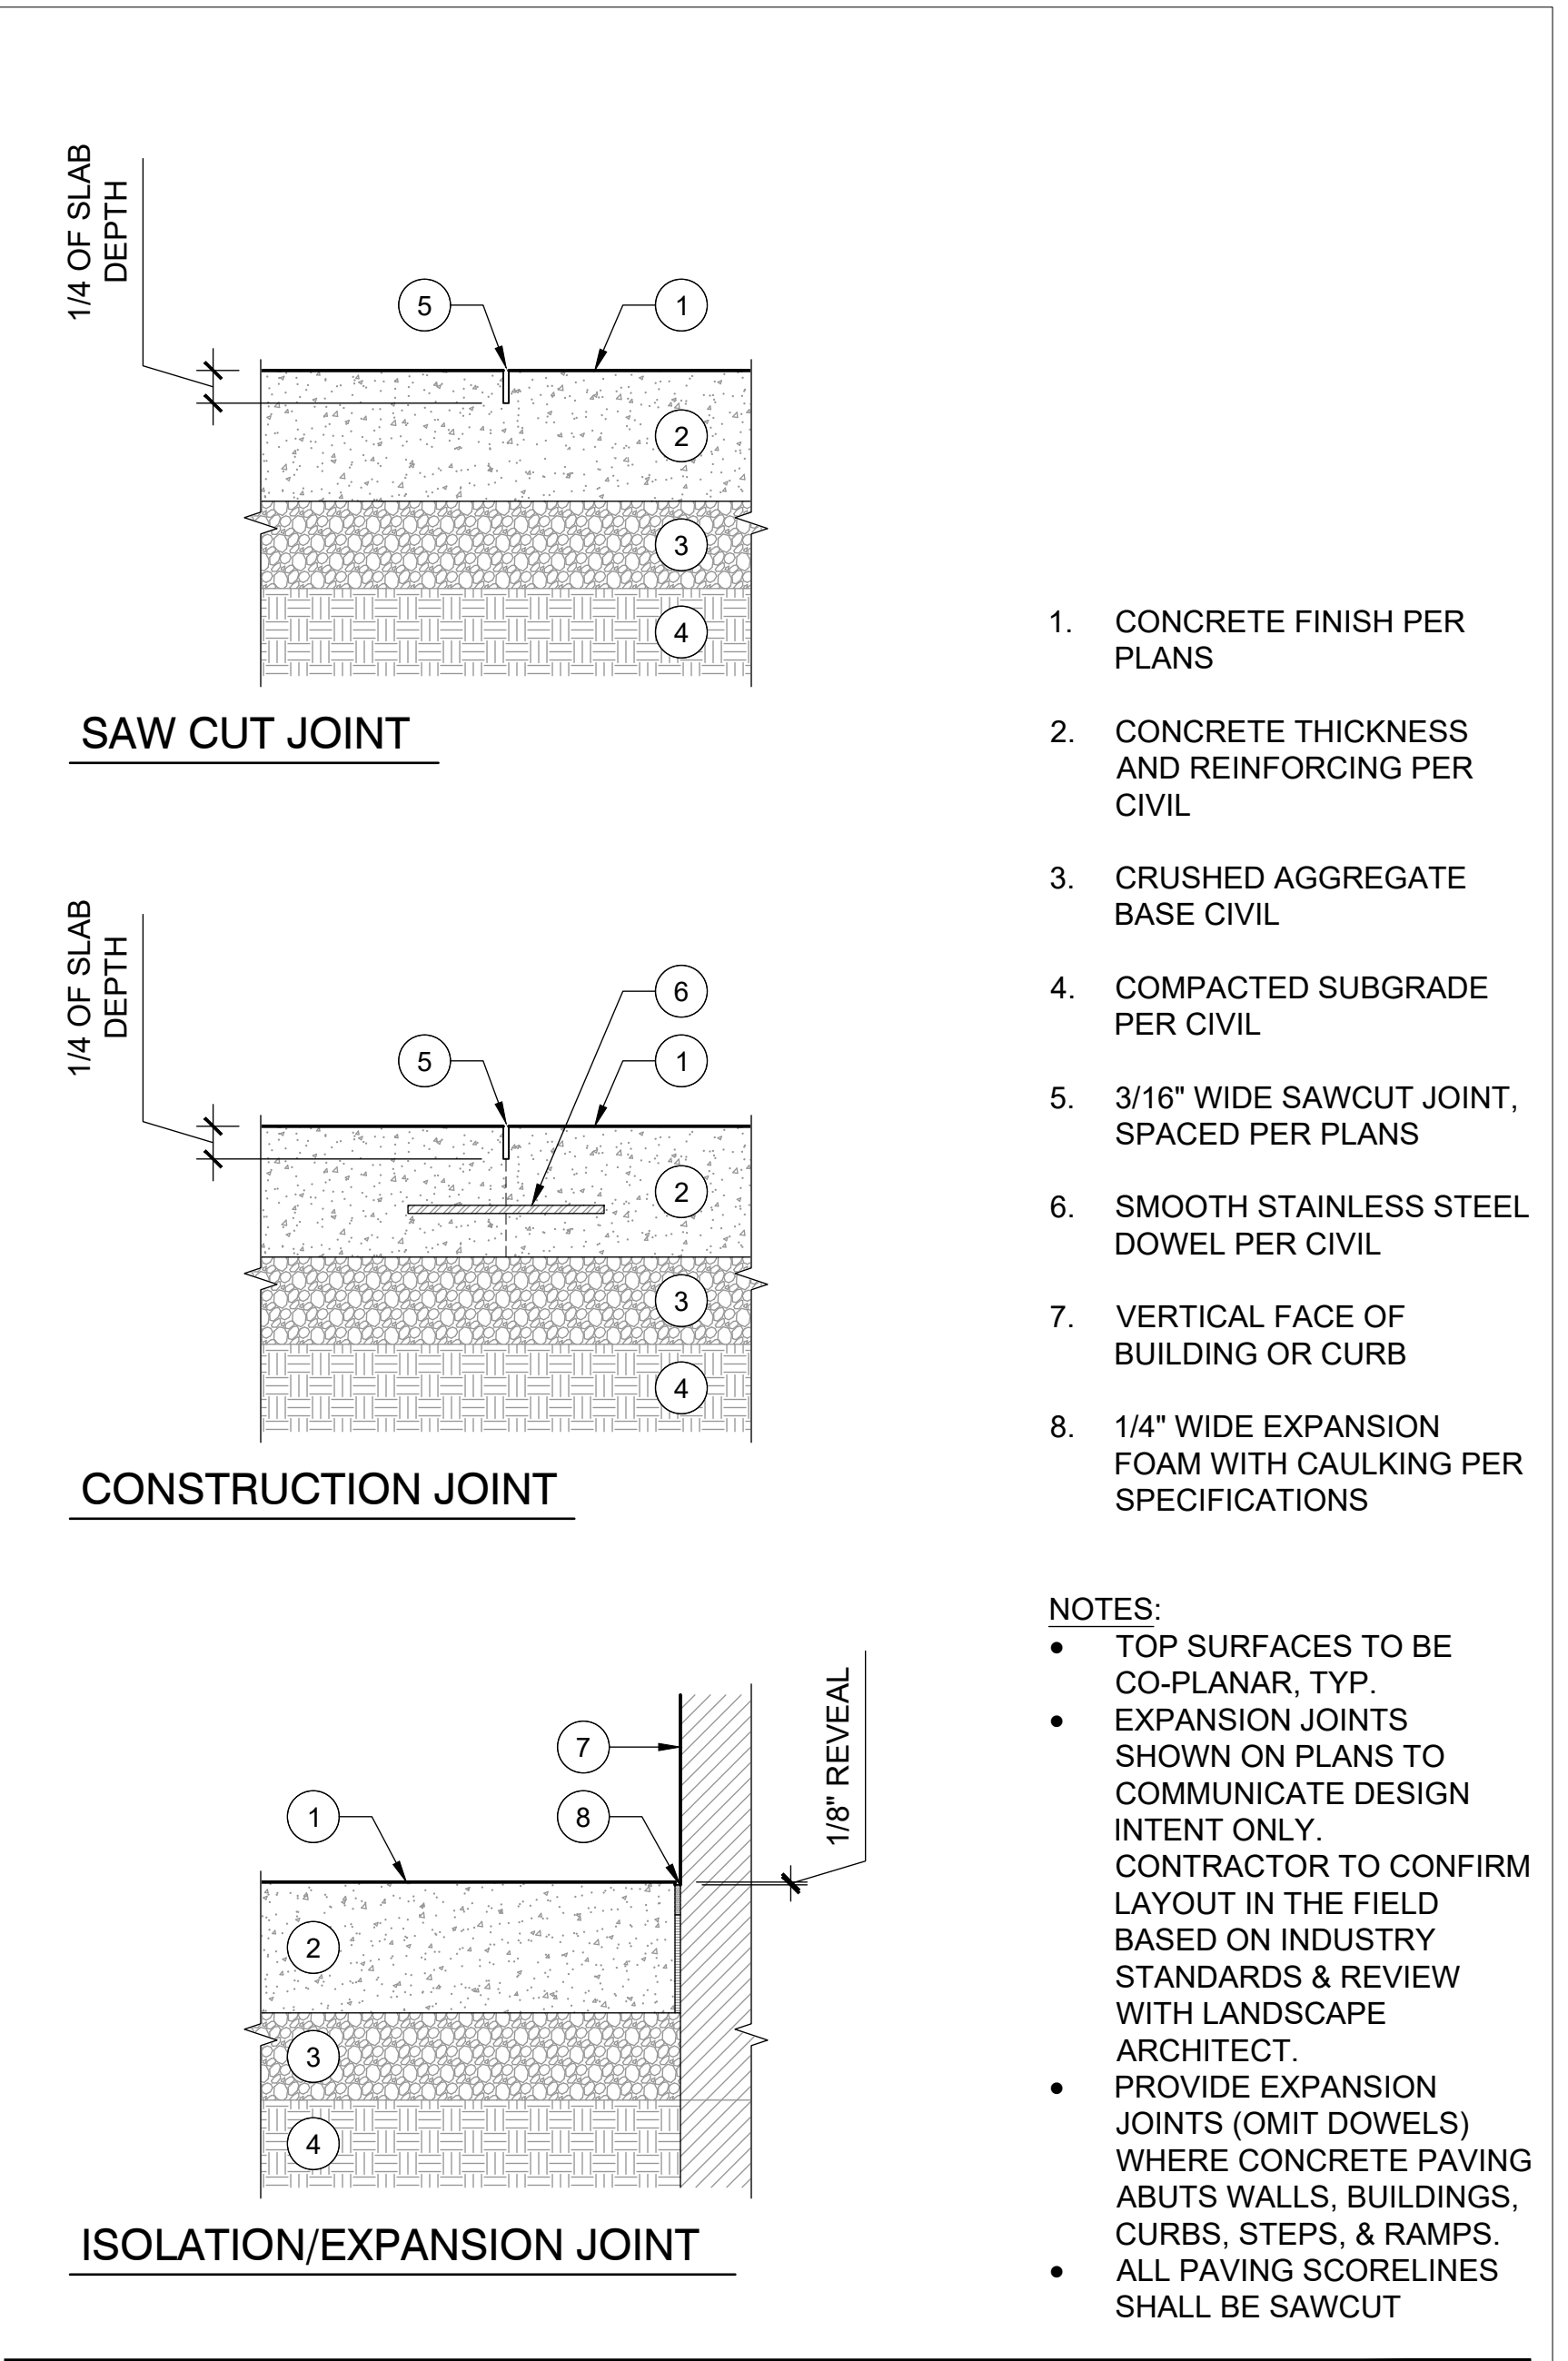
**8** Subbase gradation: ASTM No. 2, 3 or 4

**9** Optional geotextile: consult manufacturers for selection


**10** Under Drain as required

**11** Soil subgrade: classified per ASTM D2487; tested for permeability per ASTM D3385

**5** PERMEABLE PAVER (BASIS OF DESIGN) SCALE



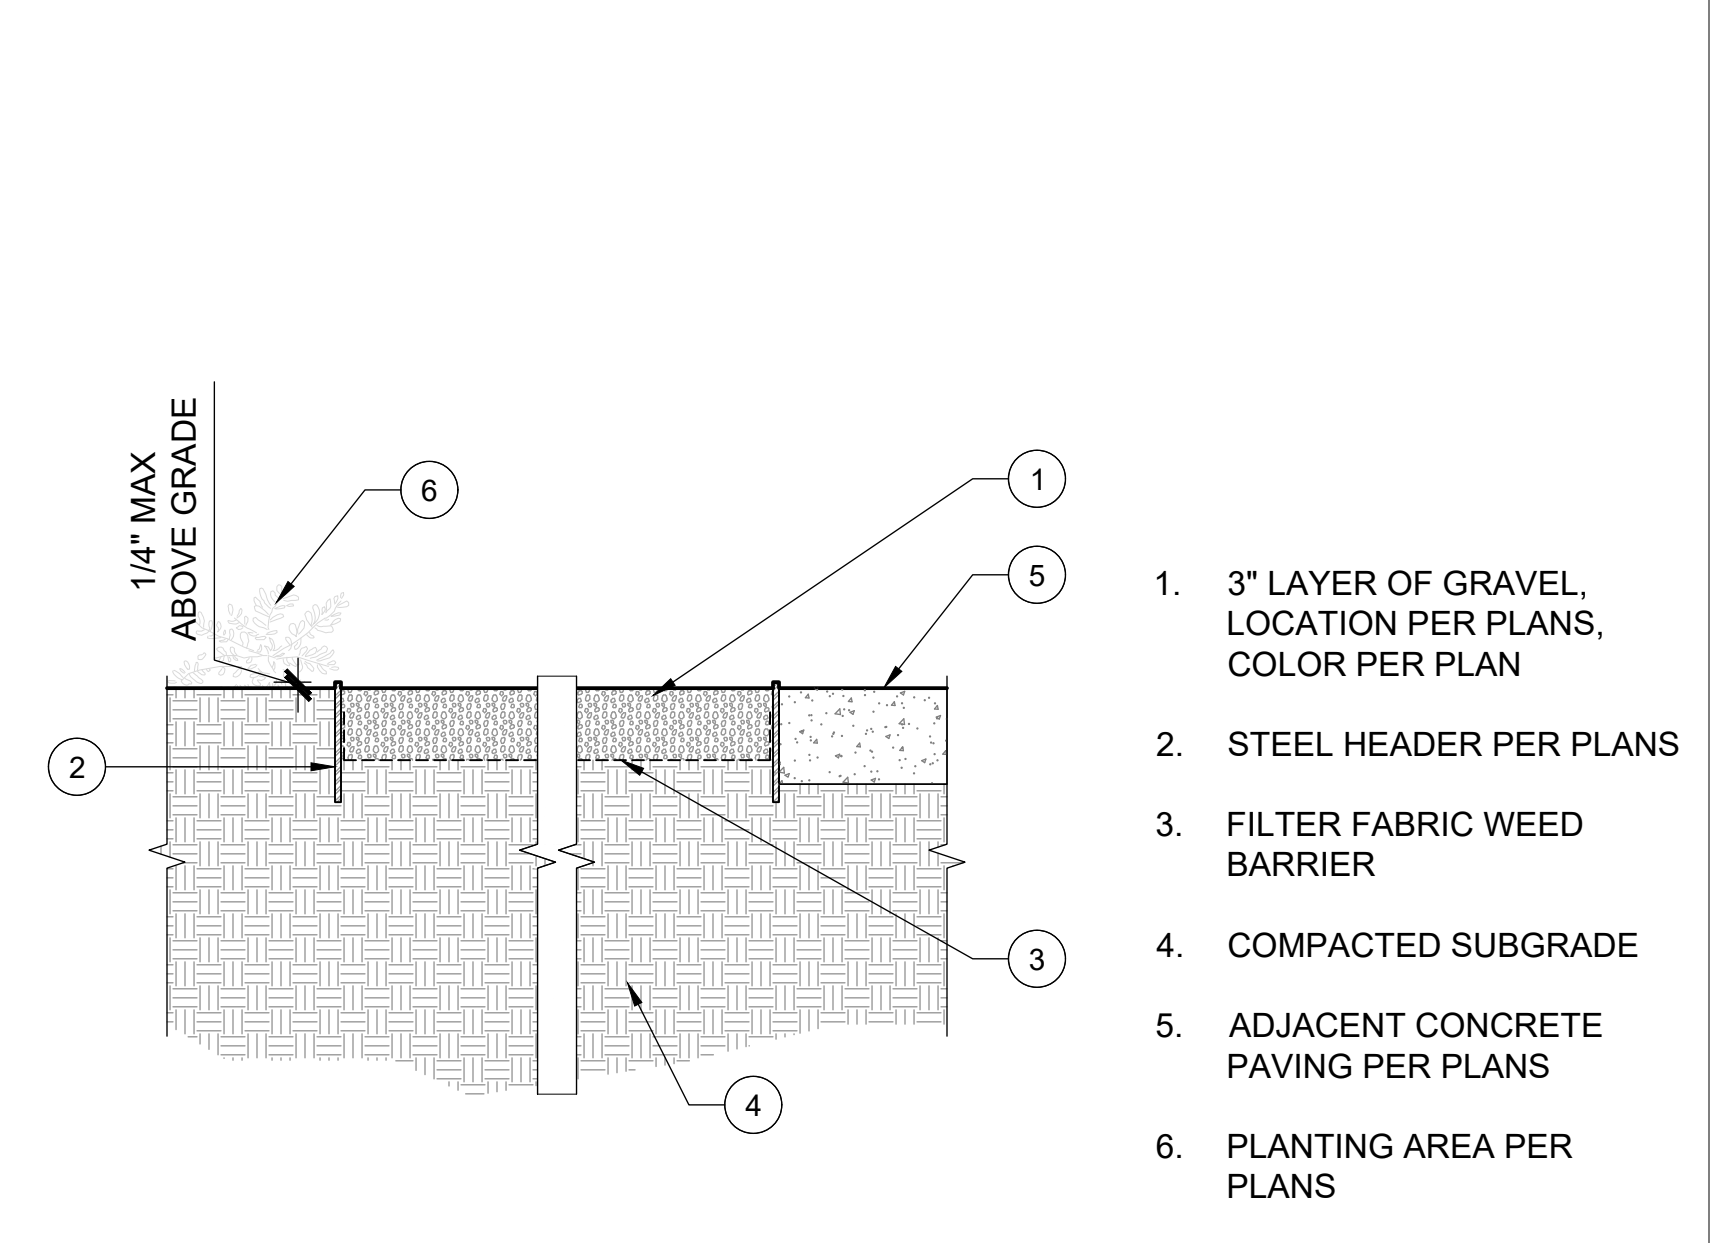**2** CONCRETE PAVING JOINTS 1 1/2" = 1'-0"



**1** GRAVEL MULCH 1 1/2" = 1'-0"





GENERAL NOTES  
1. REFER TO A101 FOR NOTES.

CAMPUS SITE PLAN  
SCALE: 1" = 40'

1

10' 40'

PLAN NORTH  
N

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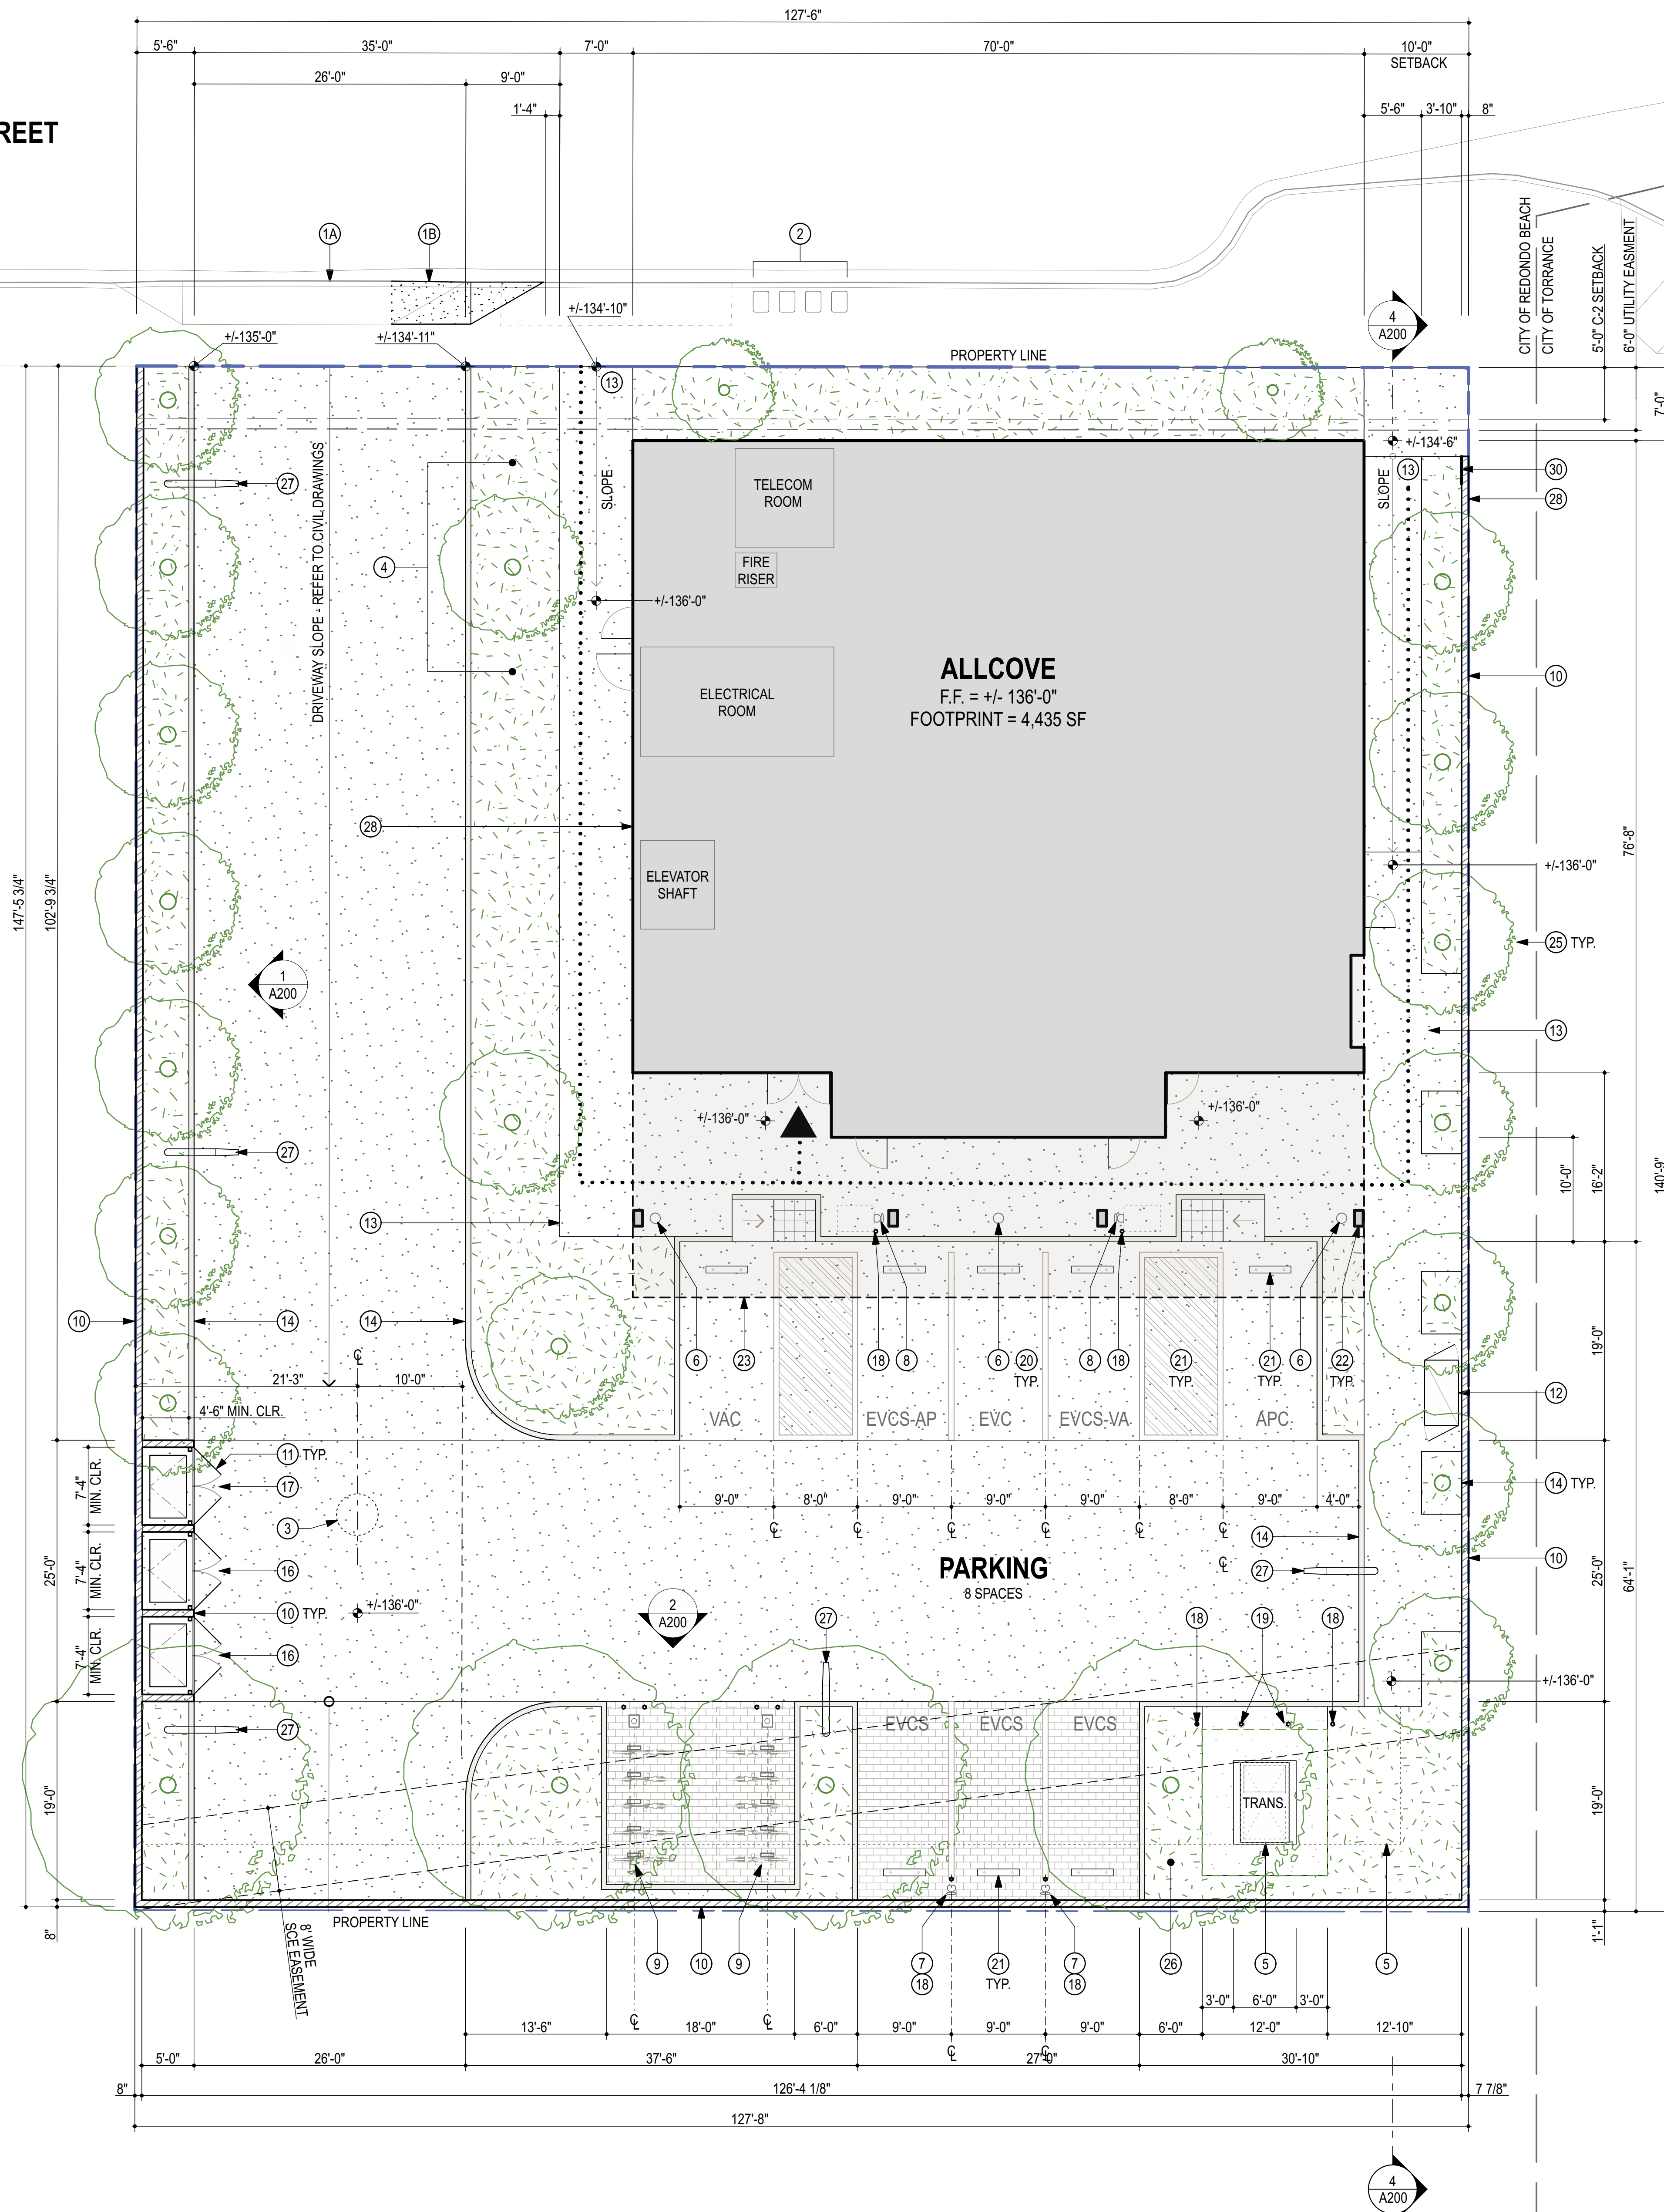
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NO.	DATE	REVISION
<b>allcove</b> BEACH CITIES HEALTH DISTRICT		
<b>100% PRELIMINARY DESIGN SUBMITTAL</b>		
PMA PROJECT NO. 23007		
DRAWING TITLE BCHD CAMPUS SITE PLAN		
SCALE 1" = 40'-0"		
DATE 02/28/2024		
DRAWN E.C.	CHECKED P.M.	
SHEET NO. A100		



BERYL STREET



#### SYMBOL LEGEND

- PLANTED AREA. REFER TO LANDSCAPE DWGS.
- CONC. PAVING REFER TO CIVIL + LANDSCAPE DWGS.
- PERMEABLE PAVERS REFER TO CIVIL + LANDSCAPE DWGS.
- BUILDING FOOTPRINT
- DETECTABLE WARNING STRIP
- SITE WALL / RETAINING WALL REFER TO CIVIL + STRUCT. DWGS.
- P.O.T. - PATH OF TRAVEL W/ ACCESSIBLE PATH TO THE PUBLIC RIGHT OF WAY

#### KEYNOTE LEGEND

- (1A) (E) CURB CUT.
- (1B) CURB CUT EXTENSION. REFER TO CIVIL DWGS.
- (2) METER / SERVICE CONNECTION. REFER TO CIVIL DWGS.
- (3) (E) OIL WELL CAPPED BELOW GRADE TO REMAIN.
- (4) UTILITY RISERS AT PLANTER AREA. REFER TO CIVIL AND LANDSCAPE DWGS.
- (5) ELEC. TRANSFORMER W/ CONC. VAULT. REFER TO ELEC. DWGS.
- (6) EV READY CHARGER BOX REFER TO ELEC. DWGS.
- (7) WALL MTD. ELECTRIC VEHICLE CHANGING EQUIPMENT. REFER TO ELEC. DWGS.
- (8) PEDESTAL ELECTRICAL VEHICLE CHANGING EQUIP. W/ BOLLARD. REFER TO ELEC. DWGS.
- (9) AUTOMATED BIKE PARKING SYSTEM W/ E-BIKE CHARGING. REFER TO ELEC. DWGS.
- (10) CONCRETE SITE RETAINING WALL / SITE WALL W/ FIN. + SEAL REFER TO A200, STRUCT. + CIVIL DWGS.
- (11) PTD. STEEL LOUVERED SWING GATES SECURED TO PTD. STL POST OR CONC. WALL
- (12) SLAB MTD. BICYCLE LOCKER
- (13) CONC. SLOPED WALKWAY. 1:20 MAX SLOPE. REFER TO CIVIL DWGS.
- (14) CURB. REFER TO CIVIL DWGS.
- (15) PLANTER AREA. REFER TO LANDSCAPE DWGS.
- (16) 3 CUBIC YARD TRASH DUMPSTER W/ IN 72" HIGH TRASH ENCLOSURE.
- (17) 3 CUBIC YARD RECYCLING DUMPSTER W/ IN 72" HIGH TRASH ENCLOSURE.
- (18) 48" H. PTD. STL. BOLLARD
- (19) 48" H. PTD. STL. REMOVABLE BOLLARD
- (20) 9'-0" WIDE BY 19' DEEP PARKING STALLS W/ WHEEL STOP REFER TO PARKING STALL TYPES + G003 FOR PARKING TABLE.
- (21) 8'-0" WIDE BY 19' DEEP ADA ACCESSIBLE AISLE
- (22) BUILDING COLUMN. REFER TO A111
- (23) BUILDING OVERHANG ABOVE. REFER TO A111
- (24) 30" X 48" CLEAR AREA
- (25) TREE. REFER TO LANDSCAPE DWGS.
- (26) IRRIGATION CONTROLS. REFER TO LANDSCAPE DWGS.
- (27) LIGHT POLE. REFER TO ELEC. DWGS.
- (28) BUILDING IDENTIFICATION SIGNAGE
- (29) BUS STOP LOCATION SHOWN FOR REFERENCE
- (30) PTD. AL. SIGN MONUMENT ON CONC BASE

#### PARKING STALL TYPES

REFER TO G003 FOR TABLE

- AP ACCESSIBLE PARKING SPACES
- VA VAN ADA ACCESSIBLE PARKING SPACES
- EVC ELECTRIC VEHICLE CAPABLE PARKING SPACES
- EVCS ELECTRIC VEHICLE CHARGING STATIONS
- EVCS-AP EV CHARGING STATION ADA ACCESSIBLE SPACES
- EVCS-VA EV CHARGING STATION ADA VAN ACCESSIBLE SPACES

#### GENERAL NOTES

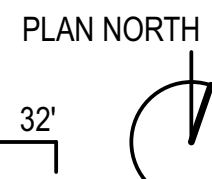
- PROJECT ZERO NOTED AS EL. 0'-0" EQUALS 136.00' U.N.O.
- REFER TO CIVIL DWGS. REFER TO CIVIL DWGS. FOR OFF-SITE WORK REQUIRED IN PUBLIC WAY.
- REFER TO CIVIL DWGS. FOR SITE DEMOLITION, UTILITIES, GRADING INFO., FOR FIRE HYDRANT LOCATIONS, POST INDICATOR VALVE LOCATIONS, FIRE DEPARTMENT CONNECTION AND FIRE SPRINKLER RISER & LOCATION OF SITE AND BUILDING ELEMENTS.
- REFER TO CIVIL + LANDSCAPE DWGS. FOR HARDSCAPE.
- REFER TO LANDSCAPE AND IRRIGATION DWGS. FOR NEW + (E) LANDSCAPE INFO, FOR PLANT PROTECTION.

SITE PLAN

SCALE: 1/8" = 1'-0"

1

2' 8' 32'



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BEACH CITIES  
HEALTH DISTRICT

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23007

DRAWING TITLE

SITE PLAN

SCALE  
1/8" = 1'-0"


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E.C. P.M.

SHEET NO.

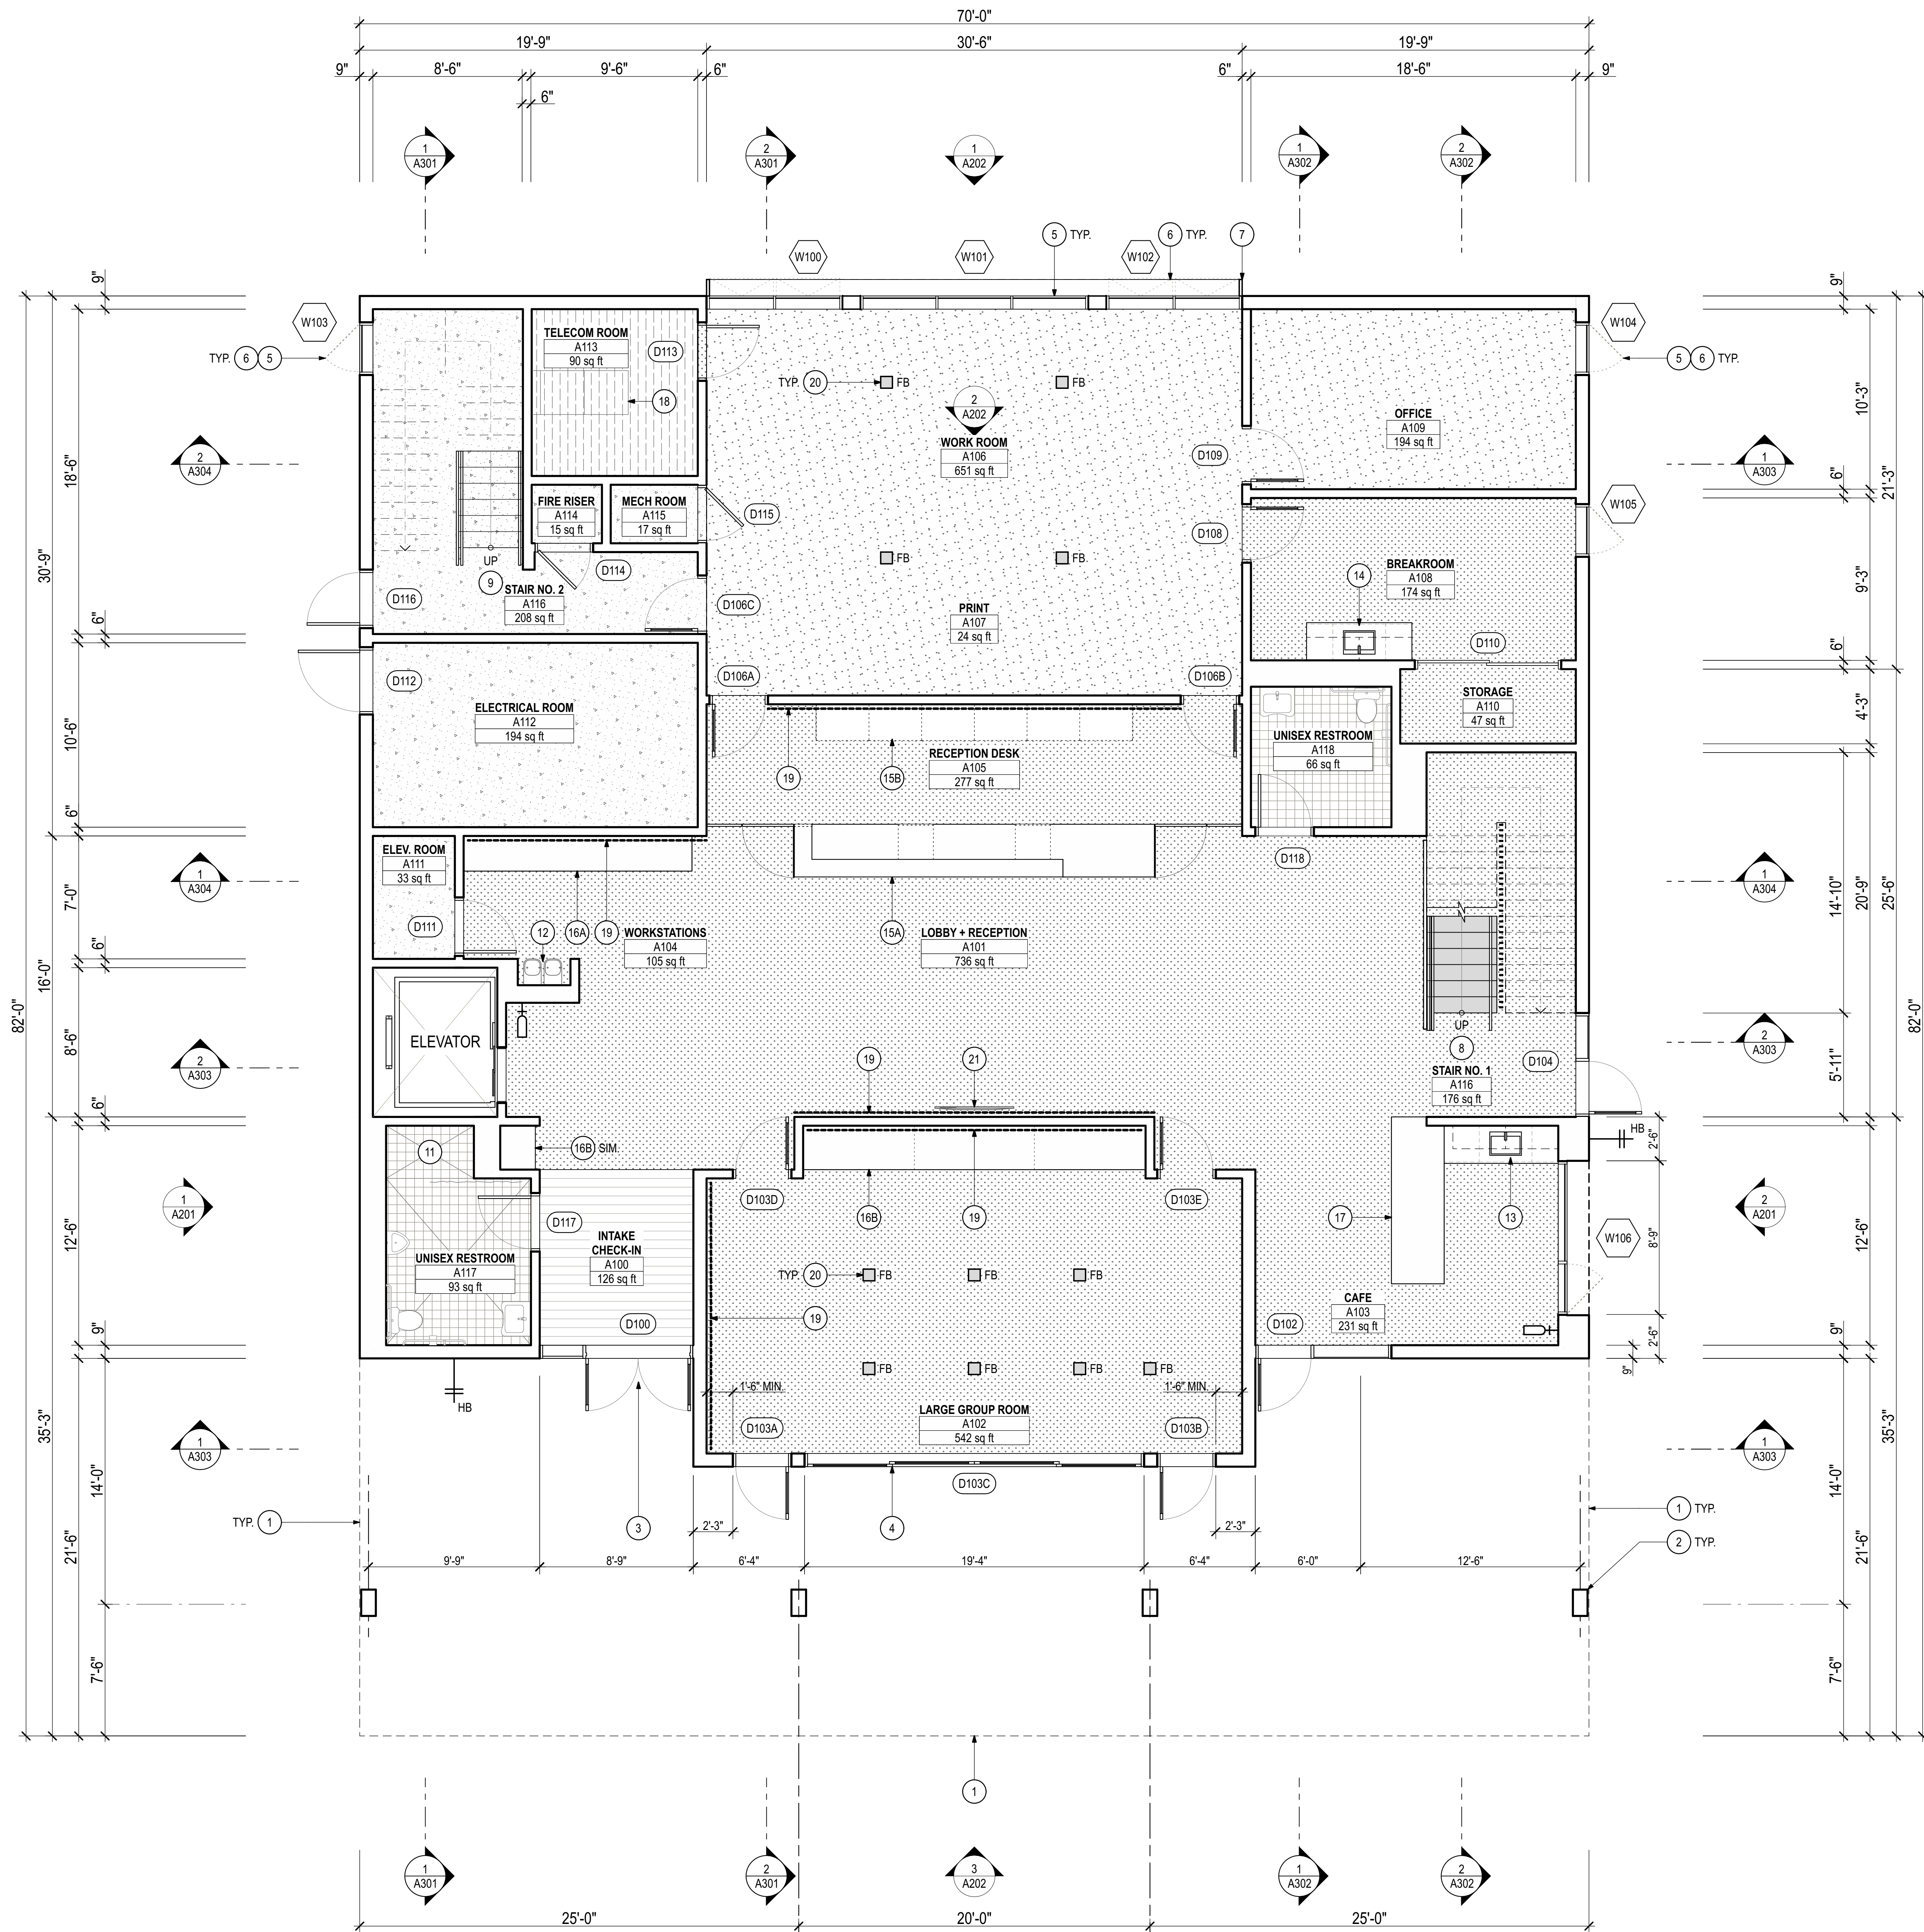A101





#### SYMBOL LEGEND

- PROFILE OF BUILDING ABV.
- ACOUSTICAL WALL COVERING
- SEALED CONCRETE FLOOR FINISH
- CONCRETE FLOOR WITH STATIC CONTROL EPOXY FLOORING
- CARPET TILE FLOOR FINISH
- LUXURY VINYL TILE (LVT) FLOOR FINISH
- RUBBER FLOOR FINISH AT STAIR NO. 1
- QUARRY TILE SLOPE MAX 2% TO DRAIN
- RECESSED ENTRANCE FLOOR GRILLE
- RECESSED FIRE EXTINGUISHER CABINET
- HOSE BIB. REFER TO PLUMB. DWGS.

#### KEYNOTE LEGEND

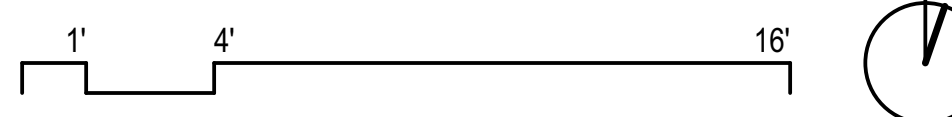
- 1 PROFILE OF BLDG. ABV.
- 2 STL. COLUMN W/ METAL COLUMN COVER.
- 3 PTD. ALUM./GLASS POWER ASSIST ENTRY DOORS
- 4 PTD. ALUM./GLASS 4 PANEL SLIDING DOOR
- 5 PTD. ALUM./GLASS CURTAINWALL WINDOW SYSTEM
- 6 PTD. ALUM. OPERABLE WINDOW AT CURTAINWALL SYSTEM
- 7 EXTENDED COVER CAP AT CURTAINWALL SYSTEM.
- 8 STAIR #1 - STEEL STAIR W/ CONC. FILL STEEL TREADS W/ RUBBER FINISH
- 9 STAIR #2 - STEEL STAIR W/ CONC. FILL STEEL TREADS
- 10 NOT USED.
- 11 ACCESSIBLE SHOWER. REFER TO PLUMB. DWGS.
- 12 DRINKING FOUNTAIN AND BOTTLE FILLER.
- 13 SERVICE SINK AT CAFE. REFER TO PLUMB. DWGS.
- 14 BREAKROOM CASEWORK W/ UNDERMOUNT SINK. REFER TO PLUMB. DWGS. + 6/A501
- 15A RECEPTION DESK. REFER TO 2/A501
- 15B RECEPTION STORAGE CONSOLE. REFER TO 1/A501
- 16A WORKSTATION COUNTERTOP AT LOBBY. REFER TO 3/A501
- 16B WORKSTATION COUNTERTOP AT LARGE GROUP ROOM REFER TO 4/A501
- 17 CAFE WORK AND SEVICE COUNTER. REFER TO 5/A501
- 18 SERVER RACK. REFER TO ELEC. DWGS.
- 19 66" HIGH ACOUSTICAL WALL PANEL FINISH. LENGTH SET TO ALIGN WITH WALL EDGE. BOTTOM SET TO 42" A.F.F.
- 20 FLOOR BOX. REFER TO ELEC. + IT DWGS.
- 21 WALL MOUNTED FLAT PANEL DISPLAY W/ RECESSED WALL AV BOX. REFER TO ELEC. + IT DWGS.

#### GENERAL NOTES

- DIMENSIONS ARE TO FACE OF WALL FINISH U.N.O.
- PROJECT ZERO NOTED AS EL. 0'-0" EQUALS 136.00'. REFER TO CIVIL DWGS.
- PROVIDE WALL MOUNTED HAND DRYERS AND ACCESSORIES AT RESTROOMS. REFER TO SPECIFICATIONS.
- ALL STAIRS TO HAVE PAINTED STEEL RISERS WITH CONCRETE INFILL AT TREAD PAN U.N.O.
- PROVIDE BELOW SLAB VAPOR BARRIER W/ SEALED PENETRATIONS IF REQUIRED PER THE OWNER'S SOIL MANAGEMENT PLAN.

#### FIRST FLOOR PLAN

SCALE: 1/4" = 1'-0"



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NO. DATE REVISION

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BEACH CITIES  
HEALTH DISTRICT

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PMA PROJECT NO.  
23007

DRAWING TITLE

**FIRST FLOOR  
PLAN**

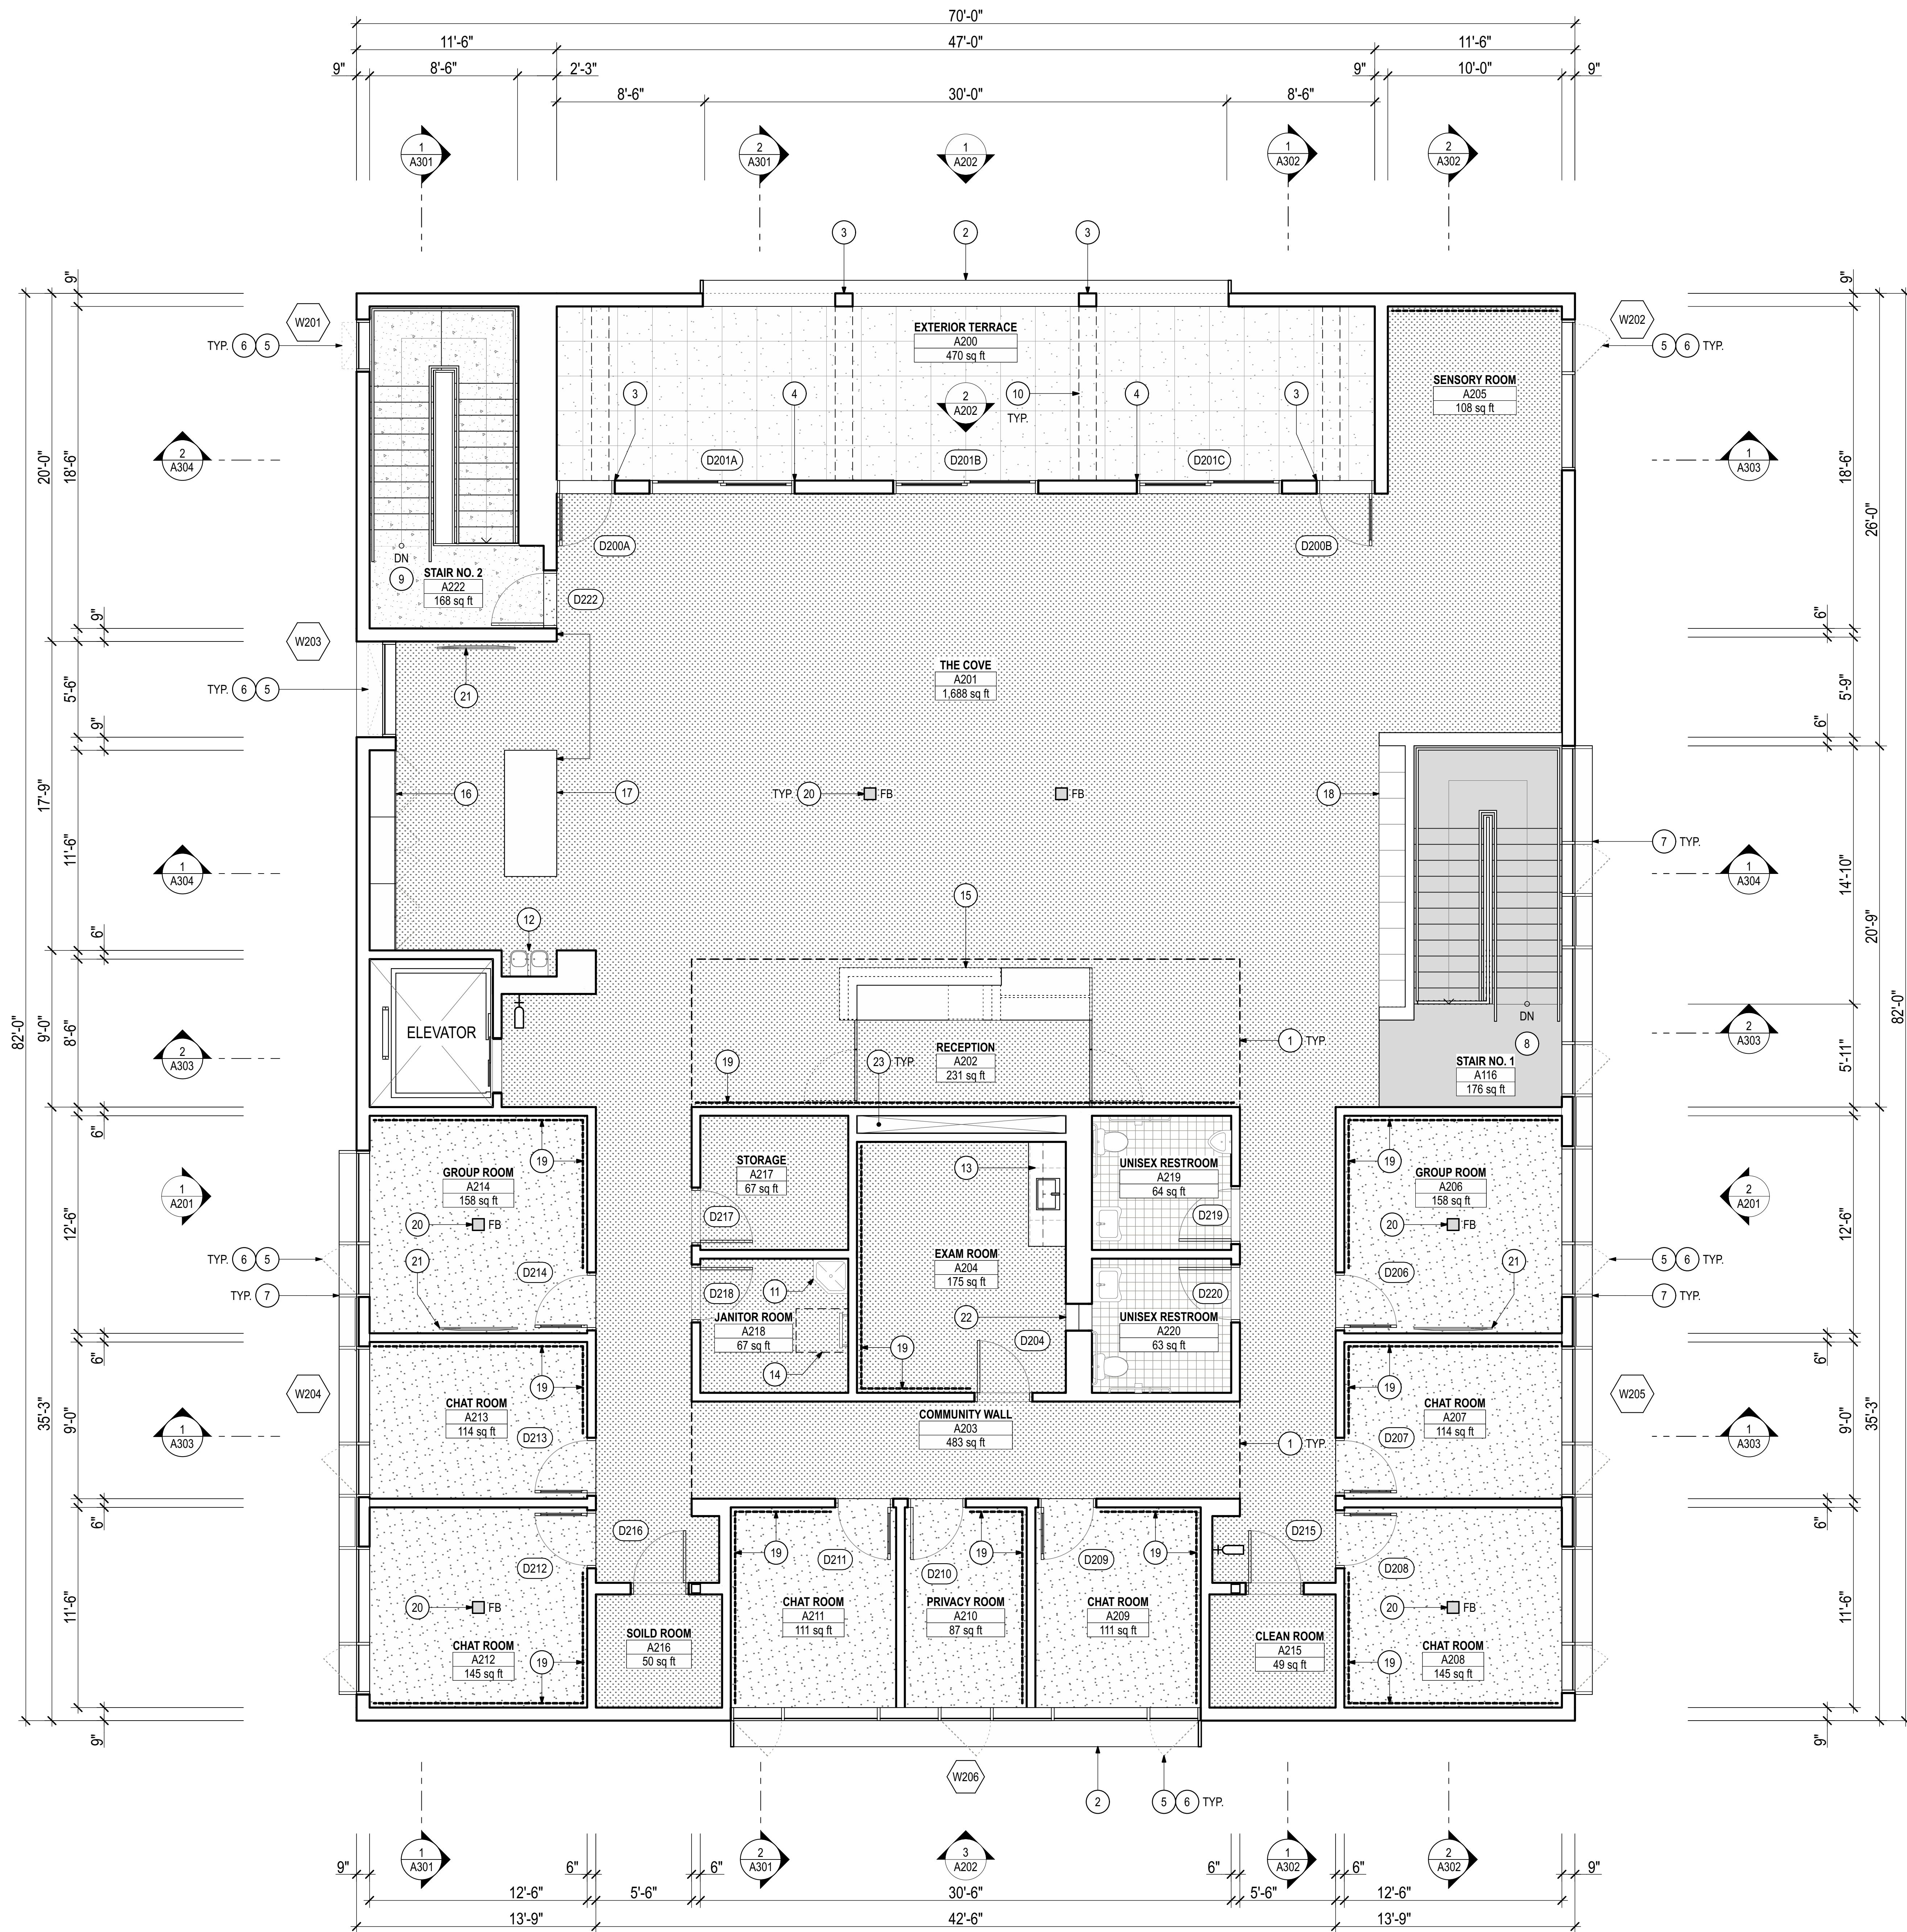
SCALE  
1/4" = 1'-0"

DATE  
02/28/2024

DRAWN CHECKED  
E.C. P.M.

SHEET NO.  
A111





#### SYMBOL LEGEND

- PROFILE OF BUILDING ABV.
- ACOUSTICAL WALL COVERING
- SEALED CONCRETE FLOOR FINISH
- CARPET TILE FLOOR FINISH
- LUXURY VINYL TILE (LVT) FLOOR FINISH
- RUBBER FLOOR FINISH AT STAIR NO. 1
- QUARRY TILE  
SLOPE MAX 2% TO DRAIN
- PEDESTAL PAVER SYSTEM
- RECESSED FIRE EXTINGUISHER CABINET
- HOSE BIB. REFER TO PLUMB. DWGS.

#### KEYNOTE LEGEND

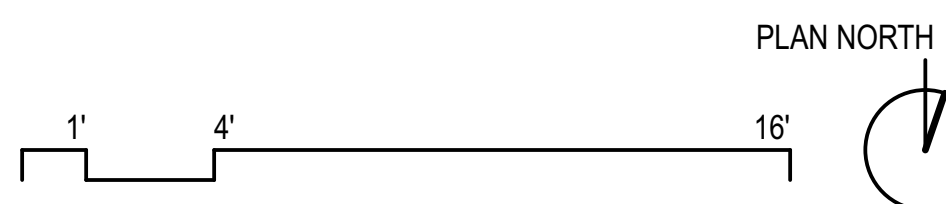
- 1 PROFILE OF SKYLIGHT ABOVE
- 2 PTD. ALUM. FRAME AT OPENING.
- 3 STL. COLUMN COVERS
- 4 PTD. ALUM./GLASS 2 PANEL SLIDING DOOR
- 5 PTD. ALUM./GLASS CURTAINWALL WINDOW SYSTEM
- 6 PTD. ALUM. OPERABLE WINDOW AT CURTAINWALL SYSTEM
- 7 EXTENDED COVER CAP AT CURTAINWALL SYSTEM.
- 8 STAIR #1 - STEEL STAIR W/ CONC. FILL STEEL TREADS  
W/ RUBBER FINISH
- 9 STAIR #2 - STEEL STAIR W/ CONC. FILL STEEL TREADS
- 10 PROFILE OF BEAM ENCLOSURE ABOVE
- 11 FLOOR SINK. REFER TO PLUMB. DWGS.
- 12 DRINKING FOUNTAIN AND BOTTLE FILLER  
REFER TO PLUMB. DWGS.
- 13 EXAM ROOM CASEWORK W/ UNDERMOUNT SINK.  
REFER TO PLUMB. DWGS. + 5/A502
- 14 ROOF LADDER W/ ACCESS TO MECHANICAL WELL
- 15 RECEPTION DESK. REFER TO 2/A502
- 16 SNACK STATION CABINETS. REFER TO 3/A502
- 17 SNACK STATION ISLAND. REFER TO 4/A502
- 18 STORAGE CUBBIES BELOW GUARDRAIL WALL.  
REFER TO 1/A502
- 19 66" HIGH ACOUSTICAL WALL PANEL FINISH. LEGNTH SET TO  
ALIGN WITH WALL EDGE. BOTTOM SET TO 42" A.F.F.
- 20 FLOOR BOX. REFER TO ELEC. + IT DWGS.
- 21 WALL MOUNTED FLAT PANEL DISPLAY W/ RECESSED  
WALL AV BOX. REFER TO ELEC. + IT DWGS.
- 22 RECESSED PASS-THRU CABINET.
- 23 MECHANICAL + PLUMB. SHAFT.

#### GENERAL NOTES

- 1. DIMENSIONS ARE TO FACE OF WALL FINISH U.N.O.
- 2. PROJECT ZERO NOTED AS EL. 0'-0" EQUALS 136.00'.  
REFER TO CIVIL DWGS.
- 3. PROVIDE WALL MOUNTED HAND DRYERS AND ACCESSORIES AT  
RESTROOMS. REFER TO SPECIFICATIONS.
- 4. ALL STAIRS TO HAVE PAINTED STEEL RISERS WITH CONCRETE  
INFILL AT TREAD PAN U.N.O.

#### SECOND FLOOR PLAN

SCALE: 1/4" = 1'-0"



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FABRICATION.

NO. DATE REVISION

**allcove**  
BEACH CITIES  
HEALTH DISTRICT

100% PRELIMINARY  
DESIGN SUBMITTAL

PMA PROJECT NO.  
23007

DRAWING TITLE  
**SECOND FLOOR  
PLAN**

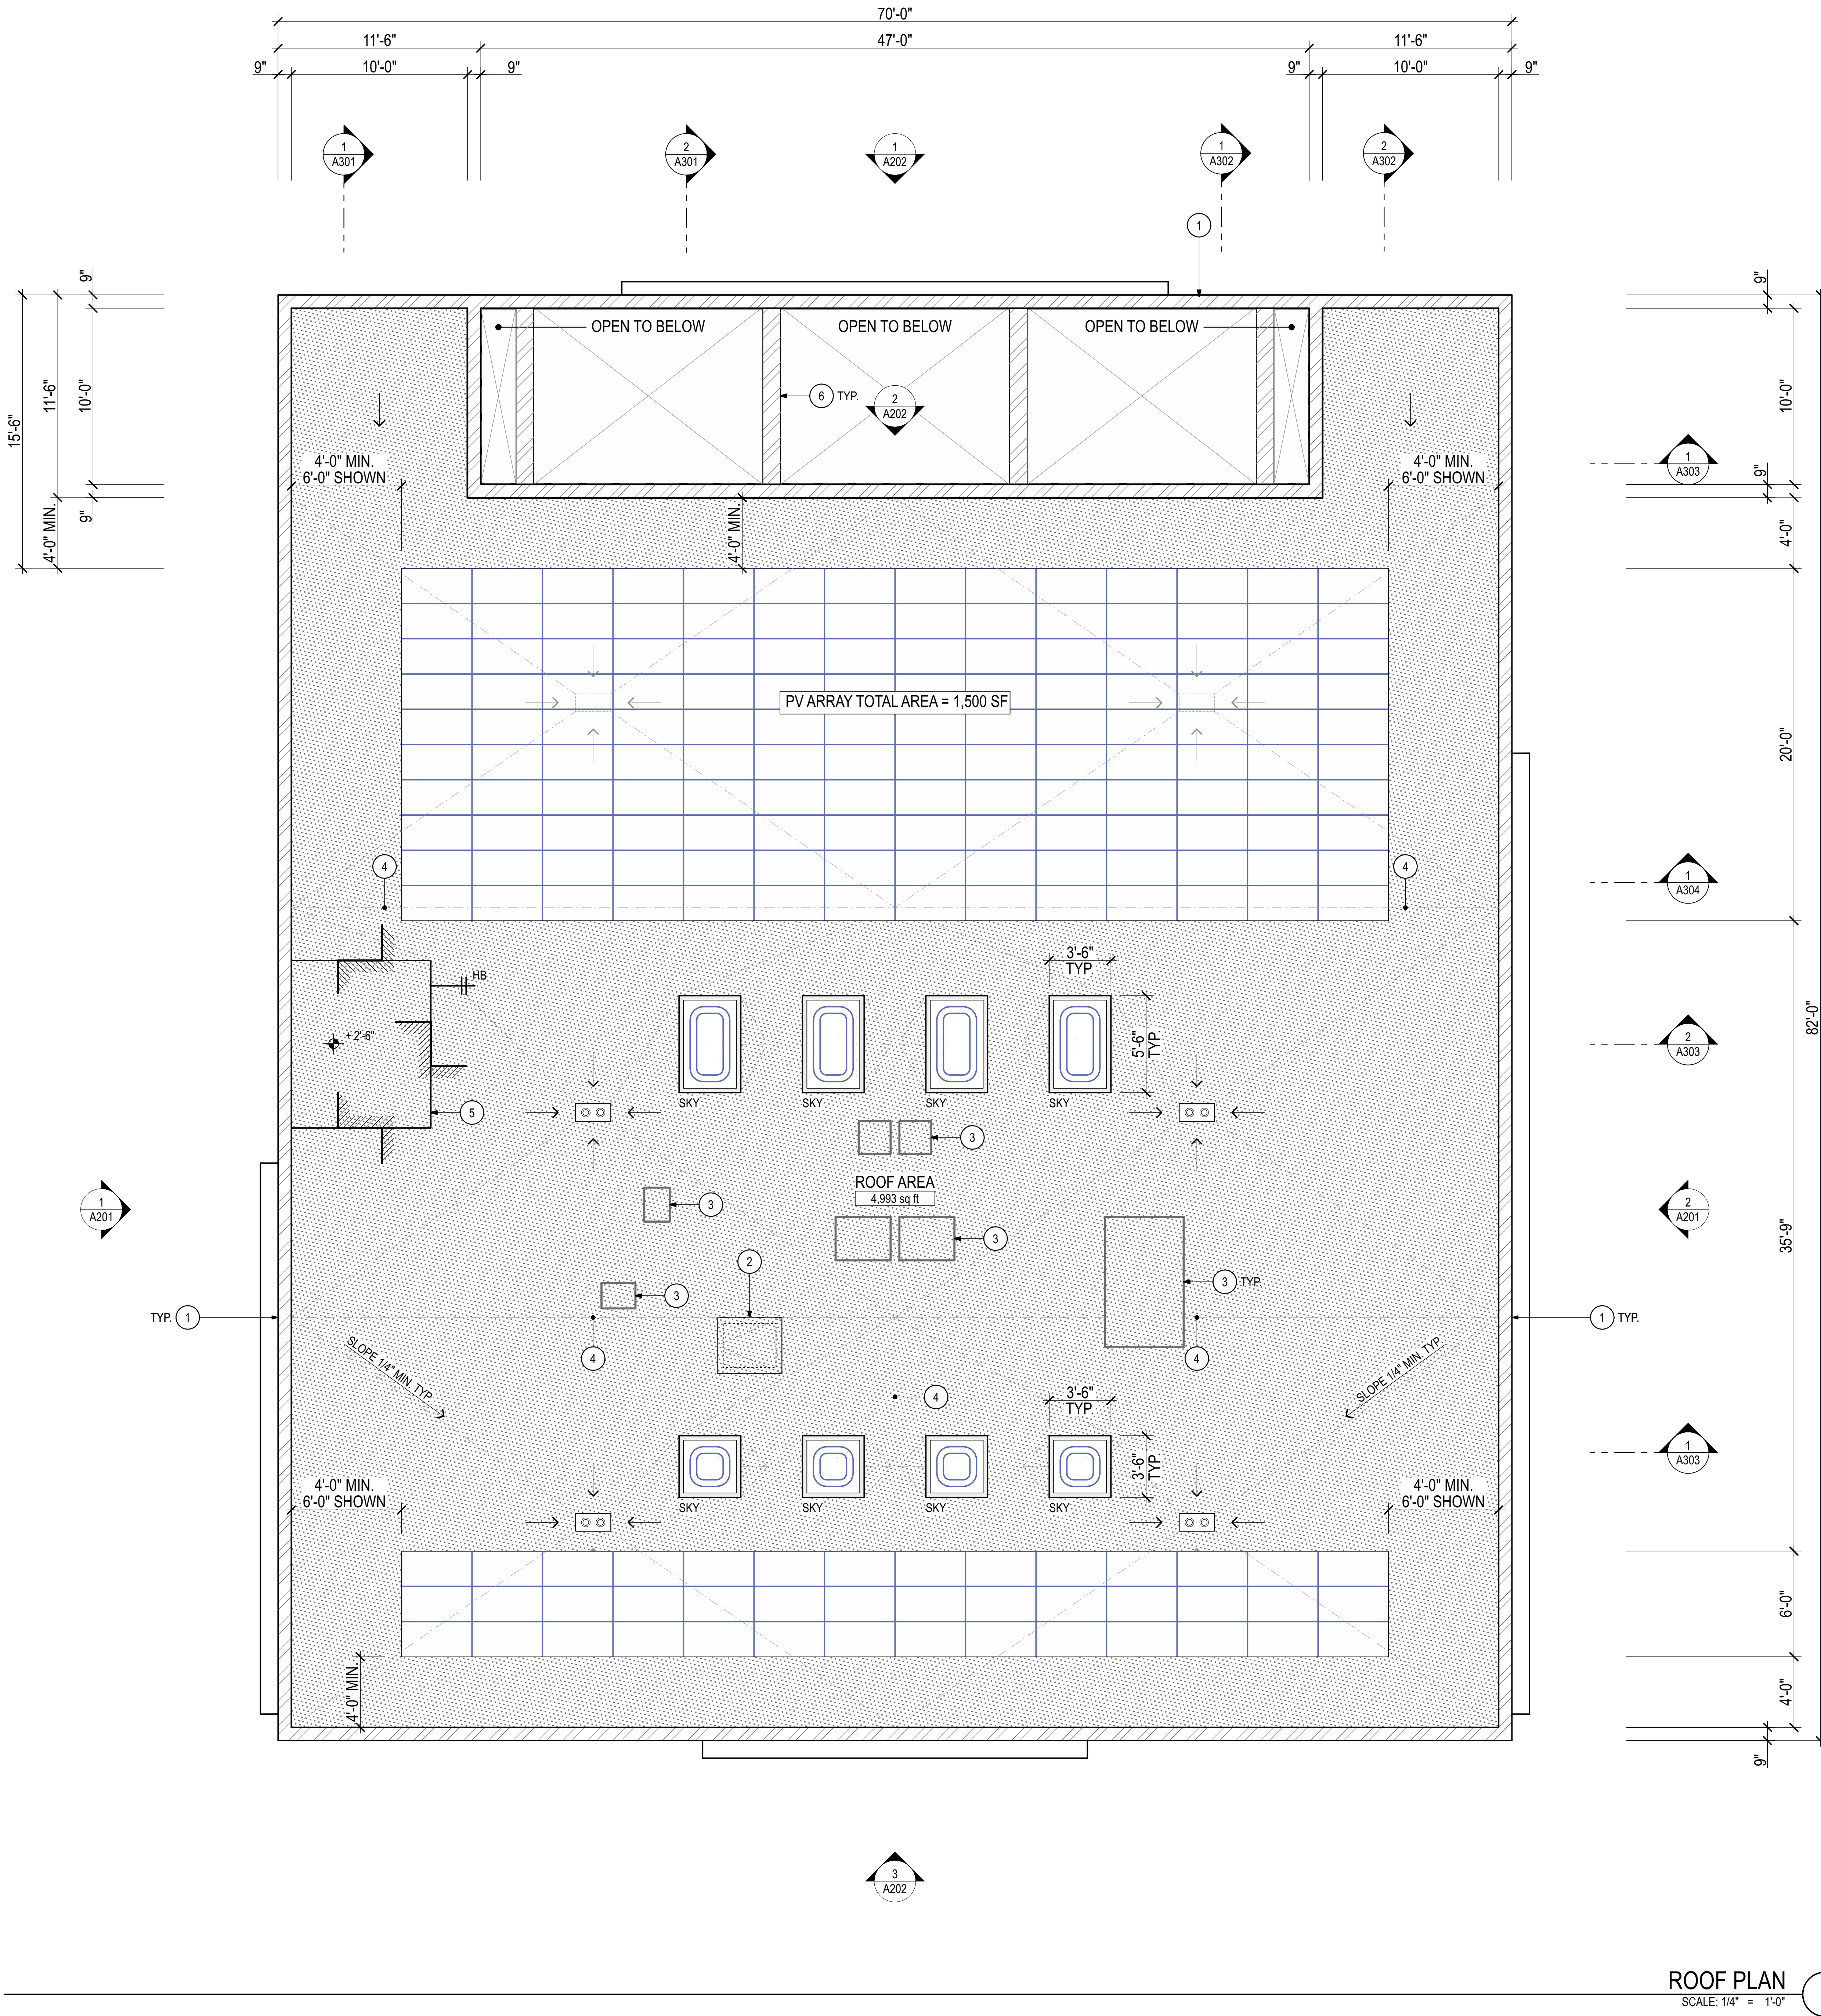
SCALE  
1/4" = 1'-0"

DATE  
02/28/2024

DRAWN CHECKED  
E.C. P.M.

SHEET NO.  
**A112**





SYMBOL LEGEND

- CLASS A SINGLE PLY ROOFING MEMBRANE  
W/ MIN. 1/4" PER FOOT SLOPE
- PHOTOVOLTAIC PANELS SECURED TO  
STRUCTURE BELOW
- PAINTED METAL COPING
- BUBBLE SKYLIGHT W/ CURB BASE
- SKY
- ROOF DRAIN / OVERFLOW DRAIN  
COMBINATION REFER TO PLUMB. DWGS.
- HB  
HOSE BIB. REFER TO PLUMB. DWGS.

KEYNOTE LEGEND

- 1 42" H. MIN. PARAPET  
+ PROFILE OF EXTERIOR FACE OF BLDG. BELOW
- 2 ROOF HATCH
- 3 MECHANICAL, PLUMBING AND ELECTRICAL EQUIPMENT.  
REFER TO MECH. PLUMB. AND ELEC. DWGS.
- 4 ROOF RIDGE
- 5 ELEVATOR ROOF ENCLOSURE
- 6 BEAM ENCLOSURE



GENERAL NOTES

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- PROJECT ZERO NOTED AS EL. 0'-0" EQUALS 136.00'.  
REFER TO CIVIL DWGS.

ROOF PLAN

SCALE: 1/4" = 1'-0"

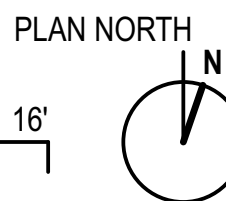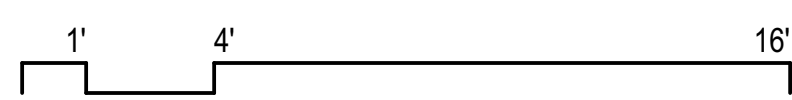1



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NO. DATE REVISION

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BEACH CITIES  
HEALTH DISTRICT

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DESIGN SUBMITTAL**

PMA PROJECT NO.  
23007

DRAWING TITLE

ROOF PLAN

SCALE  
1/4" = 1'-0"

DATE  
02/28/2024

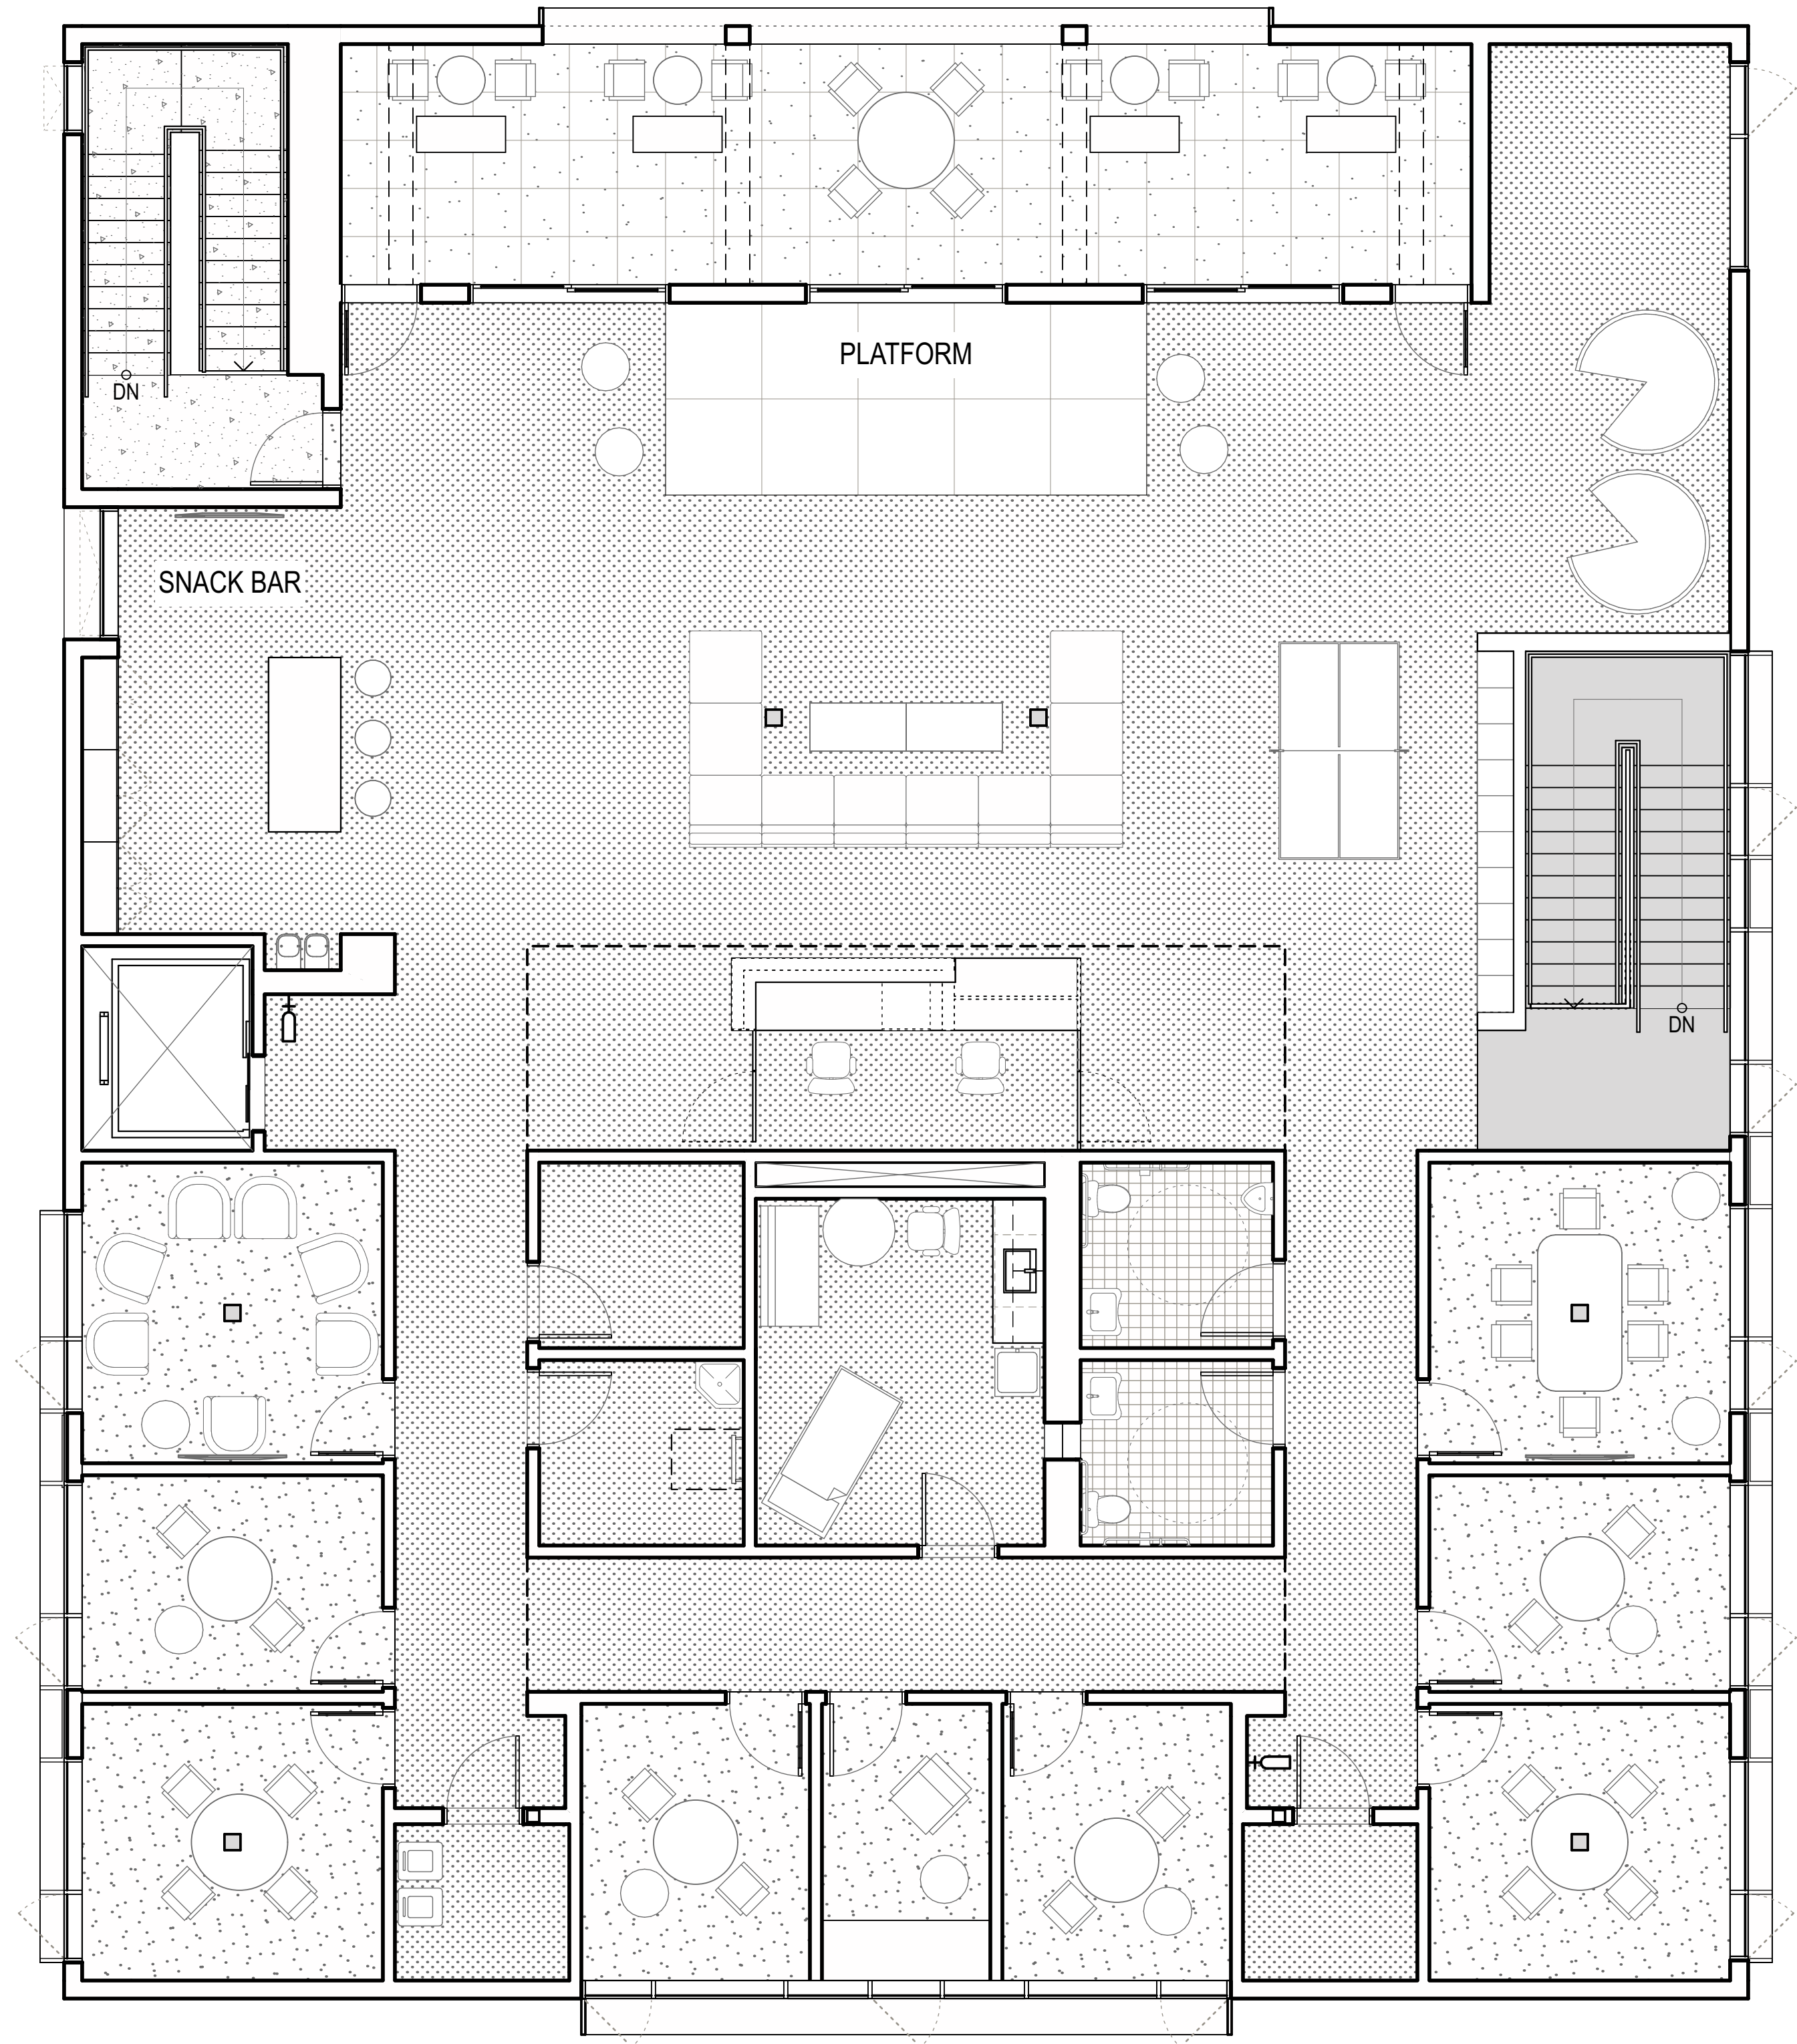
DRAWN  
E.C.

CHECKED  
P.M.


SHEET NO.

A113





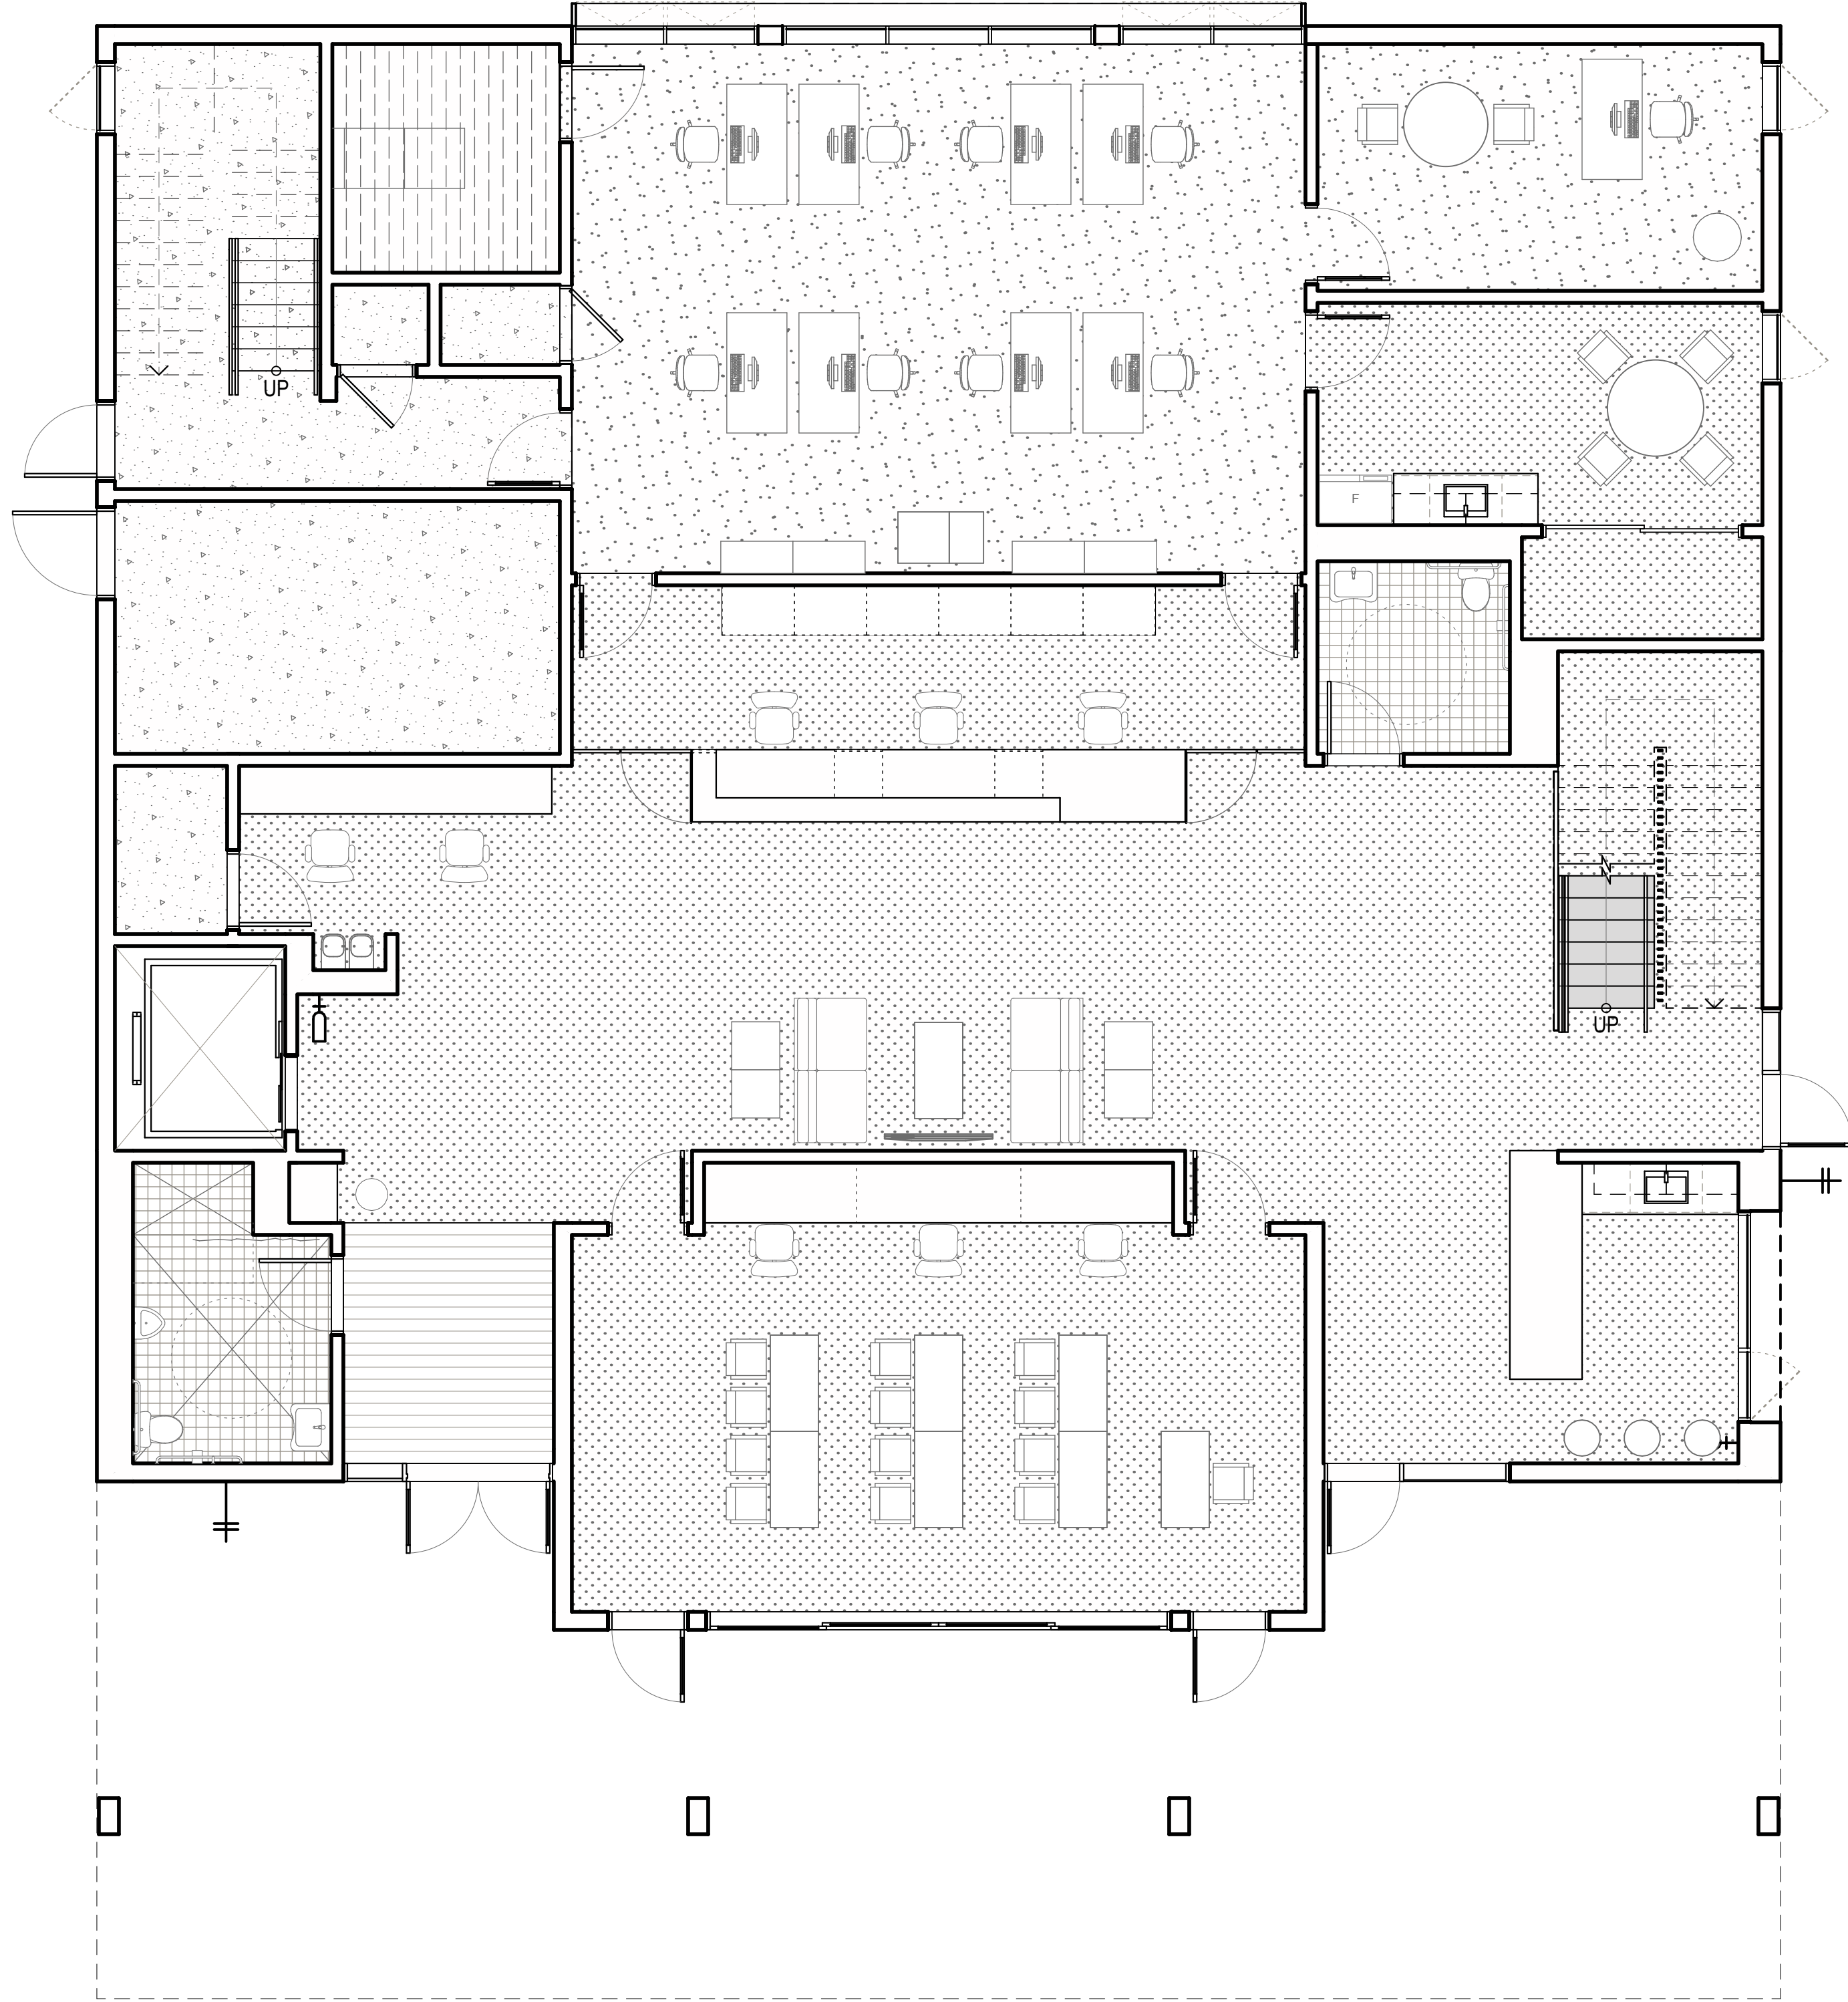SECOND FLOOR FURNITURE FLOOR PLAN  
SCALE: 3/16" = 1'-0" 2



FIRST FLOOR FURNITURE FLOOR PLAN  
SCALE: 3/16" = 1'-0" 1

- GENERAL NOTES
- PROJECT ZERO NOTED AS EL. 0'-0" EQUALS +136.0'.
  - REFER TO CIVIL DWGS.
  - FURNITURE + EQUIPMENT SHOWN ARE FOR REFERENCE ONLY.
  - N.I.C.
  - IT IS PROPOSED TO PROVIDE 2A TYPE EXTINGUISHERS THROUGHOUT THE BUILDING. EACH FIRE EXTINGUISHER SHALL COVER A MAXIMUM 3,000 SF OF BUILDING AREA. A TOTAL OF 6 FIRE EXTINGUISHER SHALL BE PROVIDED WITHIN THE BUILDING GIVING A TOTAL COVERAGE OF 18,000 SF WHICH IS GREATER THAN THE ACTUAL BUILDING AREA OF 15,664 SF. WITHIN THE PUBLIC AREA A TOTAL OF 2 FIRE EXTINGUISHERS SHALL BE PROVIDED WHICH COVER A MAXIMUM OF 6,000 SF > 5,992 SF ACTUAL AREA. WITHIN THE STAFF AREA, A TOTAL OF 4 FIRE EXTINGUISHERS SHALL BE PROVIDED WHICH COVER A MAXIMUM OF 12,000 SF > 9,260 SF ACTUAL AREA.




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NO.	DATE	REVISION
<b>allcove</b> BEACH CITIES HEALTH DISTRICT		
<b>100% PRELIMINARY DESIGN SUBMITTAL</b>		
PMA PROJECT NO. 23007		
DRAWING TITLE FIRST AND SECOND FURNITURE FLOOR PLAN		
SCALE 1/16" = 1'-0"		
DATE 02/28/2024		
DRAWN E.C.		
CHECKED P.M.		
SHEET NO. A114		





#### SYMBOL LEGEND

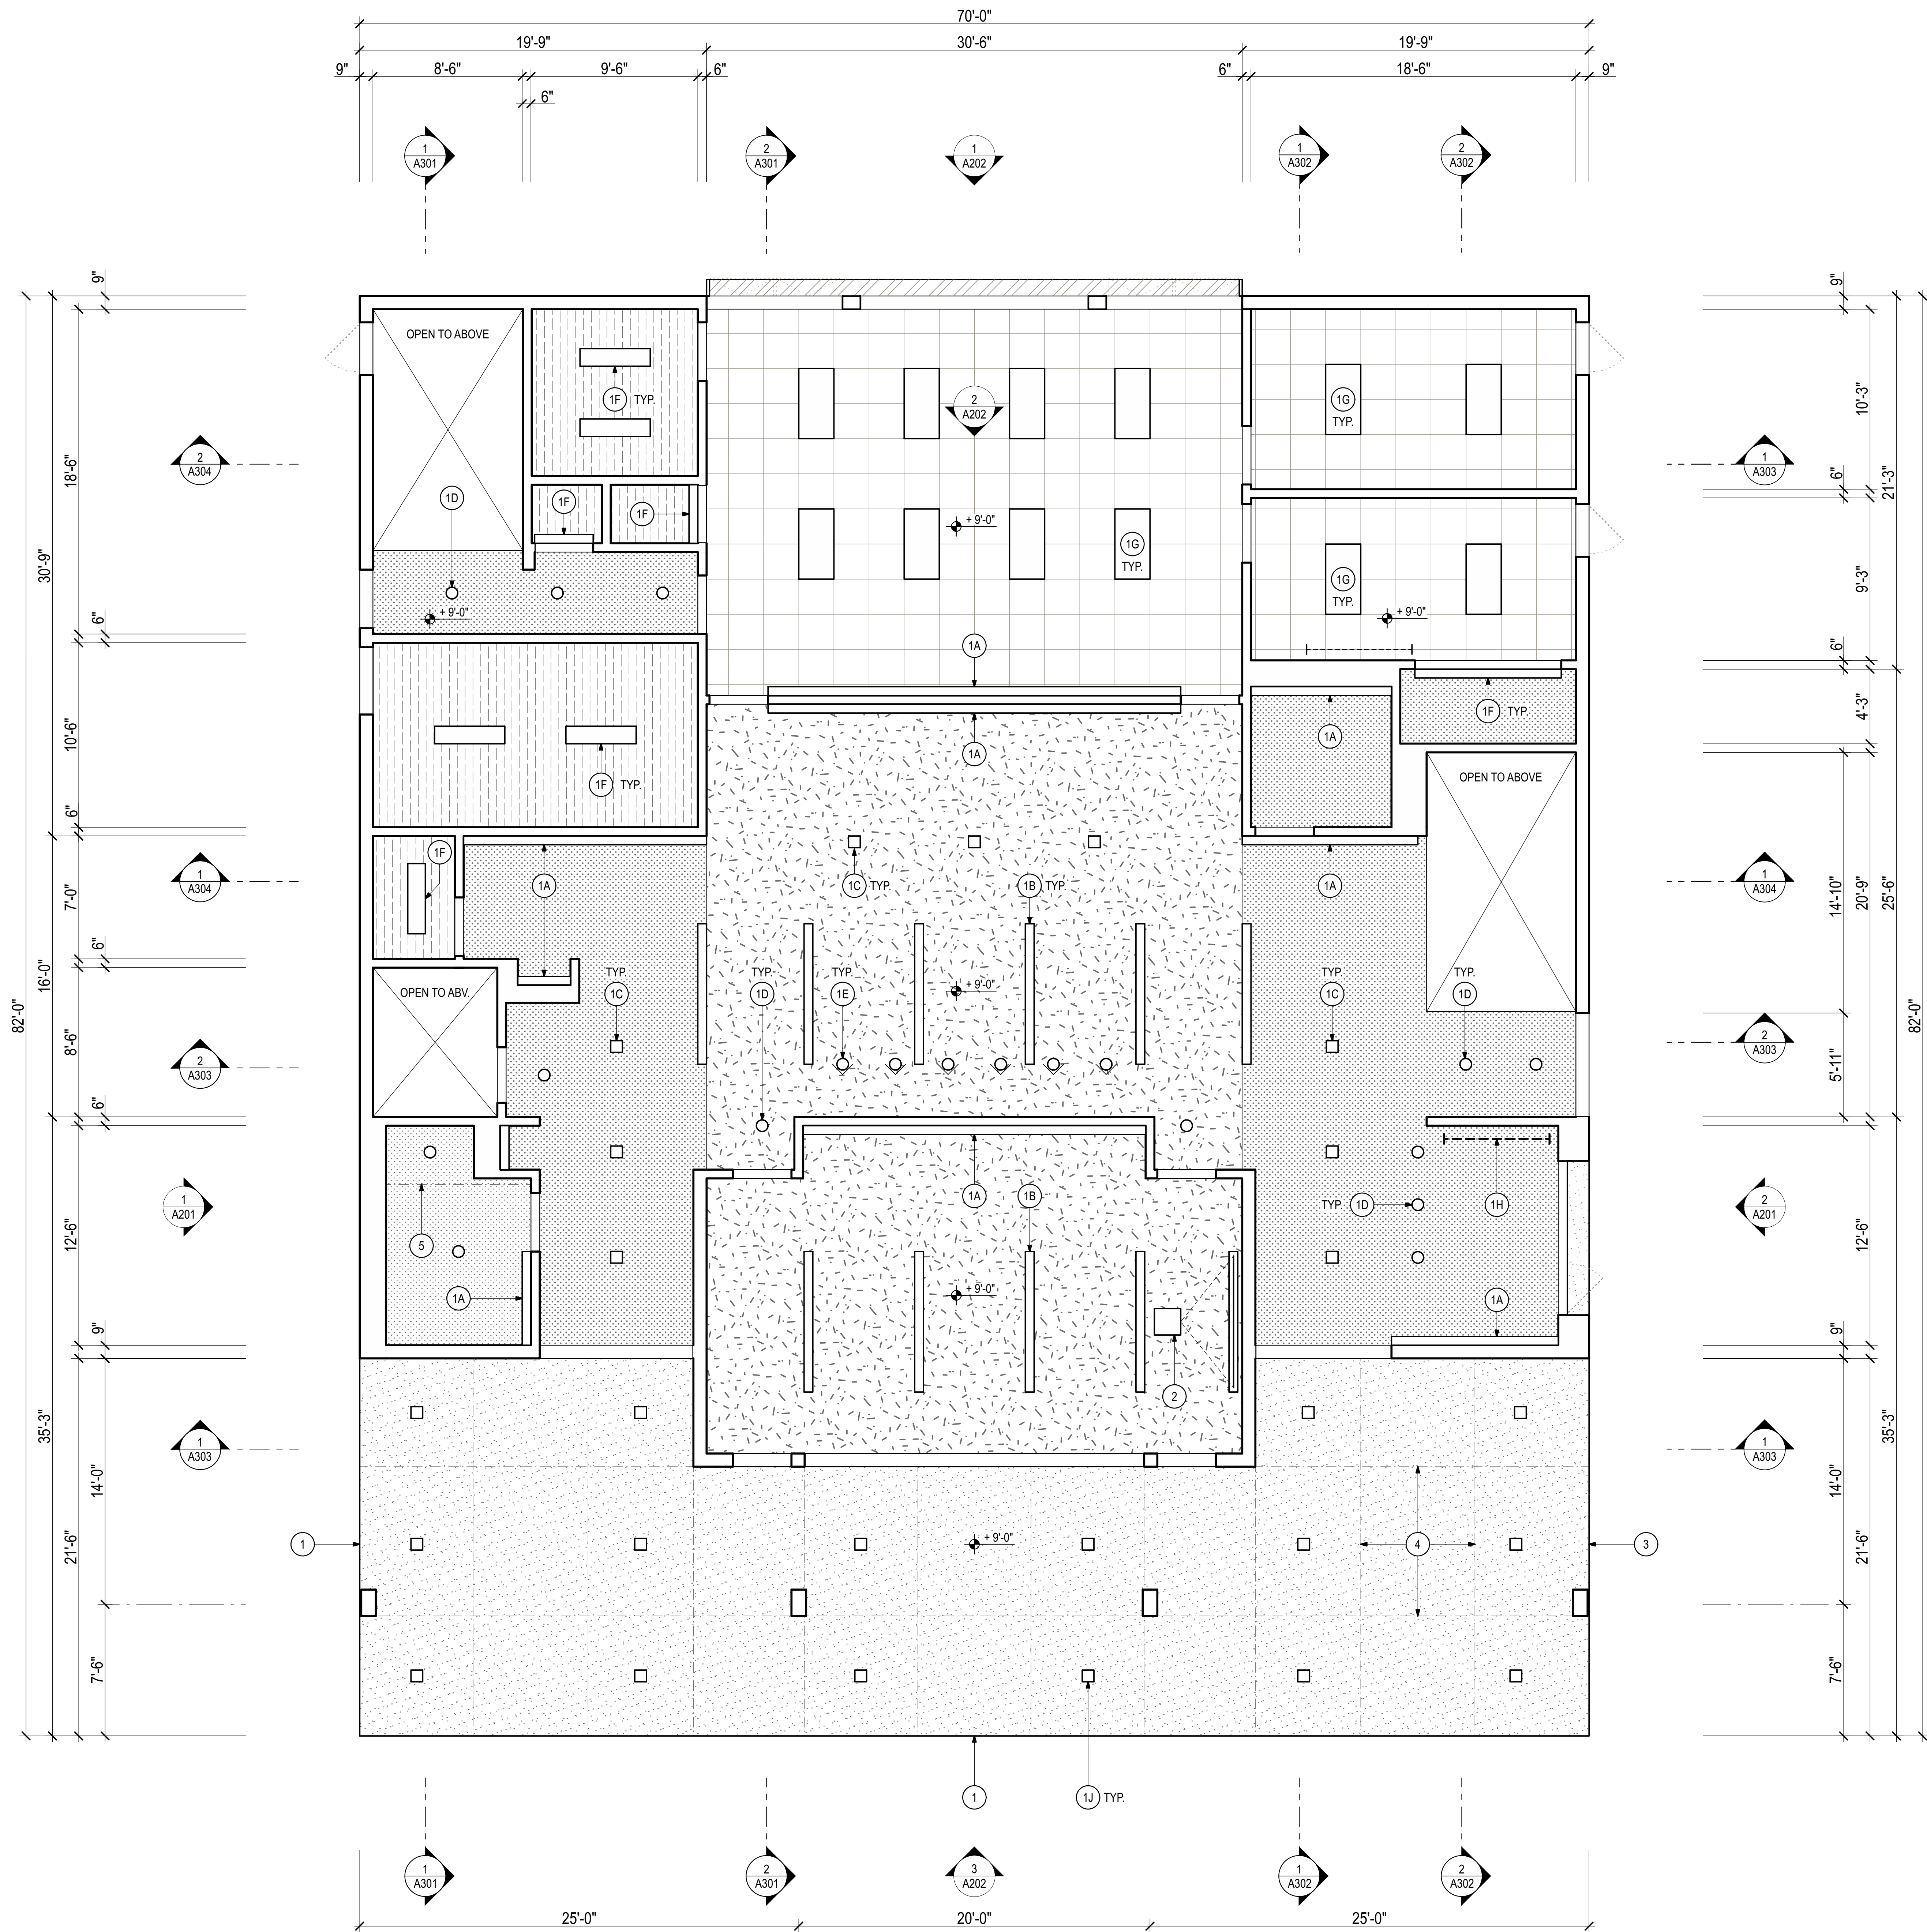- OPEN TO ABOVE
- PTD. GYPSUM CEILING
- SURFACE MOUNTED ACOUSTICAL TILES  
MTD. OVER PTD. GYPSUM CEILING
- PTD. METAL
- PORTLAND CEMENT PLASTER ASSEMBLY
- (ACT) ACOUSTICAL CEILING TILE CEILING
- EXPOSED STRUCTURE.  
PAINT ALL EXPOSED SURFACES.

#### KEYNOTE LEGEND


- 1A COVE / WALL WASH LIGHT FIXTURE.  
SHOWN FOR REFERENCE ONLY, REFER TO ELEC. DWGS.
- 1B LINEAR RECESSED LIGHT FIXTURE.  
SHOWN FOR REFERENCE ONLY, REFER TO ELEC. DWGS.
- 1C DOWNLIGHT FIXTURE.  
SHOWN FOR REFERENCE ONLY, REFER TO ELEC. DWGS.
- 1D DOWNLIGHT FIXTURE.  
SHOWN FOR REFERENCE ONLY, REFER TO ELEC. DWGS.
- 1E WALL WASH LIGHT FIXTURE.  
SHOWN FOR REFERENCE ONLY, REFER TO ELEC. DWGS.
- 1F UTILITY LIGHT FIXTURE.  
SHOWN FOR REFERENCE ONLY, REFER TO ELEC. DWGS.
- 1G 2' X 4' LIGHT FIXTURE.  
SHOWN FOR REFERENCE ONLY, REFER TO ELEC. DWGS.
- 1H UNDER CABINET LIGHT FIXTURE.  
SHOWN FOR REFERENCE ONLY, REFER TO ELEC. DWGS.
- 1J EXTERIOR DOWNLIGHT FIXTURE.  
SHOWN FOR REFERENCE ONLY, REFER TO ELEC. DWGS.
- 1K EXTERIOR WALL SCONCE LIGHT FIXTURE.  
SHOWN FOR REFERENCE ONLY, REFER TO ELEC. DWGS.
- 2 CLG. MTD. SHORT THROW PROJECTOR W/ RETRACTABLE  
SCREEN. REFER TO IT/AV DWGS.
- 3 PROFILE OF PLASTER SOFFIT
- 4 PLASTER SOFFIT JOINT
- 5 FLUSH MOUNT RECESSED SHOWER CURTAIN TRACK

#### GENERAL NOTES

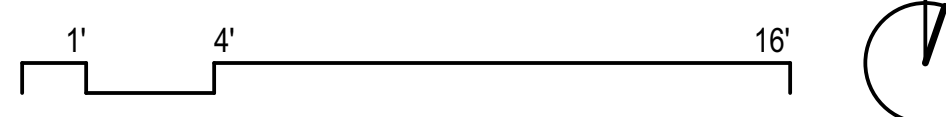- ALL CEILINGS TO BE 9'-0" U.N.O.
- PAINT ALL EXPOSED SURFACES INCLUDING BUT NOT LIMITED  
TO DUCTWORK, CONDUIT/JUNCTION BOXES AND PIPES.
- DIMENSIONS ARE TO FACE OF WALL FINISH U.N.O.
- PROJECT ZERO NOTED AS EL. 0'-0" EQUALS 136.00'.  
REFER TO CIVIL DWGS.
- M.E.P. FIXTURES SHOWN ON ARCH. DWGS. ARE FOR  
ACCURACY OF LOCATION & COORD. ONLY. THOSE NOT SHOWN  
ON ARCH. DWGS. SHALL BE LOCATED PER THE M.E.P. DWGS.
- REFER TO AV/IT DWGS. FOR ADDITIONAL DEVICES AT CLG.
- ALL DEVICES + FIXTURES TO BE CENTERED ON CEILING TILE  
OR JOINT U.N.O.
- PROVIDE ACCESS HATCH FOR EQUIP. + DEVICES AS REQ'D.  
COORD. ACCESS PANEL LOCATIONS W/ ARCH. PRIOR TO INST.
- CEILING TILE LAYOUTS TO BE CENTERED IN ROOM IN BOTH  
DIRECTIONS U.N.O.
- FIRE SPRINKLER HEAD LOCATIONS TO BE COORD. W/ ARCH.
- REFER TO ELEC. DWGS. FOR LIGHT FIXTURE TYPES +  
LOCATIONS.
- PROVIDE ILLUMINATION IN ACCORDANCE W/ CBC SECTION  
1205. REFER TO ELEC. DWGS.

#### FIRST FLOOR CEILING PLAN

SCALE: 1/4" = 1'-0"



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NO. DATE REVISION

**allcove**  
BEACH CITIES  
HEALTH DISTRICT

**100% PRELIMINARY  
DESIGN SUBMITTAL**

PMA PROJECT NO.  
23007

DRAWING TITLE

**FIRST FLOOR  
REFLECTED  
CEILING PLAN**

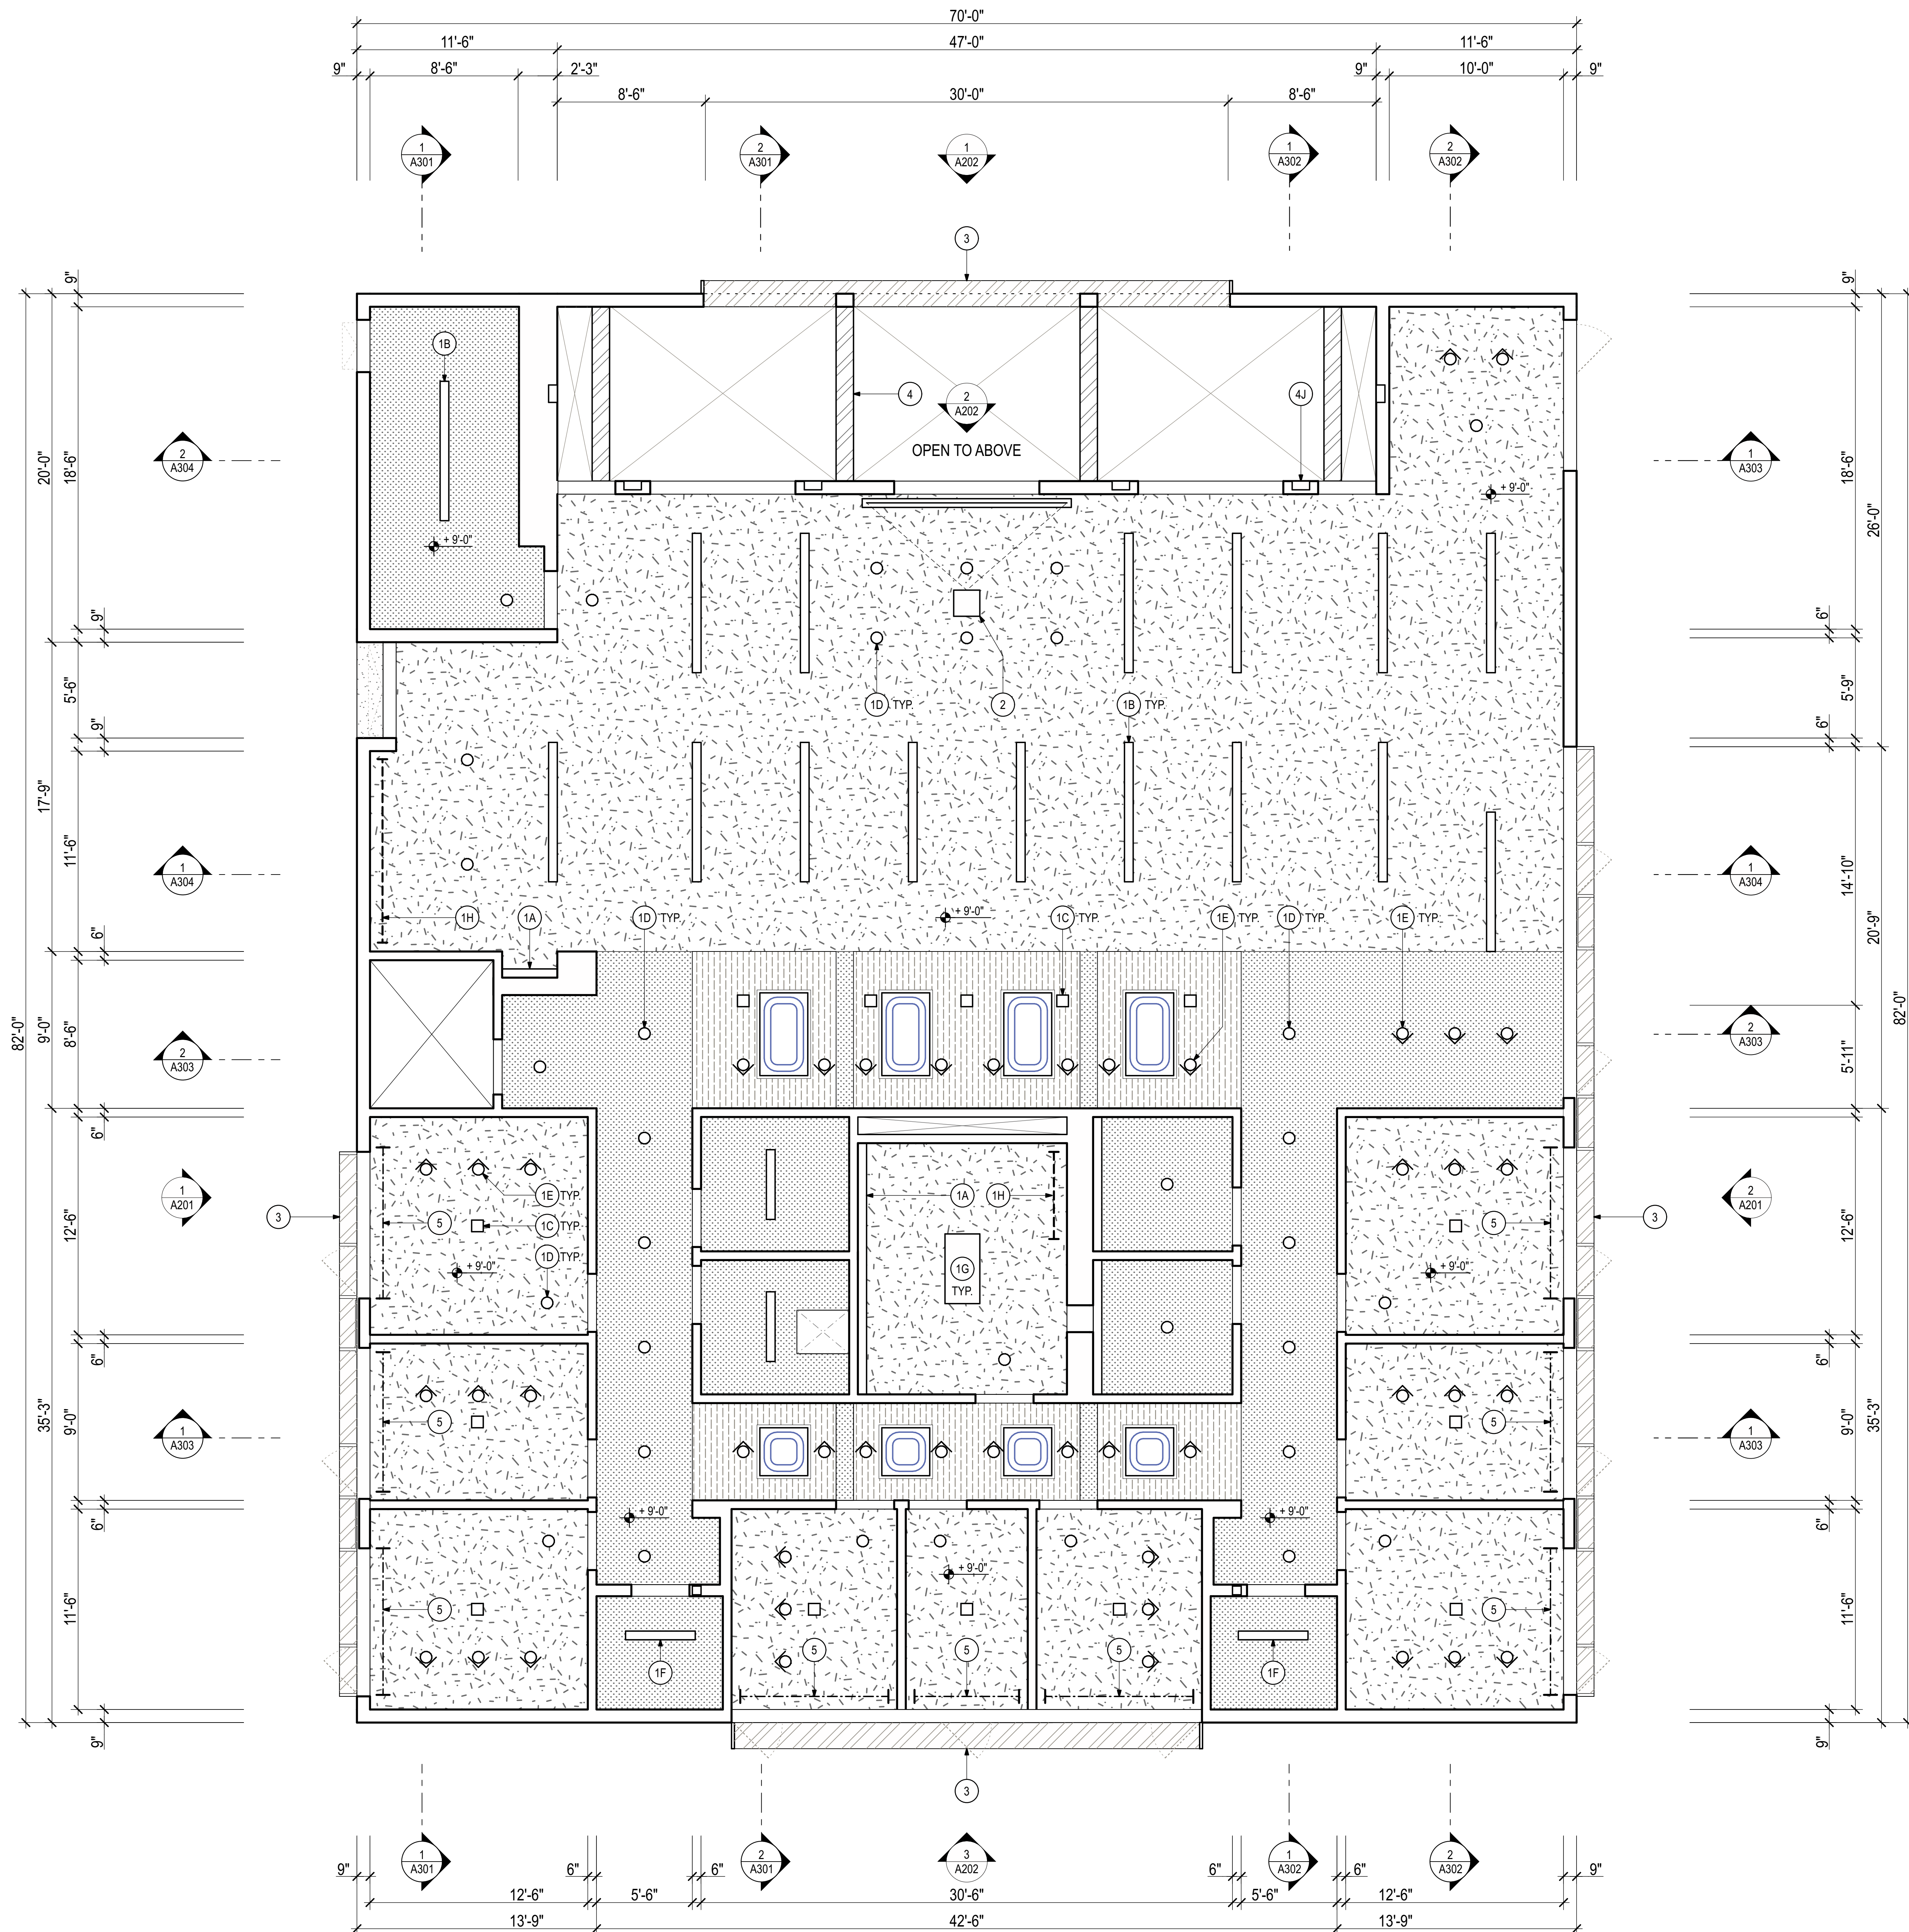
SCALE  
1/4" = 1'-0"

DATE  
02/28/2024

DRAWN CHECKED  
E.C. P.M.

SHEET NO.  
A121





#### SYMBOL LEGEND

- OPEN TO ABOVE
- PTD. GYPSUM CEILING
- SURFACE MOUNTED ACOUSTICAL TILES  
MTD. OVER PTD. GYPSUM CEILING
- PTD. METAL
- OPEN AREA W/ EXPOSED CEILING  
PAINT ALL EXPOSED SURFACES  
MINIMIZE UTILITY RUNS IN THIS AREA
- DOME SKYLIGHT

#### KEYNOTE LEGEND

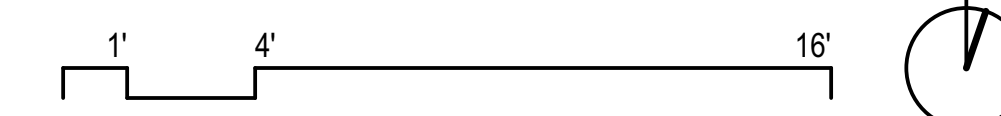
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- 1E WALL WASH LIGHT FIXTURE.  
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- 1F UTILITY LIGHT FIXTURE.  
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SHOWN FOR REFERENCE ONLY, REFER TO ELEC. DWGS.
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- 2 CLG. MTD. SHORT THROW PROJECTOR W/ RETRACTABLE  
SCREEN. REFER TO IT/AV DWGS.
- 3 PROFILE OF PLASTER SOFFIT
- 4 STL. BEAM ENCLOSURE
- 5 FLUSH MOUNT RECESSED SHOWER CURTAIN TRACK

#### GENERAL NOTES

- ALL CEILINGS TO BE 9'-0" U.N.O.
- PAINT ALL EXPOSED SURFACES INCLUDING BUT NOT LIMITED  
TO DUCTWORK, CONDUIT/JUNCTION BOXES AND PIPES.
- DIMENSIONS ARE TO FACE OF WALL FINISH U.N.O.
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- CEILING TILE LAYOUTS TO BE CENTERED IN ROOM IN BOTH  
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- FIRE SPRINKLER HEAD LOCATIONS TO BE COORD. W/ ARCH.
- REFER TO ELEC. DWGS. FOR LIGHT FIXTURE TYPES +  
LOCATIONS.
- PROVIDE ILLUMINATION IN ACCORDANCE W/ CBC SECTION  
1205. REFER TO ELEC. DWGS.

#### SECOND FLOOR CEILING PLAN

SCALE: 1/4" = 1'-0"



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NO. DATE REVISION

**allcove**  
BEACH CITIES  
HEALTH DISTRICT

**100% PRELIMINARY  
DESIGN SUBMITTAL**

PMA PROJECT NO.  
23007

DRAWING TITLE

**SECOND FLOOR  
REFLECTED  
CEILING PLAN**

SCALE  
1/4" = 1'-0"


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02/28/2024

DRAWN CHECKED  
E.C. P.M.


SHEET NO.

**A122**




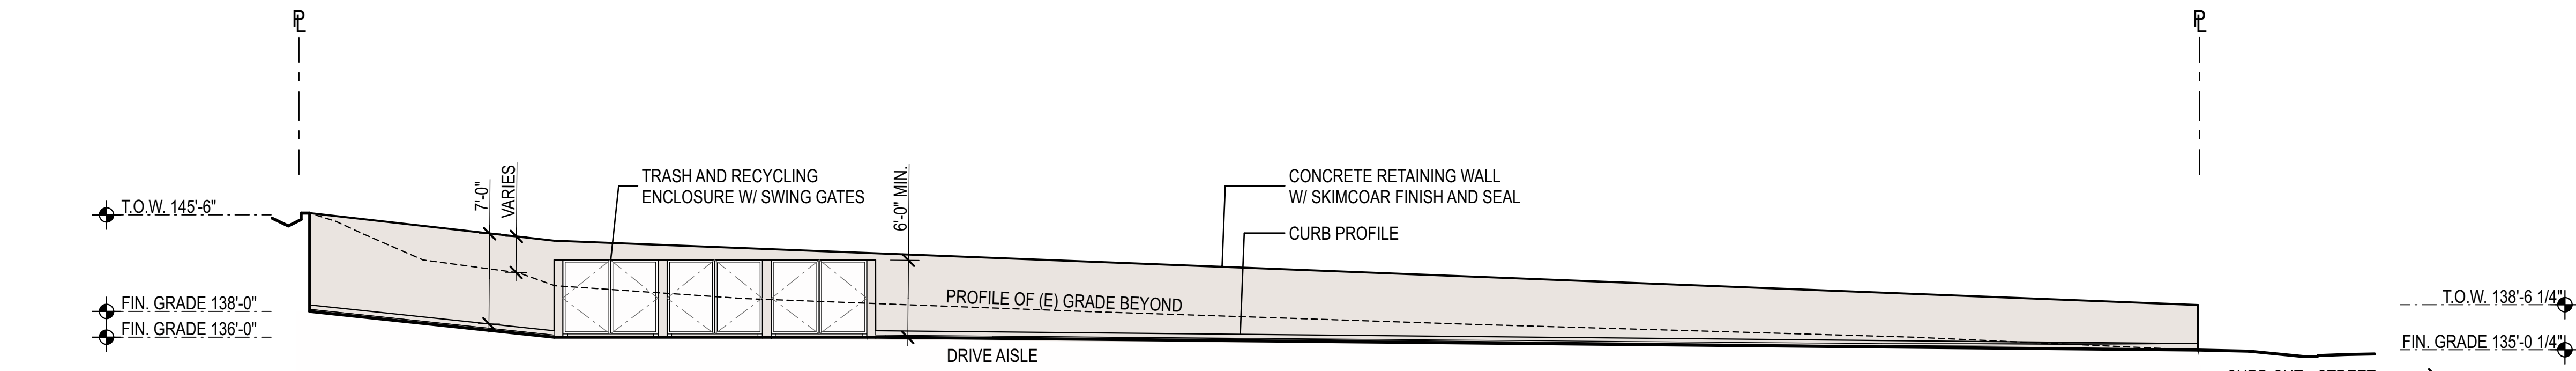

SITE WALL ELEVATION WEST 1

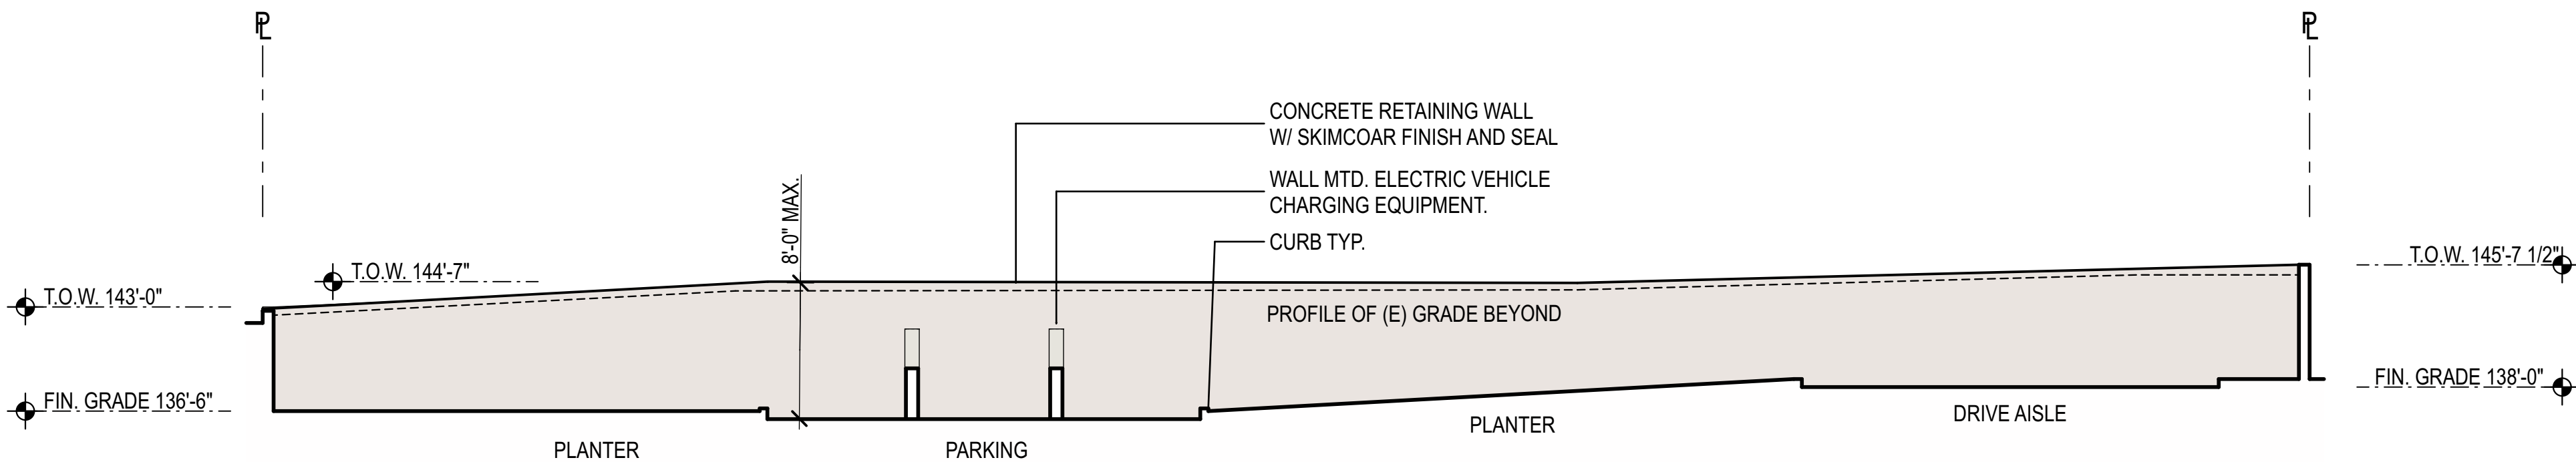


SITE WALL ELEVATION SOUTH 2

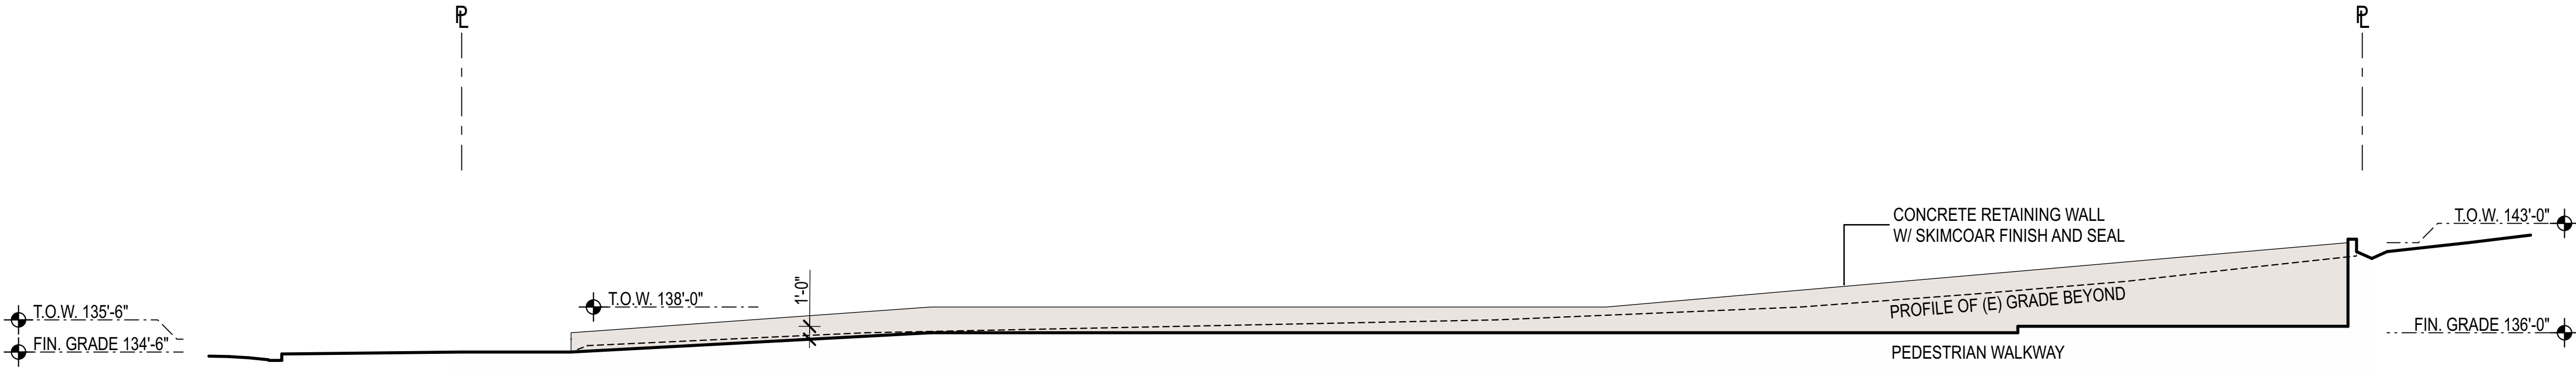

SITE WALL ELEVATION EAST 4

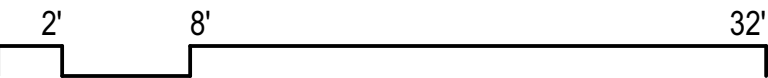GENERAL NOTES  
1. PROVIDE ANTI-GRAFFITI COATING ON ALL EXPOSED WALL SURFACES




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T. 310.356.0993


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NO.	DATE	REVISION
<b>allcove</b> BEACH CITIES HEALTH DISTRICT		
<b>100% PRELIMINARY DESIGN SUBMITTAL</b>		
PMA PROJECT NO. 23007		
DRAWING TITLE SITE WALL ELEVATIONS		
SCALE		
DATE 02/28/2024		
DRAWN E.C.	CHECKED P.M.	
SHEET NO. A200		





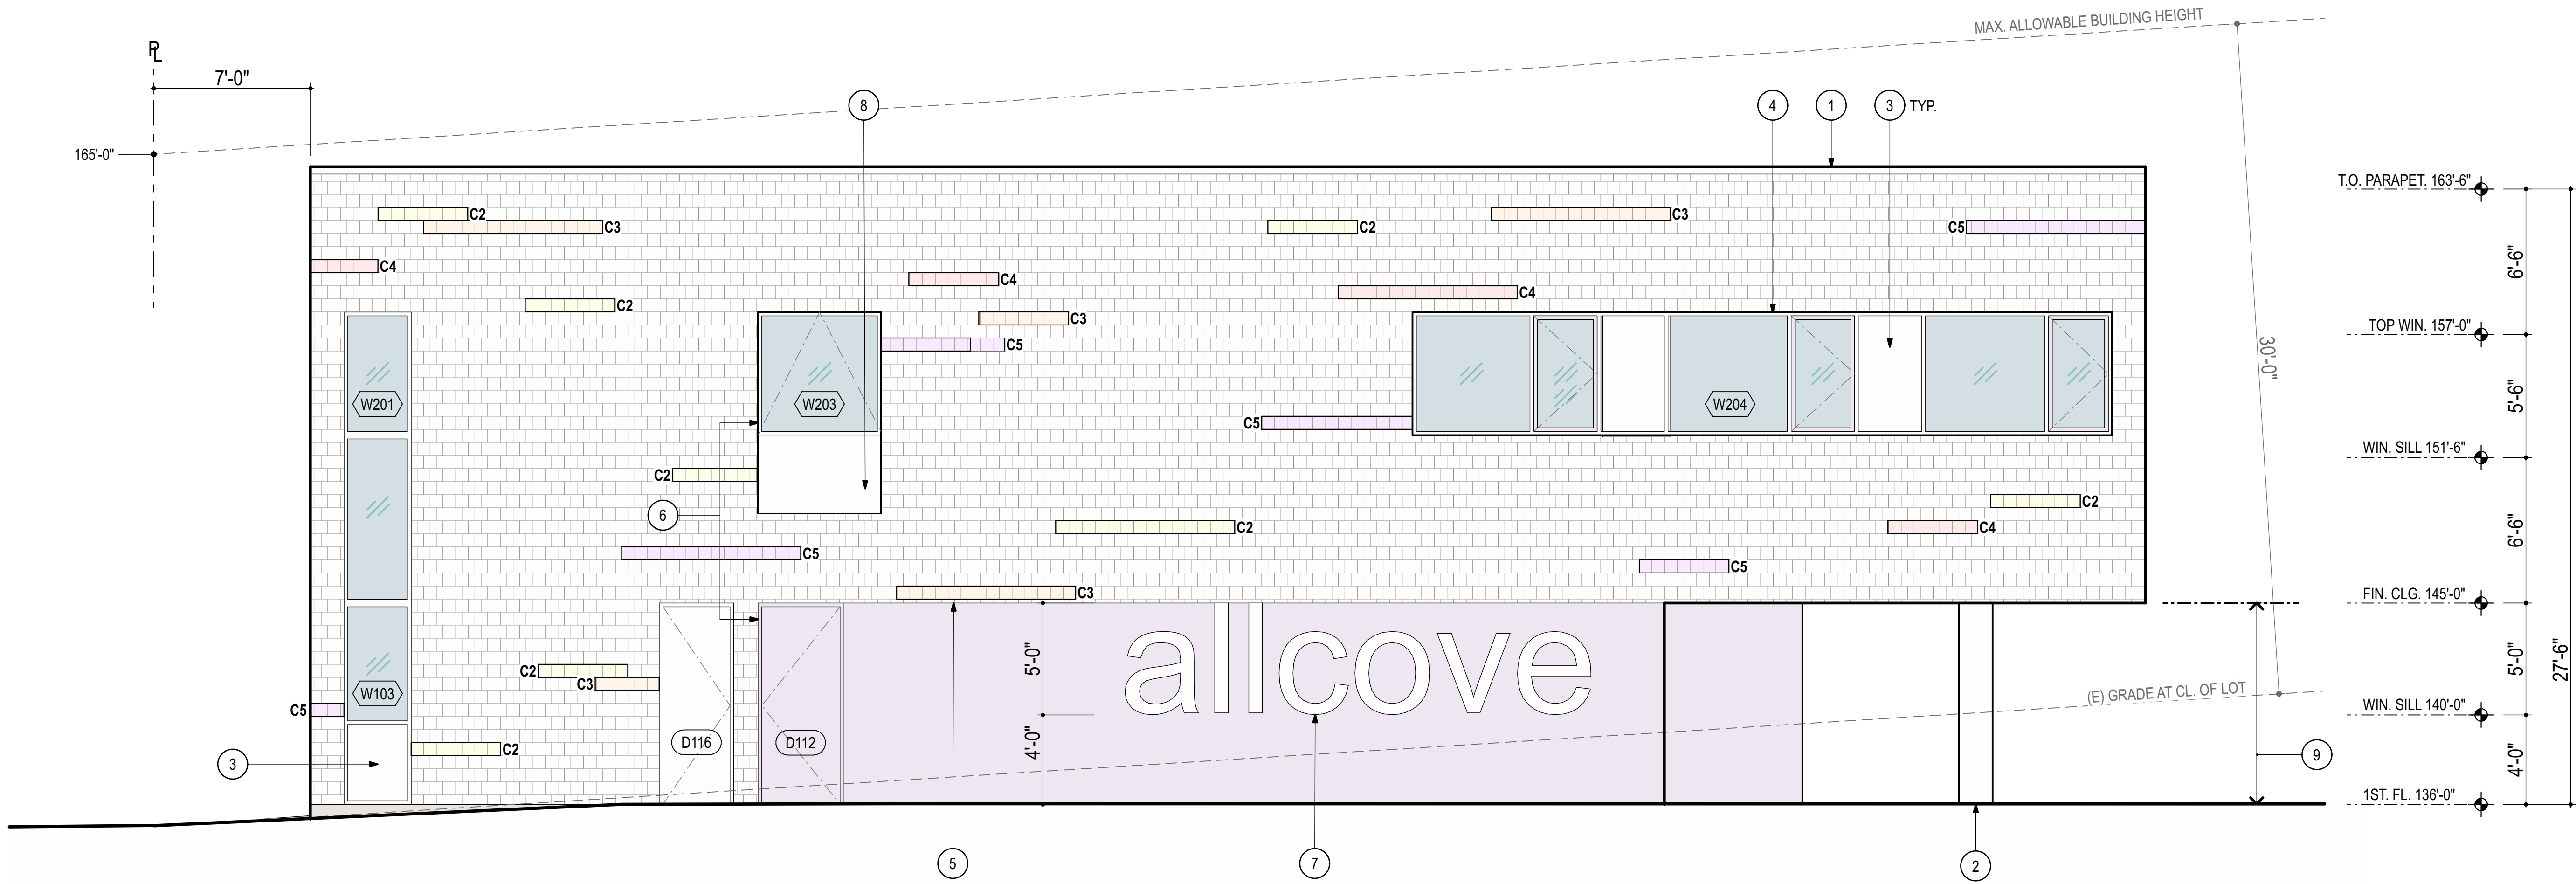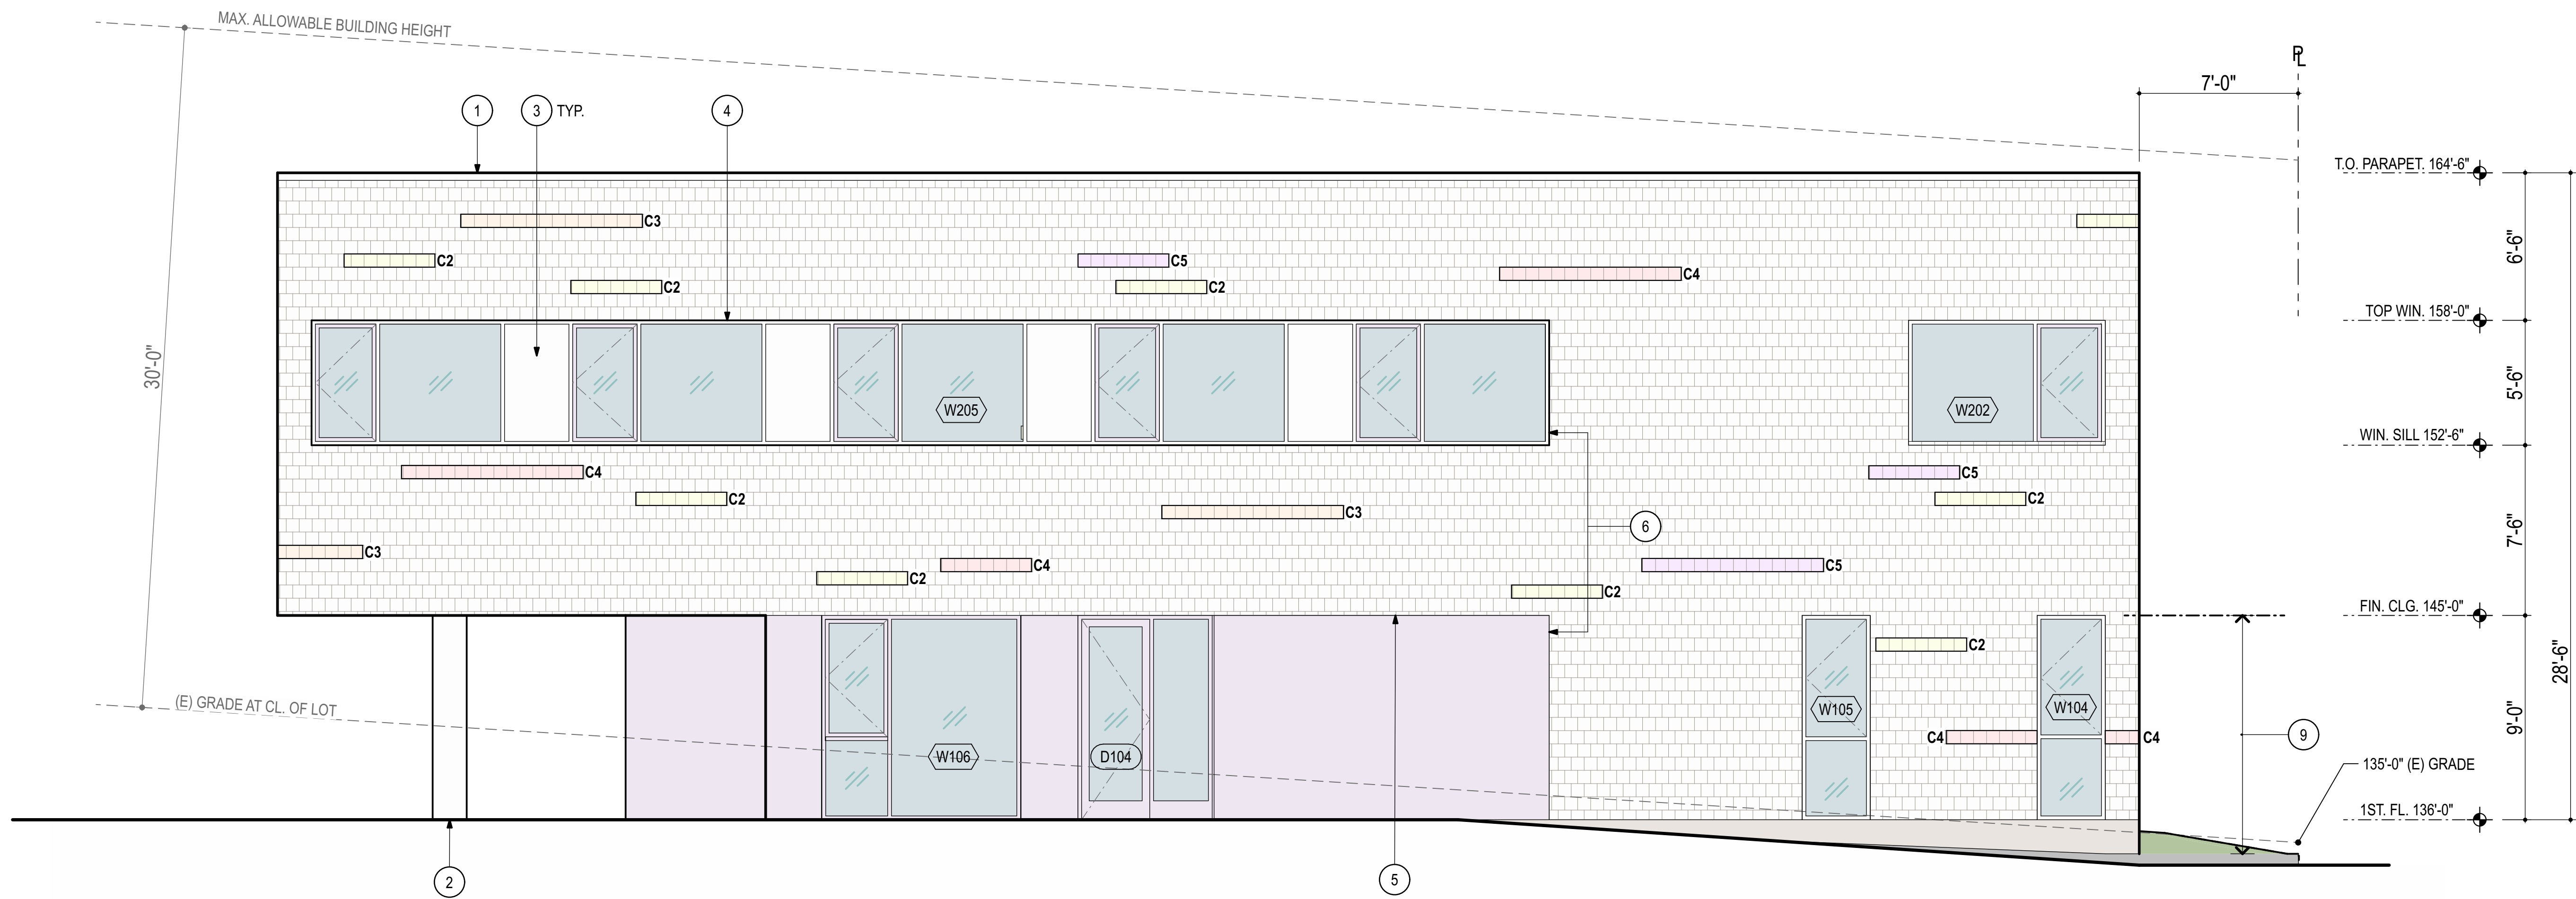WEST ELEVATION  
SCALE: 1/4" = 1'-0" 1



EAST ELEVATION  
SCALE: 1/4" = 1'-0" 2

SYMBOL LEGEND

- PTD. SMOOTH PLASTER WALL FINISH  
MATCH C5 COLOR
- FIBER CEMENT SHINGLE SIDING  
COLOR - 01 TYP. U.N.O  
REFER TO COLOR LEGEND BELOW
- GLASS / GLAZING
- CONCRETE
- OPERABLE WINDOW OR DOOR

FIBER CEMENT SIDING COLOR LEGEND

- C1 WHITE PICKET FENCE
- C2 BABY CHICK
- C3 FADING PEACH
- C4 ROSE COVERED COTTAGE
- C5 PERIWINKLE

KEYNOTE LEGEND


- 1 PTD. STL. COPING
- 2 STL. COLUMN W/ METAL COLUMN COVER.
- 3 PTD. INSULATED METAL INFILL PANEL W/ IN FRAMING.
- 4 12" EXTENDED AL. CAP COVERS
- 5 PTD. FLASHING AT EXT. MATERIAL TRANSITION AS REQ'D.
- 6 ALIGN
- 7 BUILDING SIGNGE: SURFACE PAINTED LETTERING.
- 8 FIBER CEMENT PANEL AT SLOPED SILL
- 9 PROVIDE ANTI-GRAFFITI COATING UP TO THIS HEIGHT  
TYP. ON ALL EXT. WALLS

PAUL MURDOCH  
ARCHITECTS


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LOS ANGELES, CA 90048  
T. 310 358-0993
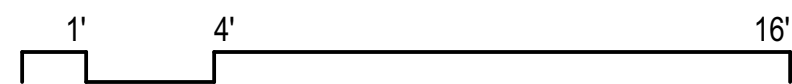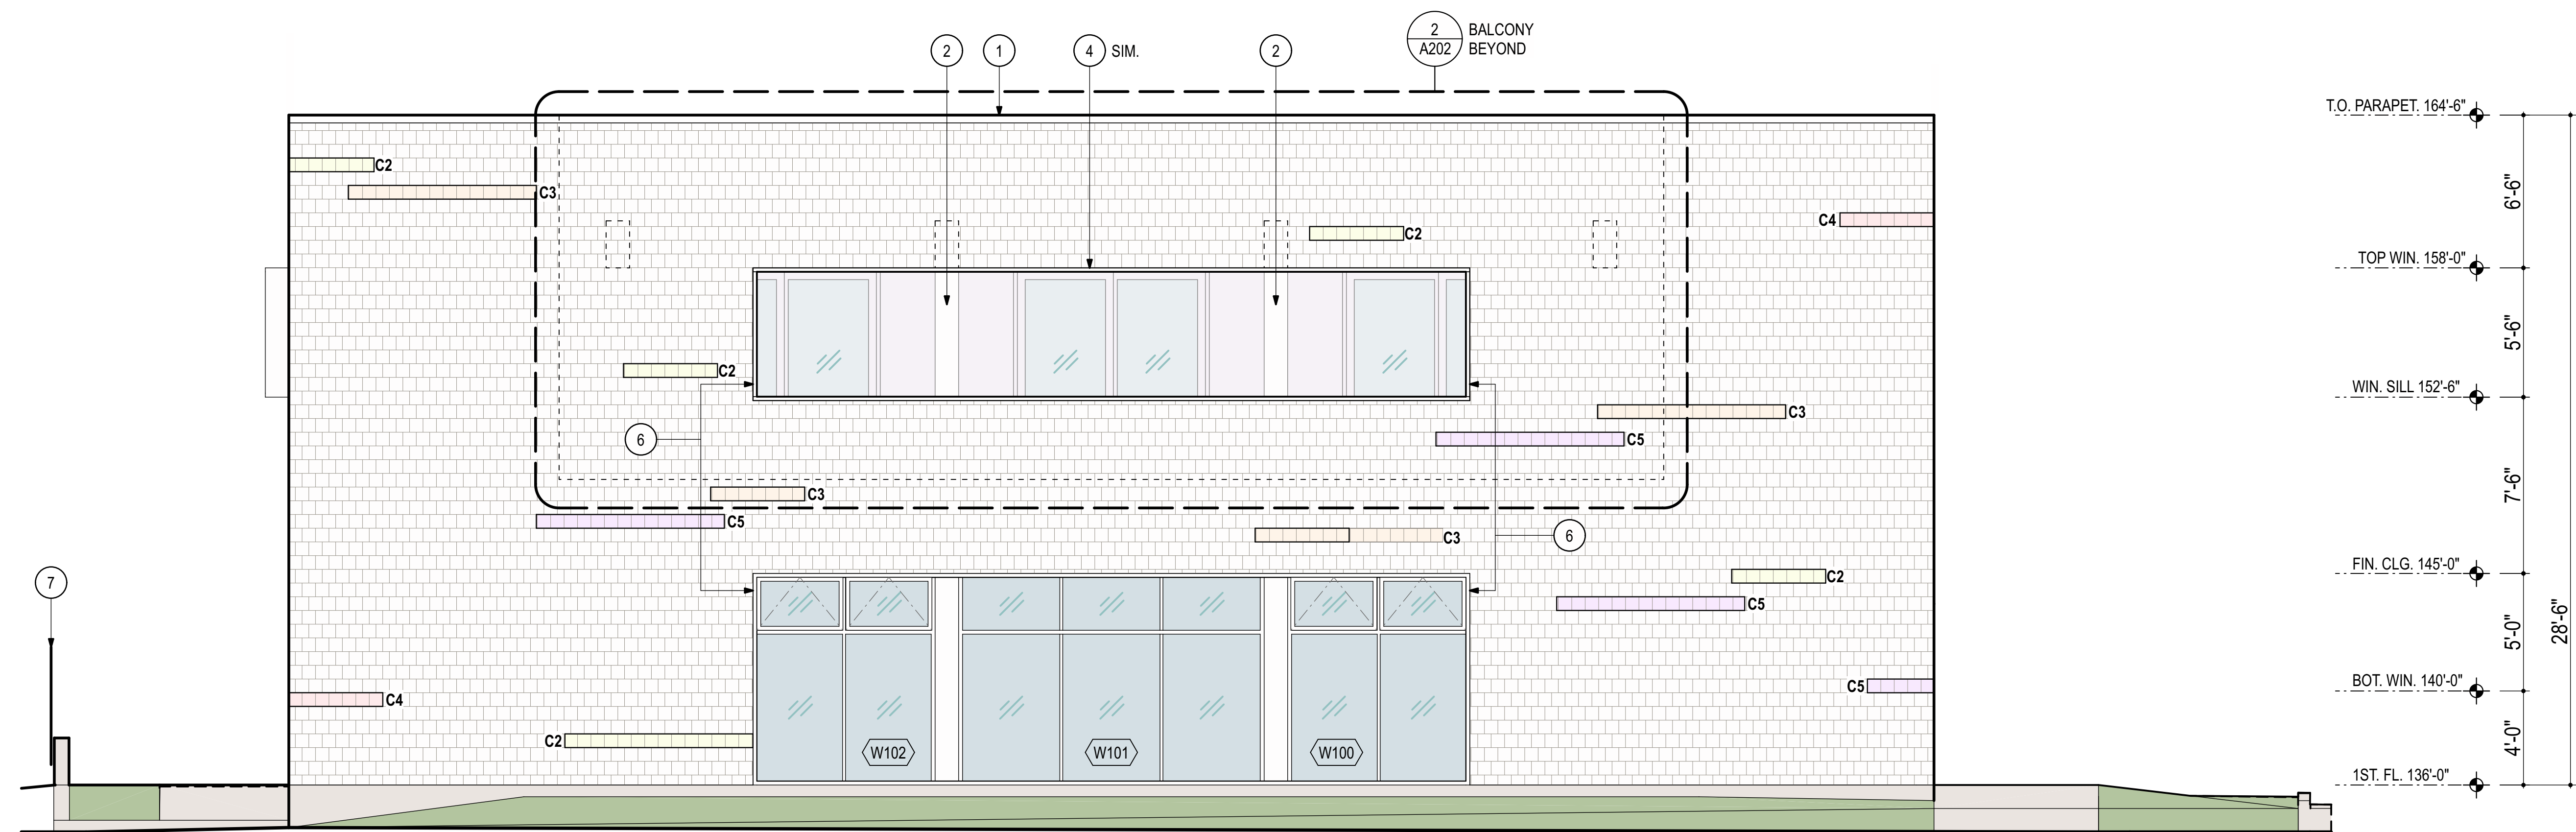
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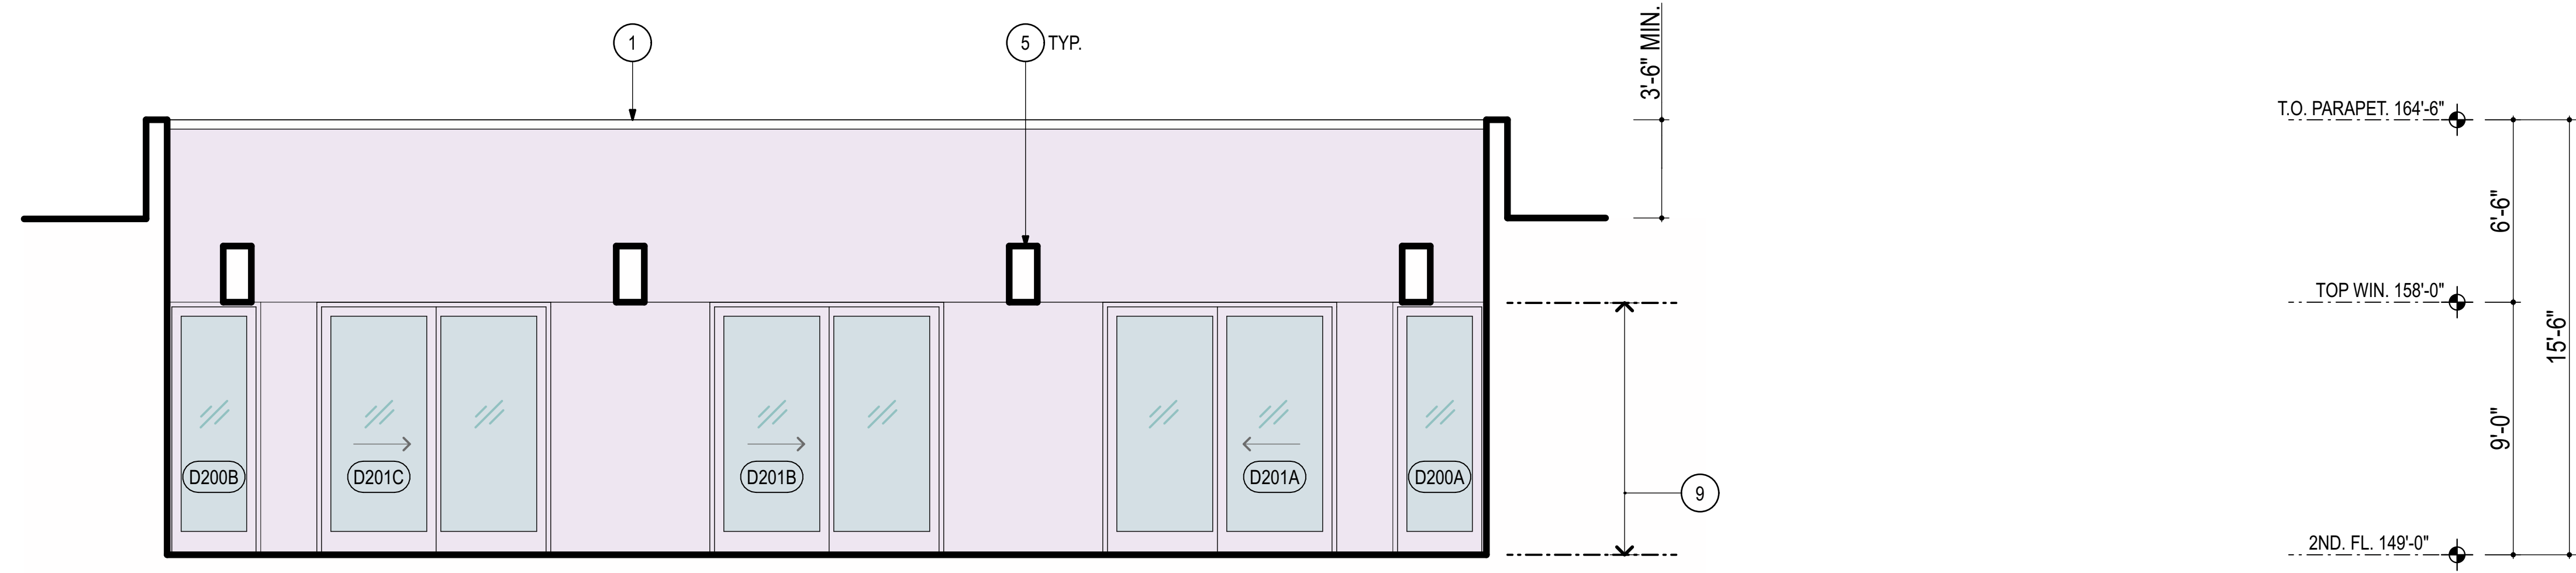
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100% PRELIMINARY DESIGN SUBMITTAL		
PMA PROJECT NO. 23007		
DRAWING TITLE EXTERIOR ELEVATIONS		
SCALE 1/4" = 1'-0"		
DATE 02/28/2024		
DRAWN E.C.		
CHECKED P.M.		
SHEET NO. A201		








NORTH ELEVATION  
SCALE: 1/4" = 1'-0"



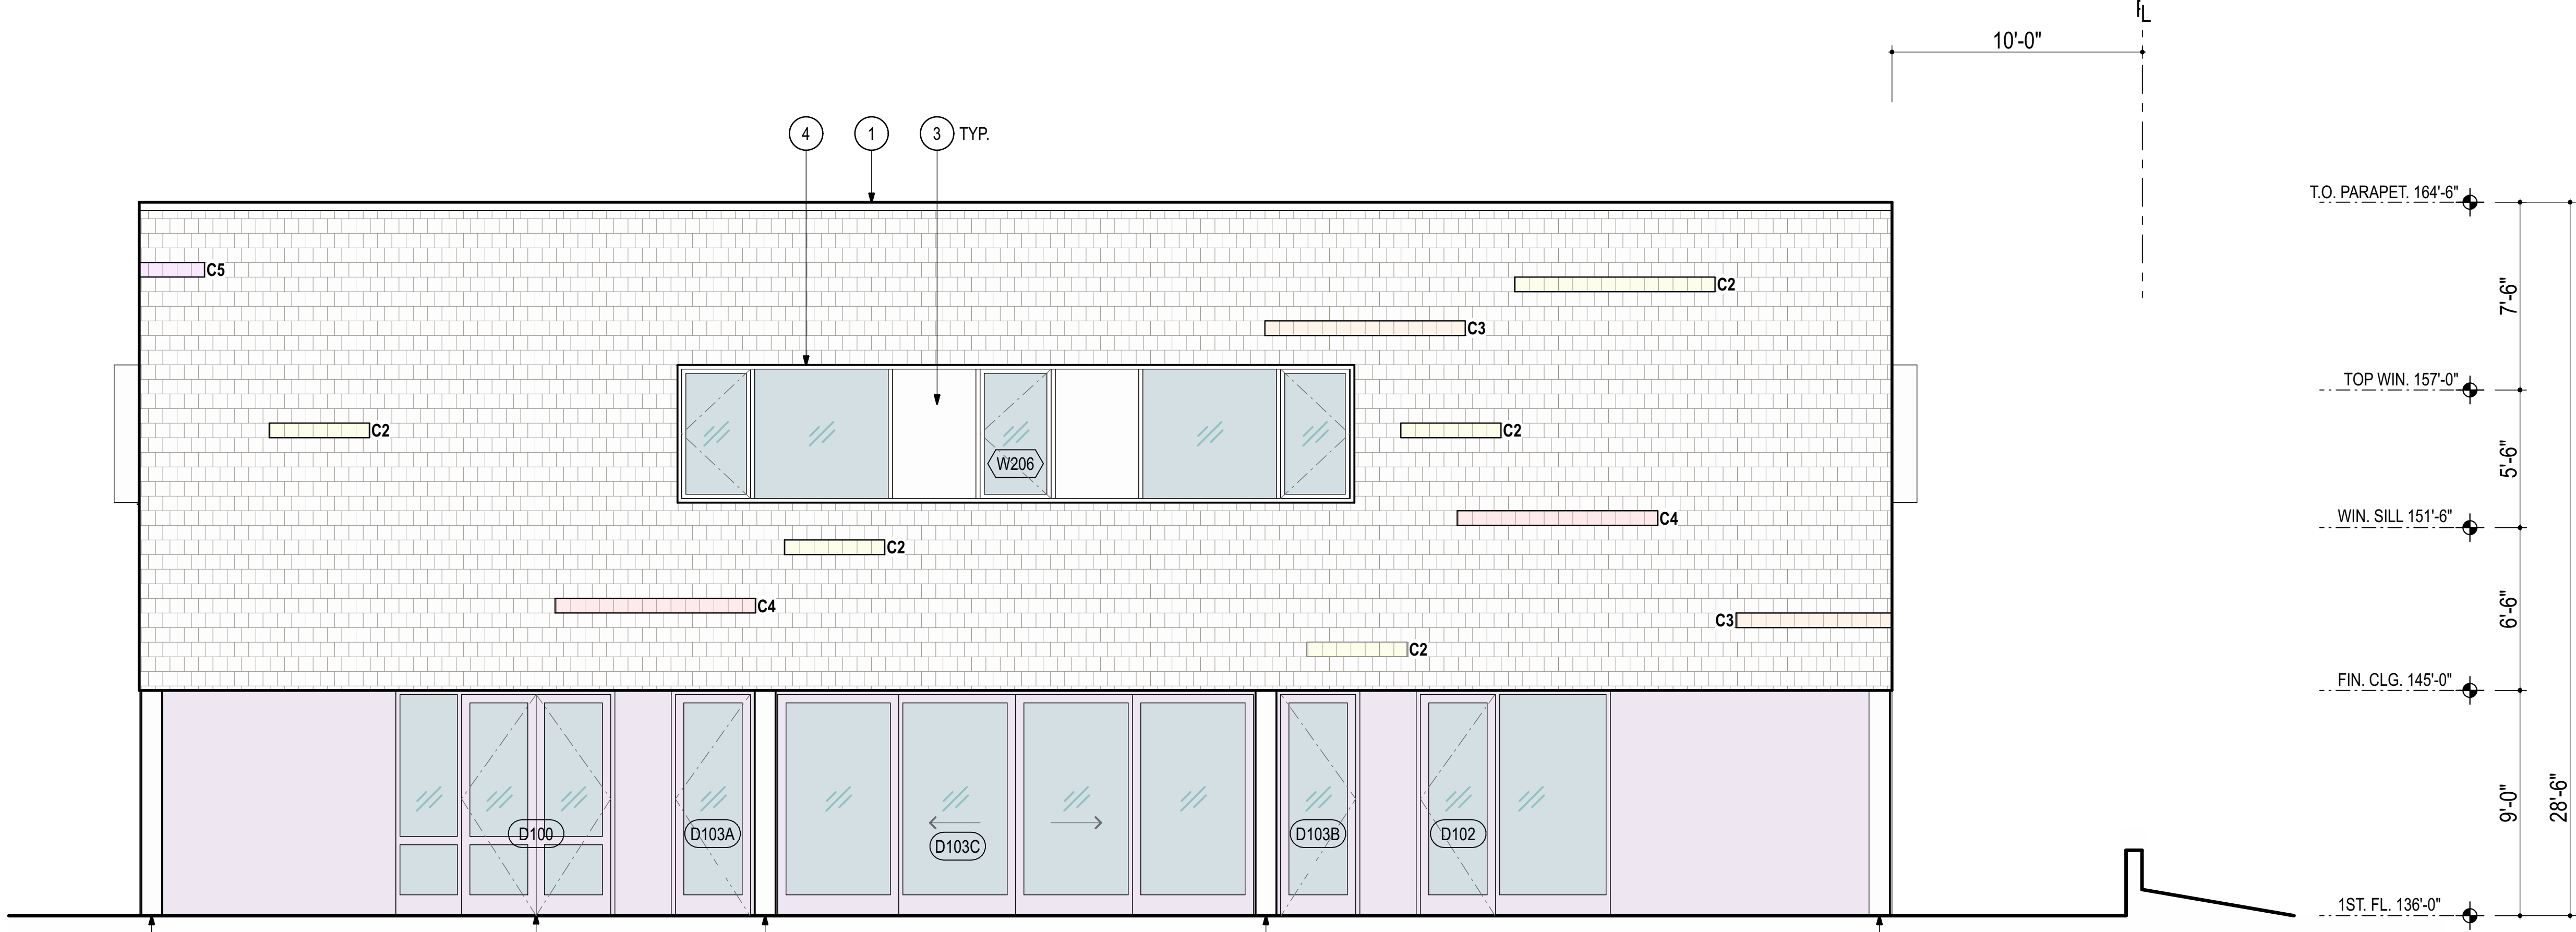NORTH ELEVATION - BALCONY  
SCALE: 1/4" = 1'-0"



SOUTH ELEVATION  
SCALE: 1/4" = 1'-0"

SYMBOL LEGEND

- PTD. SMOOTH PLASTER WALL FINISH  
MATCH C5 COLOR
- FIBER CEMENT SHINGLE SIDING  
COLOR - 01 TYP. U.N.O  
REFER TO COLOR LEGEND BELOW
- GLASS / GLAZING
- CONCRETE
- OPERABLE WINDOW OR DOOR

FIBER CEMENT SIDING COLOR LEGEND

- C1 WHITE PICKET FENCE
- C2 BABY CHICK
- C3 FADING PEACH
- C4 ROSE COVERED COTTAGE
- C5 PERIWINKLE

KEYNOTE LEGEND

- 1 PTD. STL. COPING
- 2 STL. COLUMN W/ METAL COLUMN COVER.
- 3 PTD. INSULATED METAL INFILL PANEL W/ IN FRAMING.
- 4 12" EXTENDED AL. CAP COVERS
- 5 PTD. AL. BEAM ENCLOSURE
- 6 ALIGN
- 7 PTD. AL. SIGN MONUMENT ON CONC BASE
- 8 MAIN ENTRY
- 9 PROVIDE ANTI-GRAFFITI COATING UP TO THIS HEIGHT  
TYP. ON ALL EXT. WALLS



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**allcove**  
BEACH CITIES  
HEALTH DISTRICT

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PMA PROJECT NO.  
23007

DRAWING TITLE  
EXTERIOR  
ELEVATIONS


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DATE  
02/28/2024


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E.C. P.M.

SHEET NO.


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BUILDING SECTION 01  
SCALE: 1/4" = 1'-0" 1

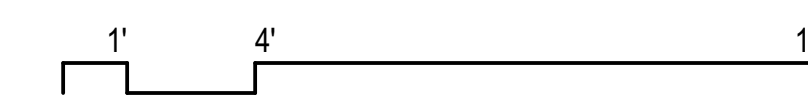

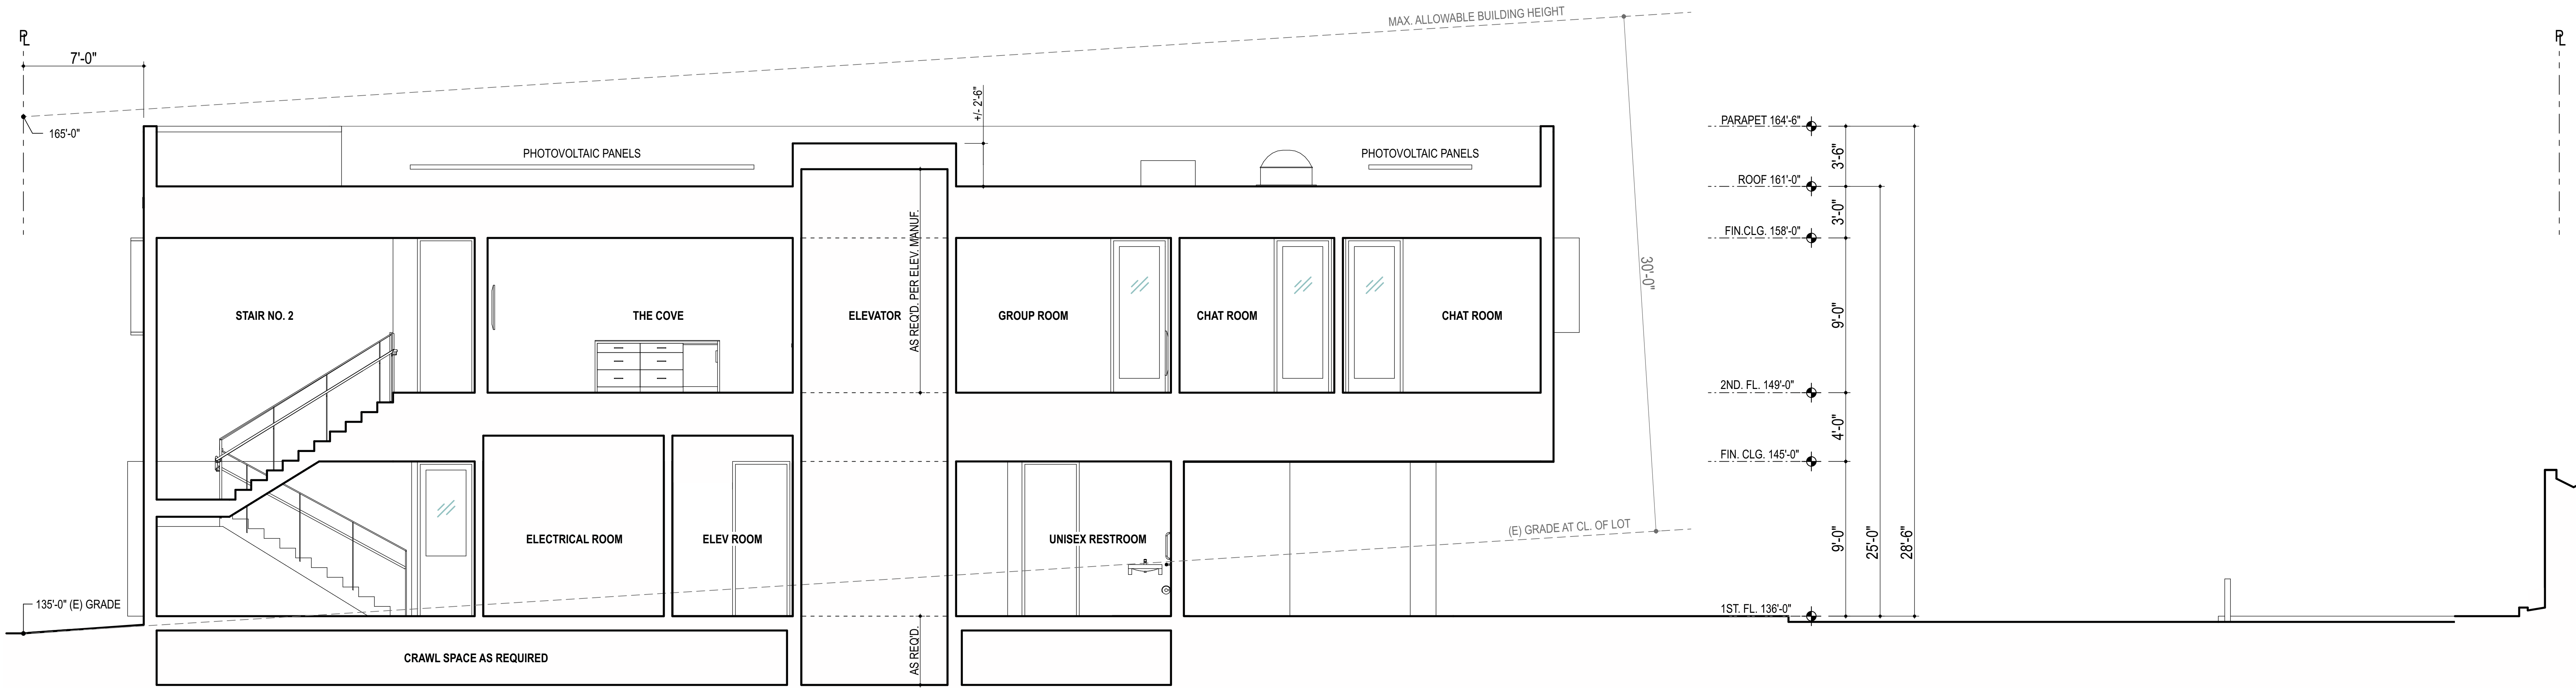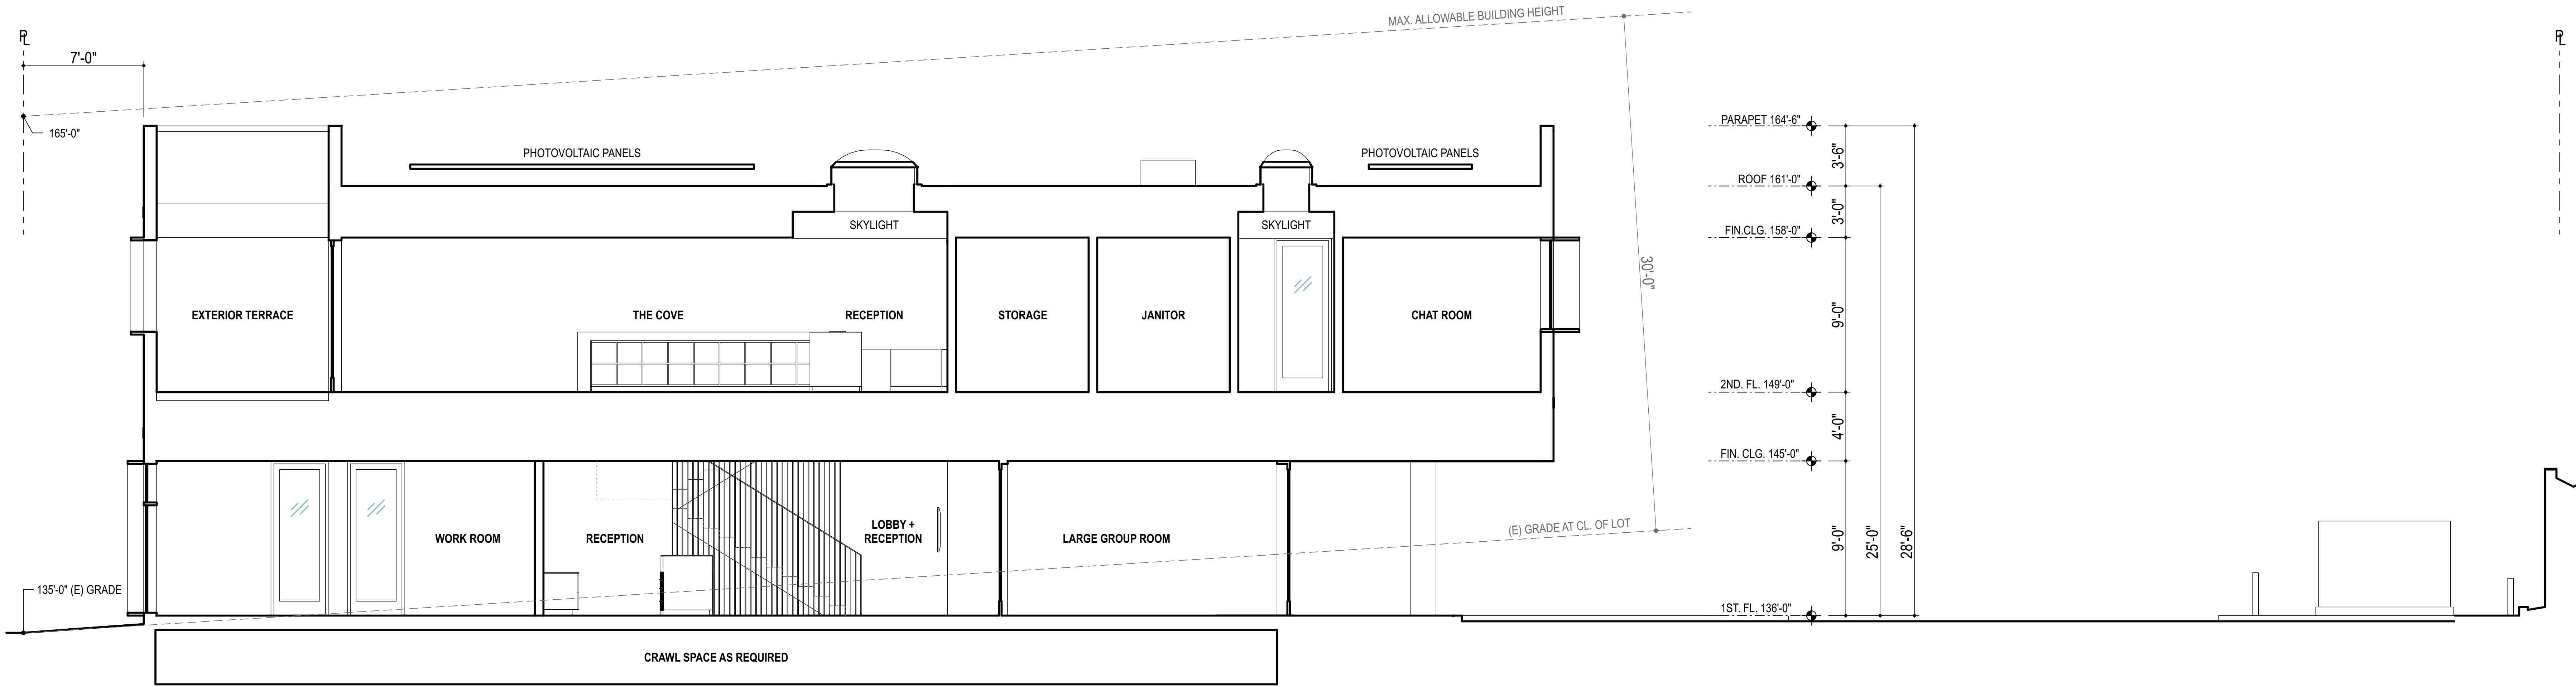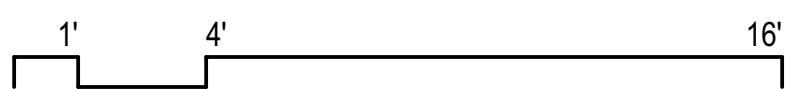
BUILDING SECTION 02  
SCALE: 1/4" = 1'-0" 2

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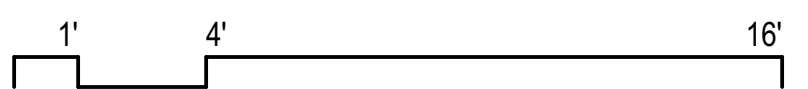
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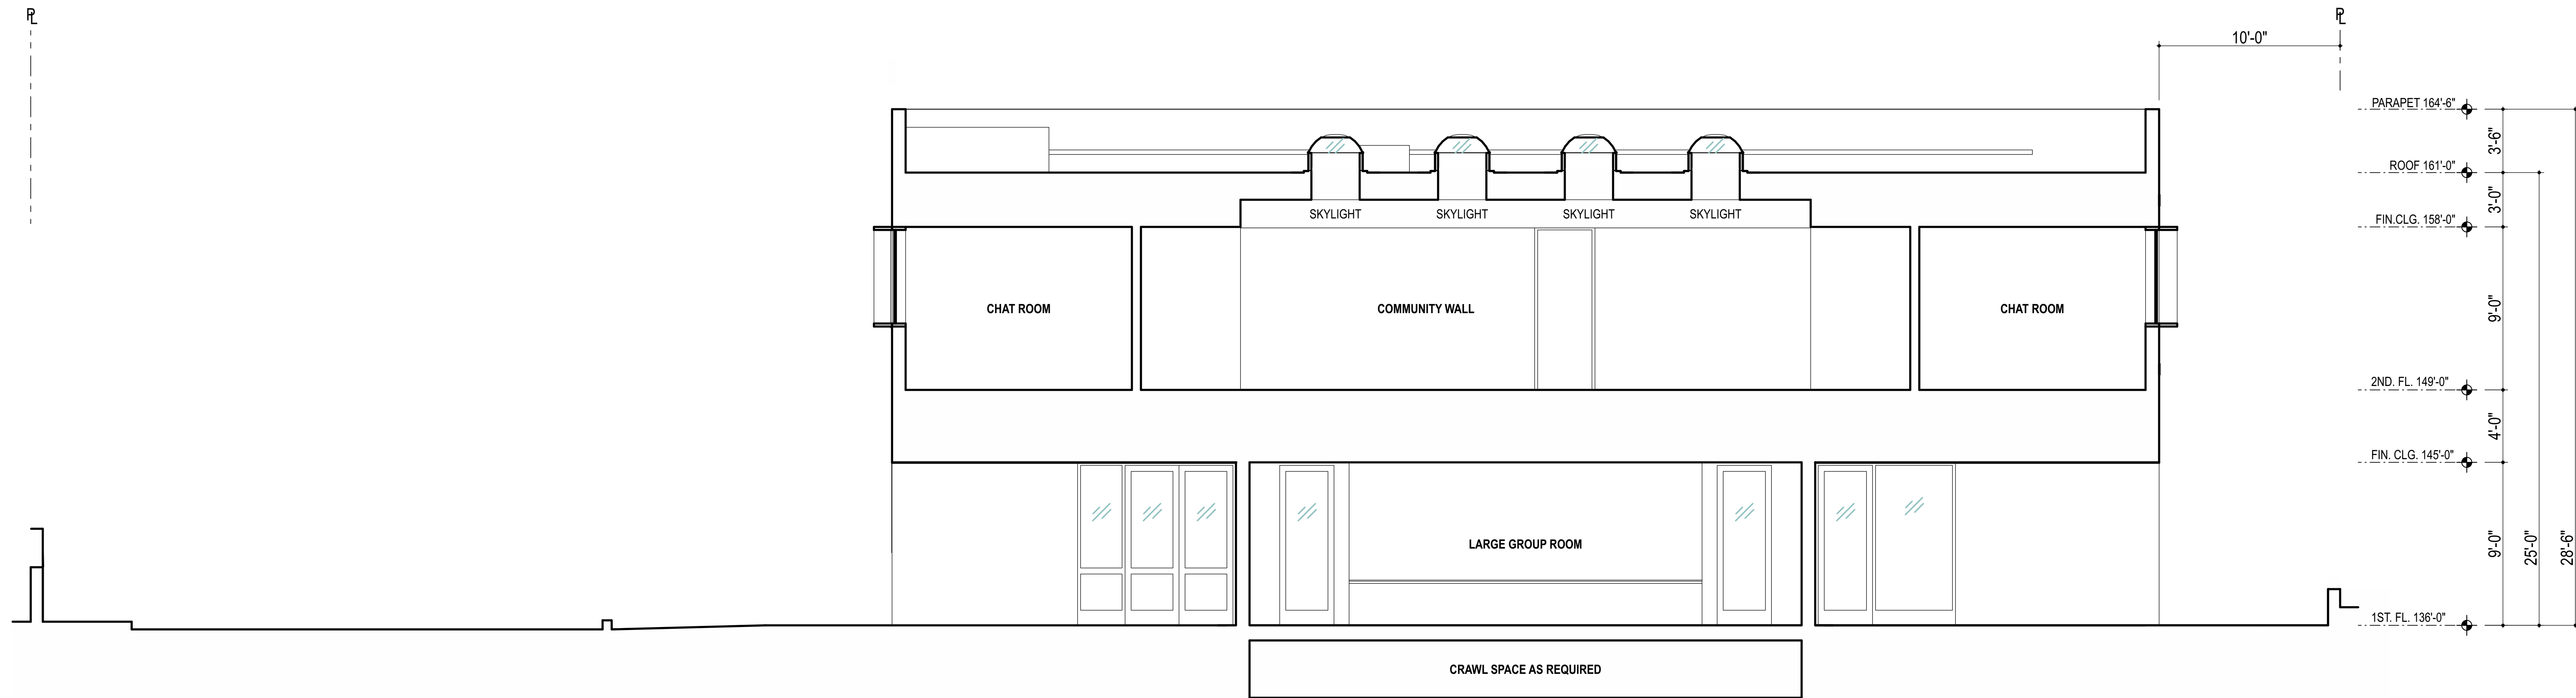
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PMA PROJECT NO. 23007		
DRAWING TITLE BUILDING SECTION		
SCALE 1/4" = 1'-0"		
DATE 02/28/2024		
DRAWN E.C.		
CHECKED P.M.		
SHEET NO. A301		












BUILDING SECTION 05  
SCALE: 1/4" = 1'-0"

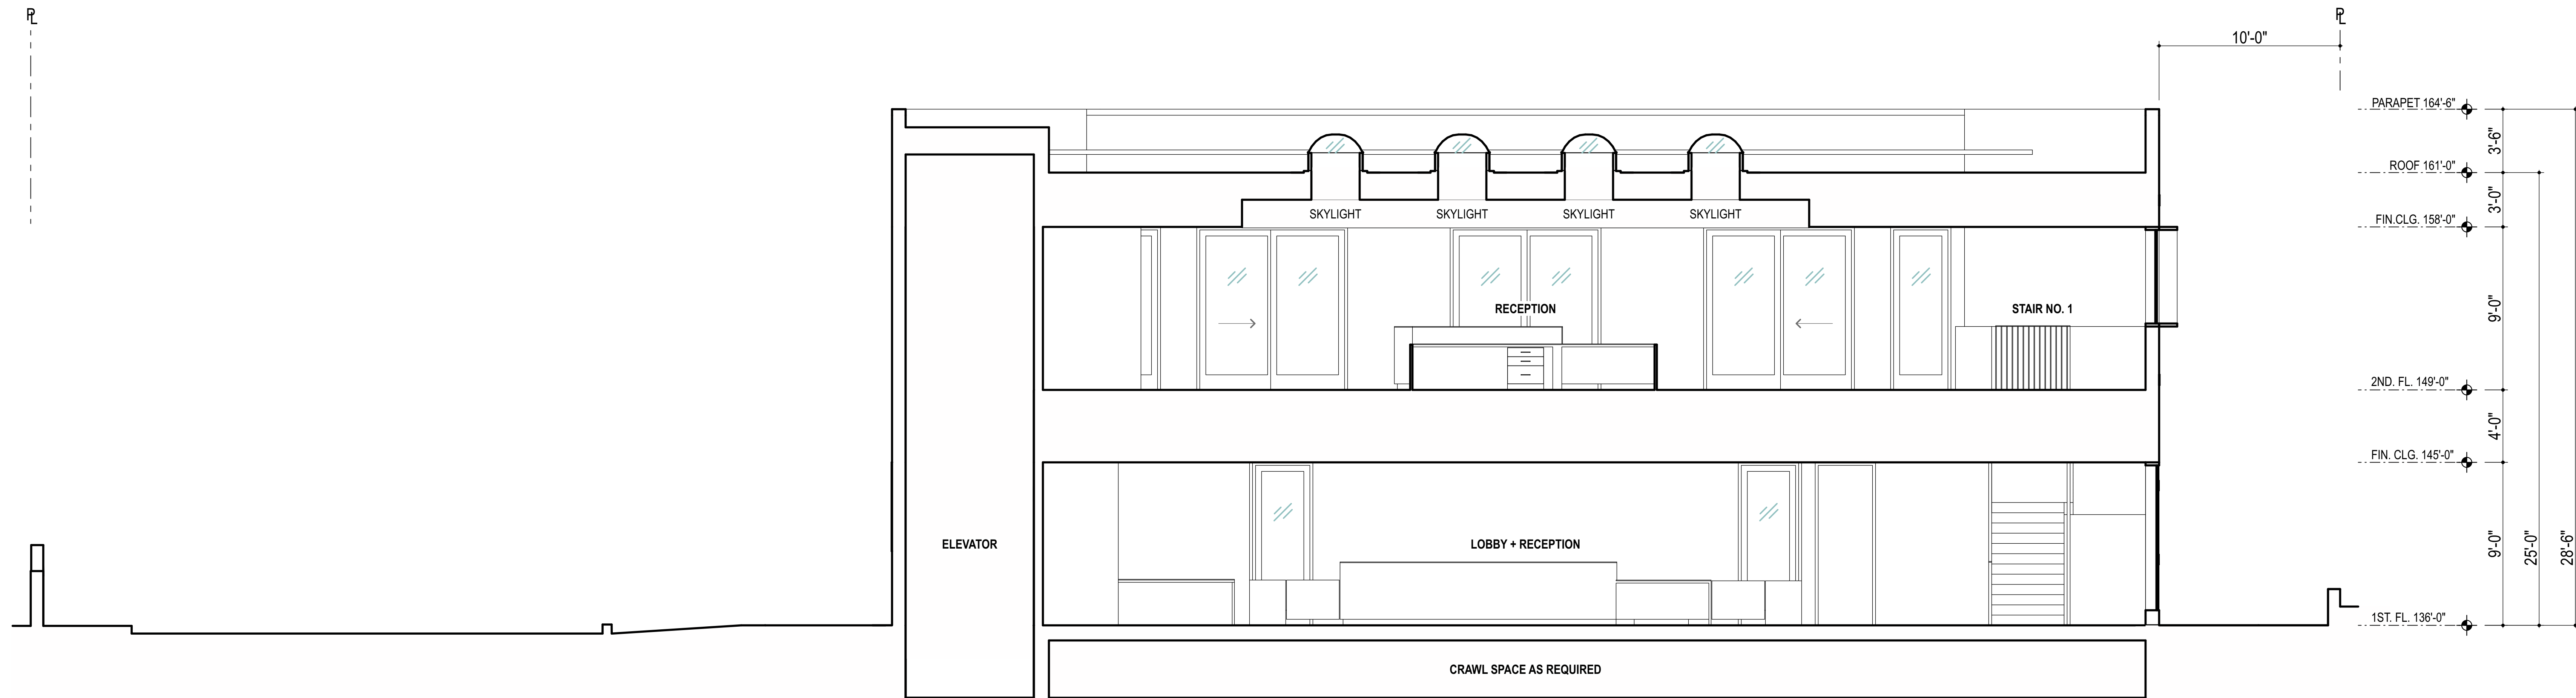1



BUILDING SECTION 06  
SCALE: 1/4" = 1'-0"

2

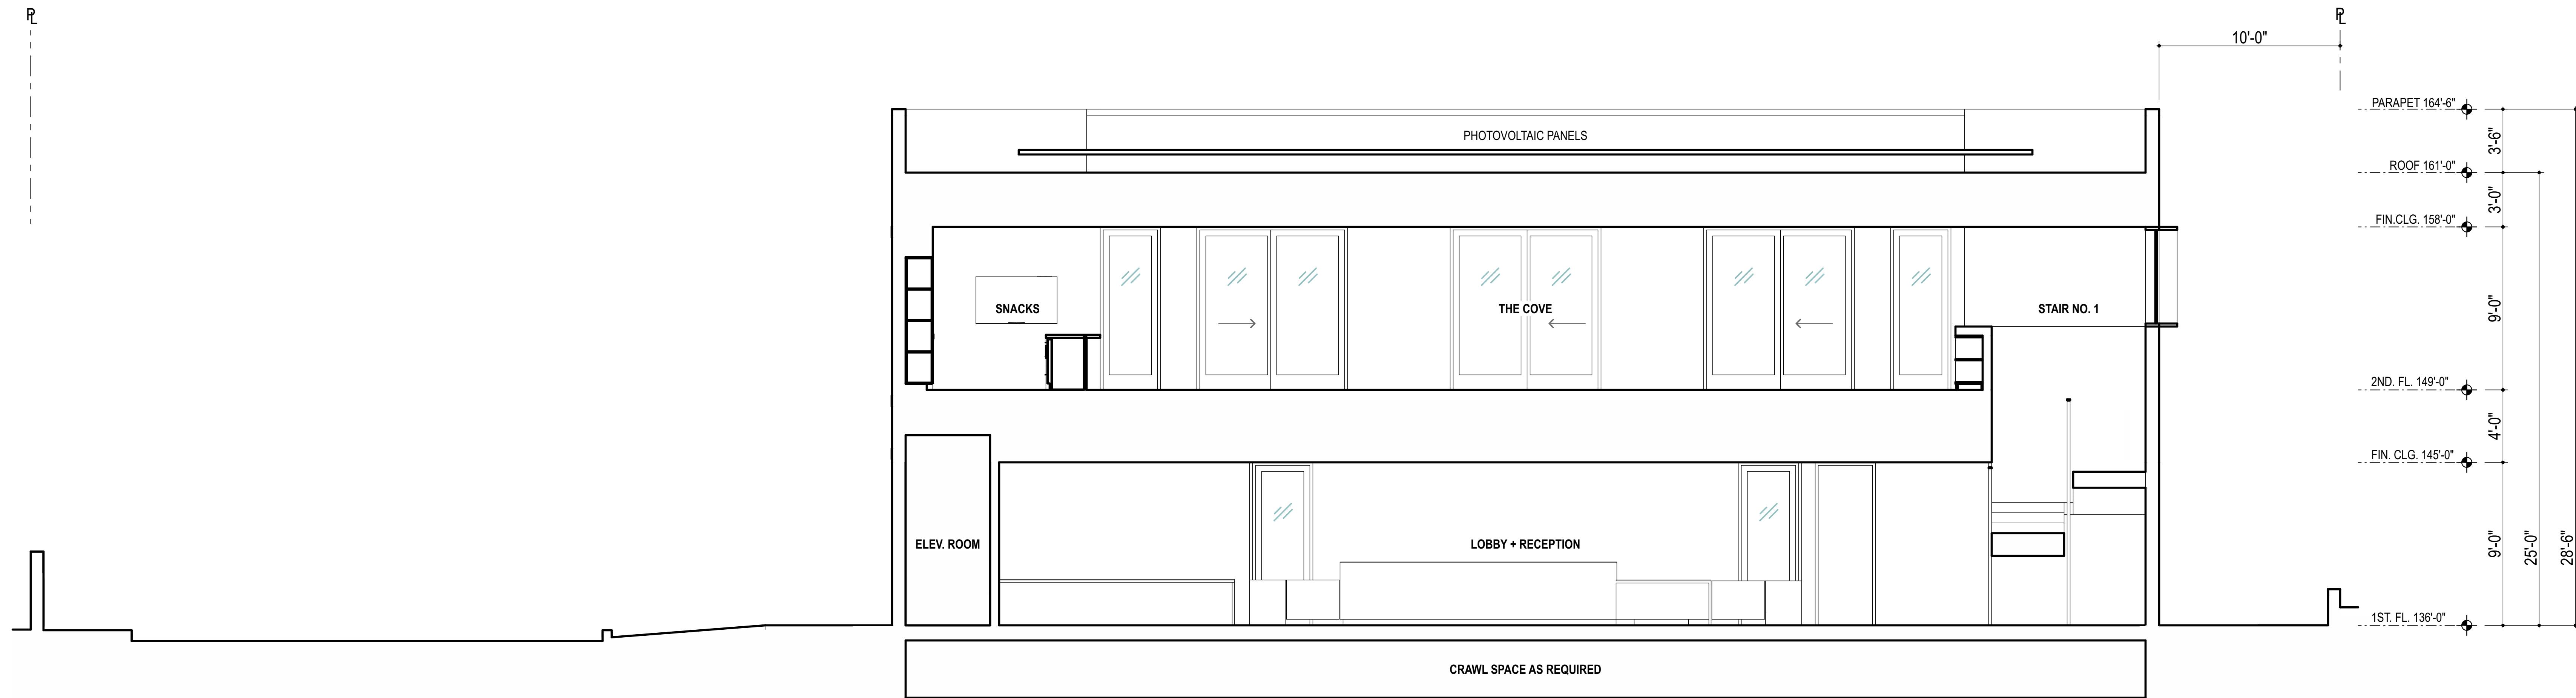
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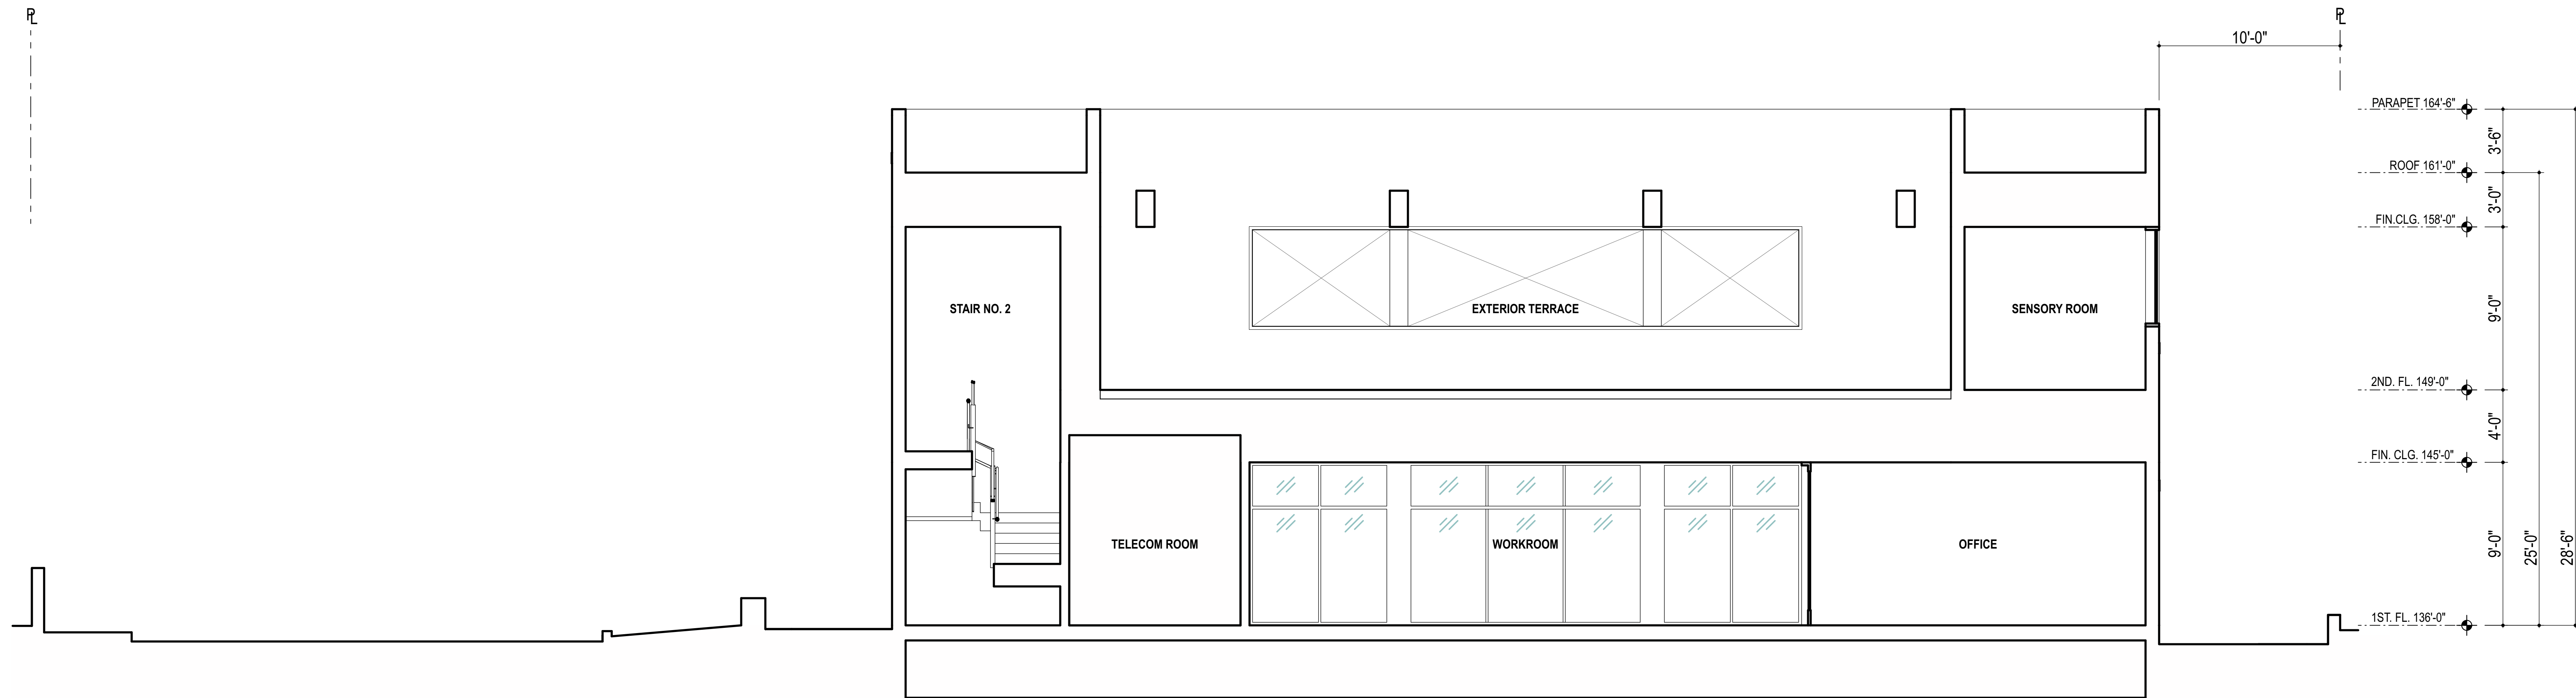
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PMA PROJECT NO. 23007		
DRAWING TITLE BUILDING SECTION		
SCALE 1/4" = 1'-0"		
DATE 02/28/2024		
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BUILDING SECTION 07  
SCALE: 1/4" = 1'-0"

1



BUILDING SECTION 08  
SCALE: 1/4" = 1'-0"

2



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PMA PROJECT NO. 23007		
DRAWING TITLE BUILDING SECTION		
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DATE 02/28/2024		
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3D MASSING - VIEW 07



3D MASSING - VIEW 05



3D MASSING - VIEW 08



3D MASSING - VIEW 06

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PMA PROJECT NO.  
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DRAWING TITLE  
3D VIEWS

SCALE  
N.T.S.

DATE  
02/28/2024

DRAWN  
E.C.

CHECKED  
P.M.

SHEET NO.  
A402

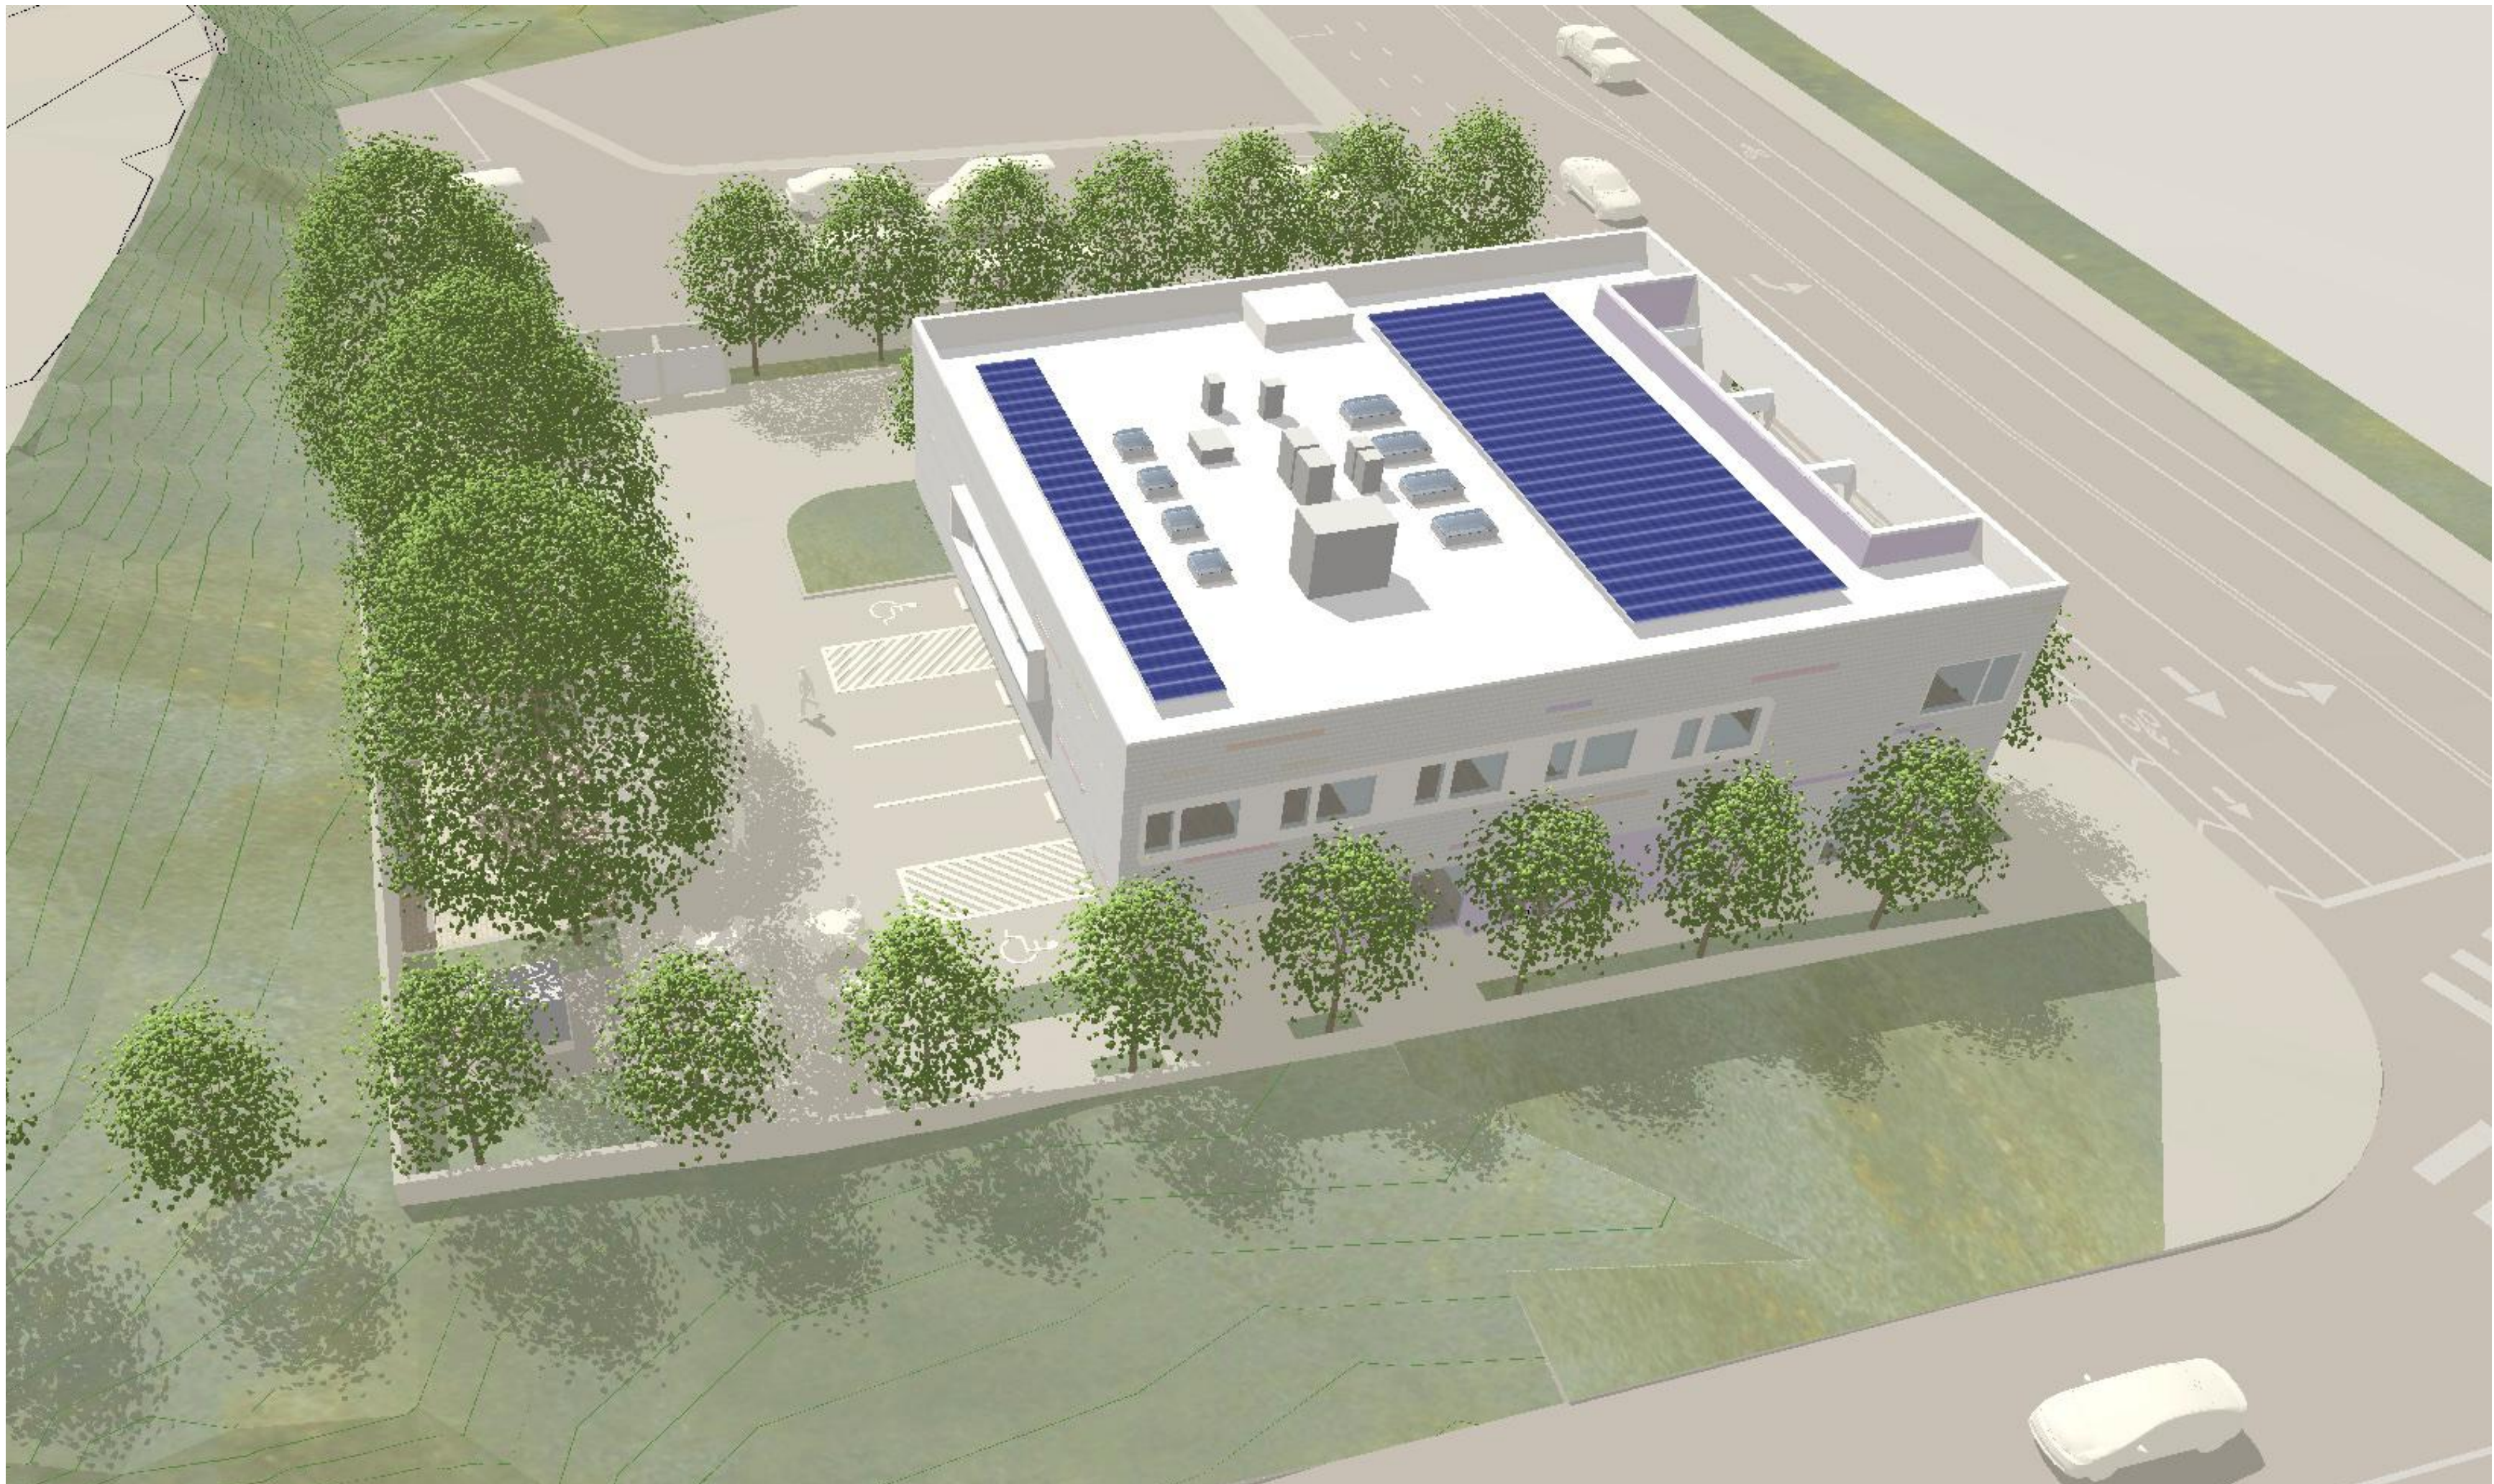




3D MASSING - VIEW 11



3D MASSING - VIEW 09



3D MASSING - VIEW 12



3D MASSING - VIEW 10

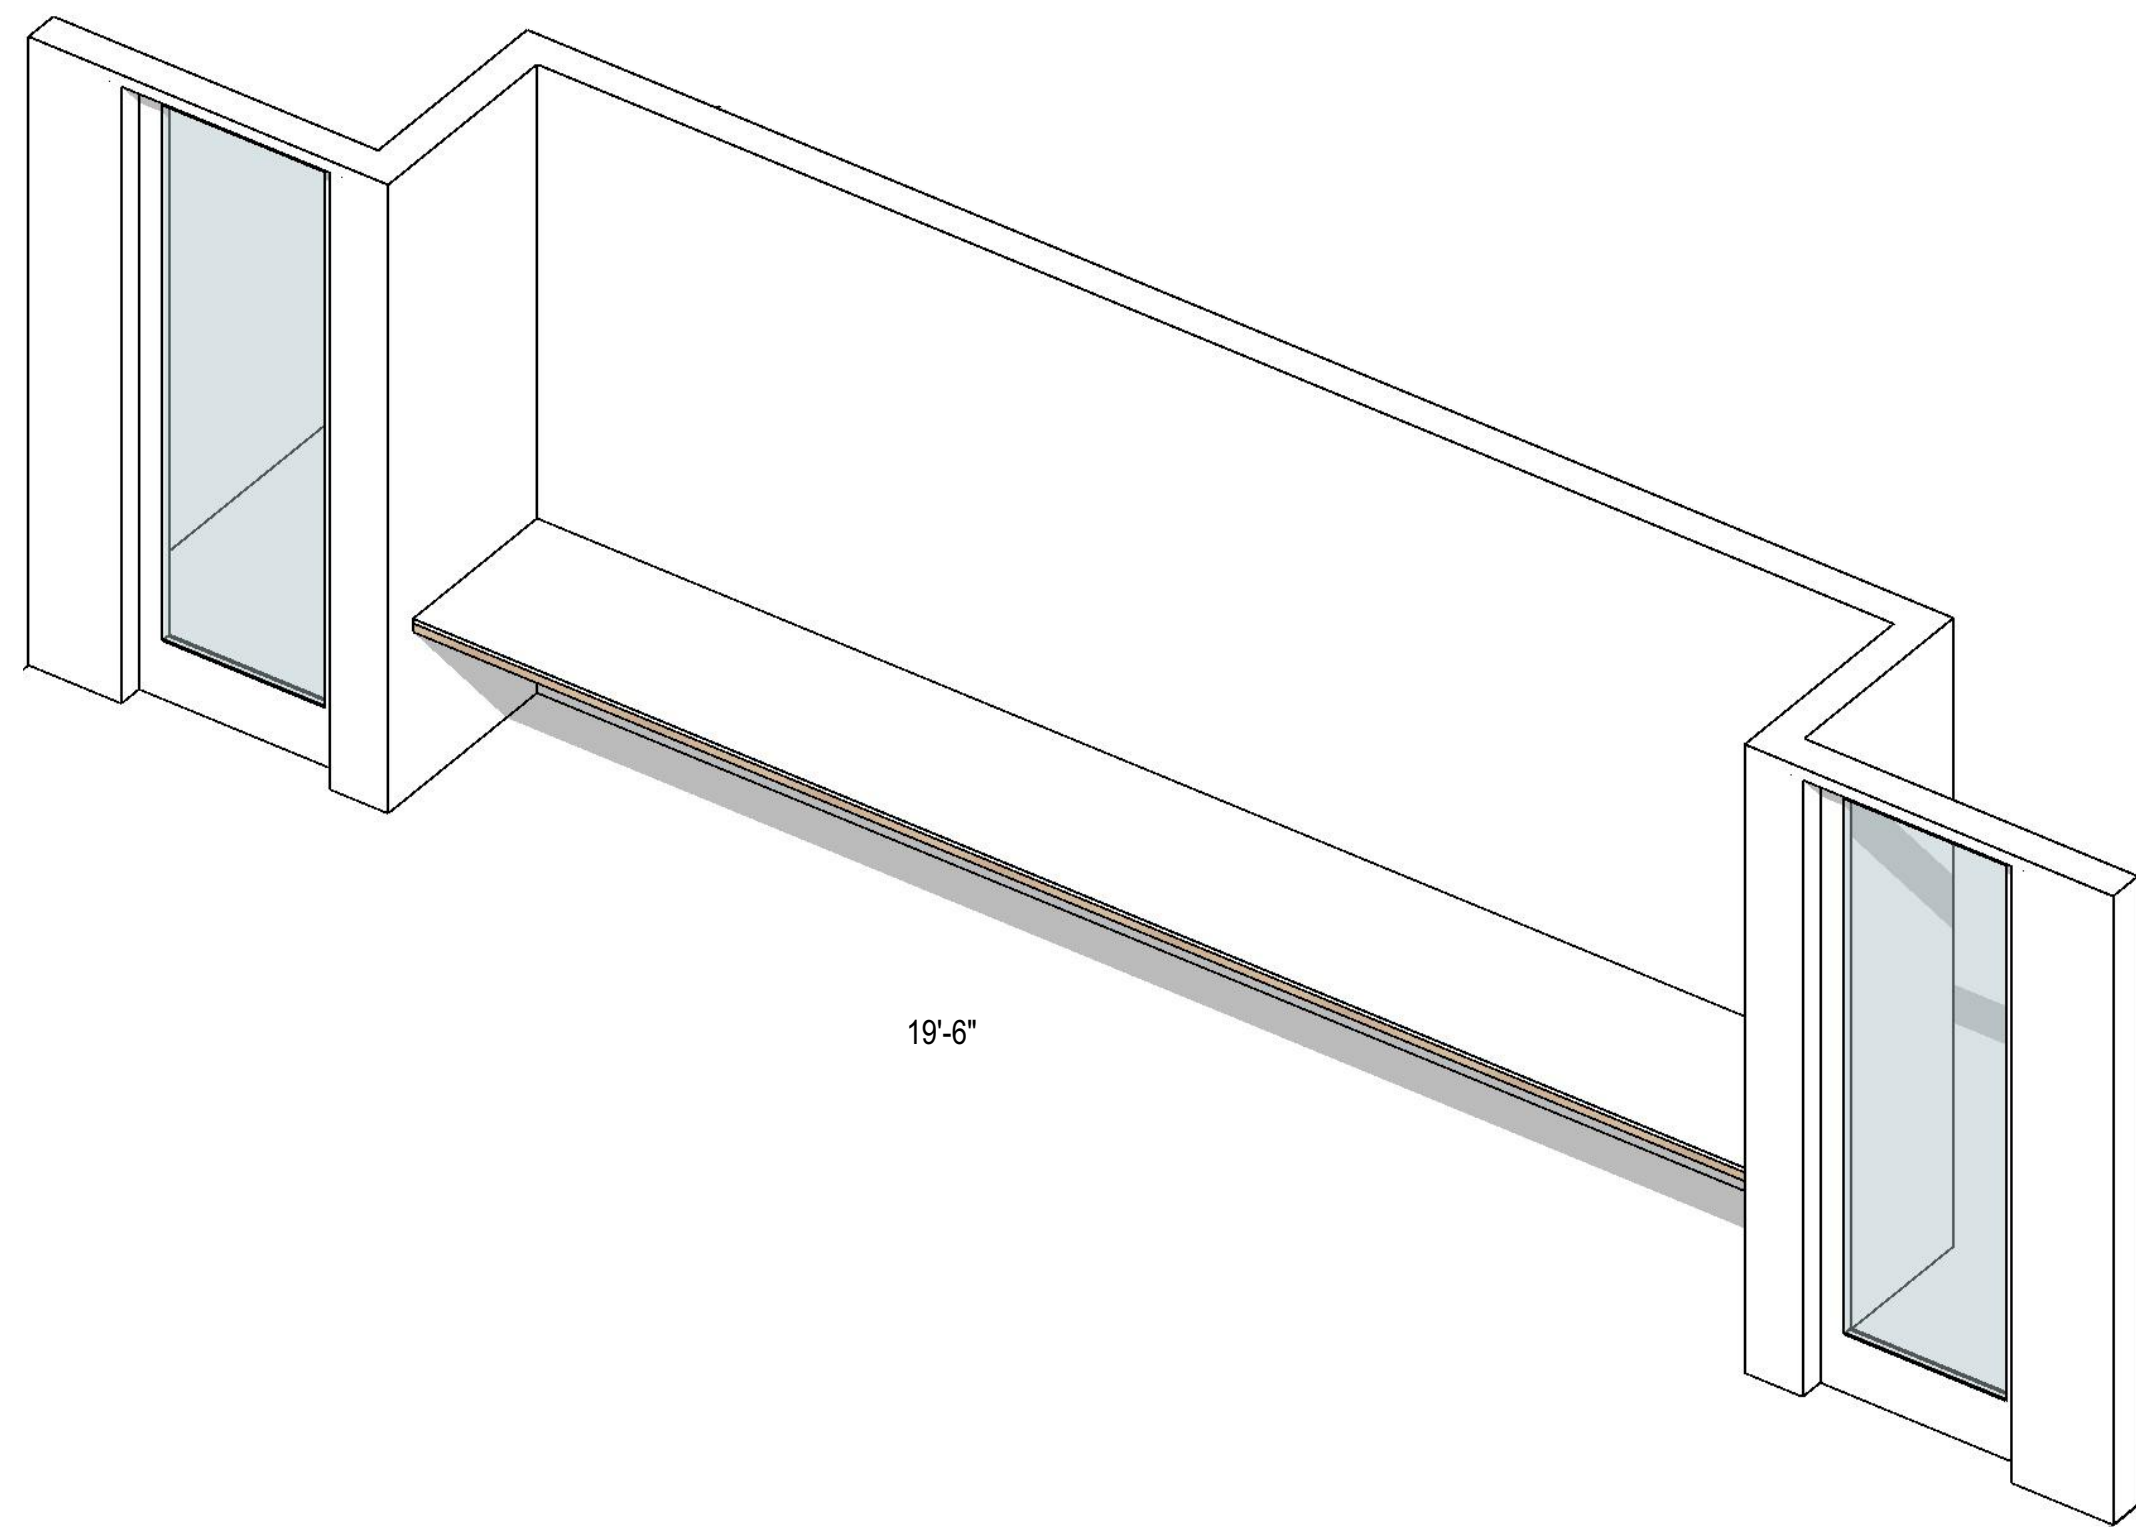
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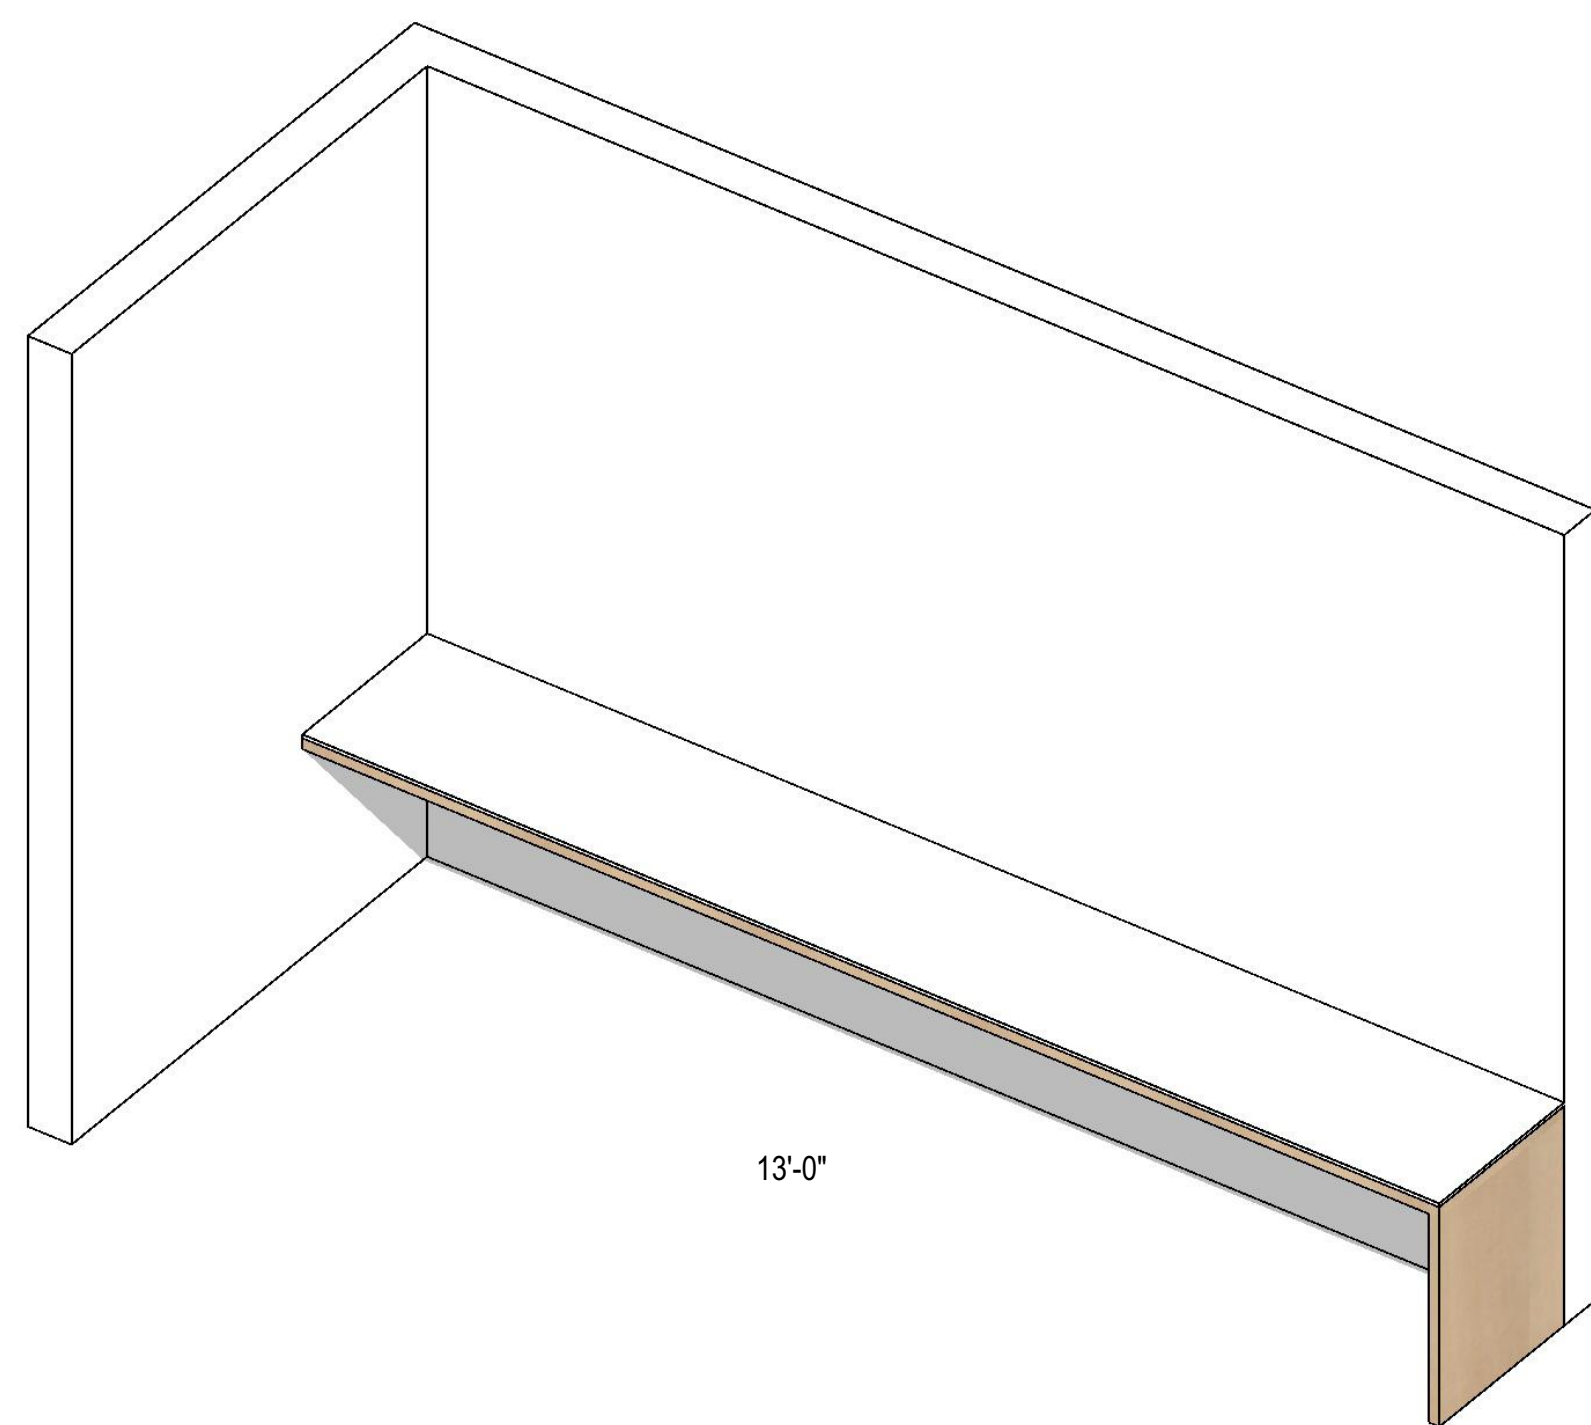
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<b>allcove</b> BEACH CITIES HEALTH DISTRICT		
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PMA PROJECT NO. 23007		
DRAWING TITLE 3D VIEWS		
SCALE N.T.S.		
DATE 02/28/2024		
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SHEET NO. A403		






#### 4 WORKSTATION COUNTERTOP MPR

- COUNTERTOP** • SOLID SURFACE TOP W/ PROTRUDING BULLNOSE EDGE
- BASE CABINETS** • 1 1/2" THICK x 24" DEEP FIN. PLYWOOD COUNTERTOP SUBSTRUCTURE  
• PTD. STEEL IN-WALL / CONCEALED L-BRACKET  
• PROVIDE BRACKET SPACING AS REQUIRED




#### 3 WORKSTATION COUNTERTOP LOBBY

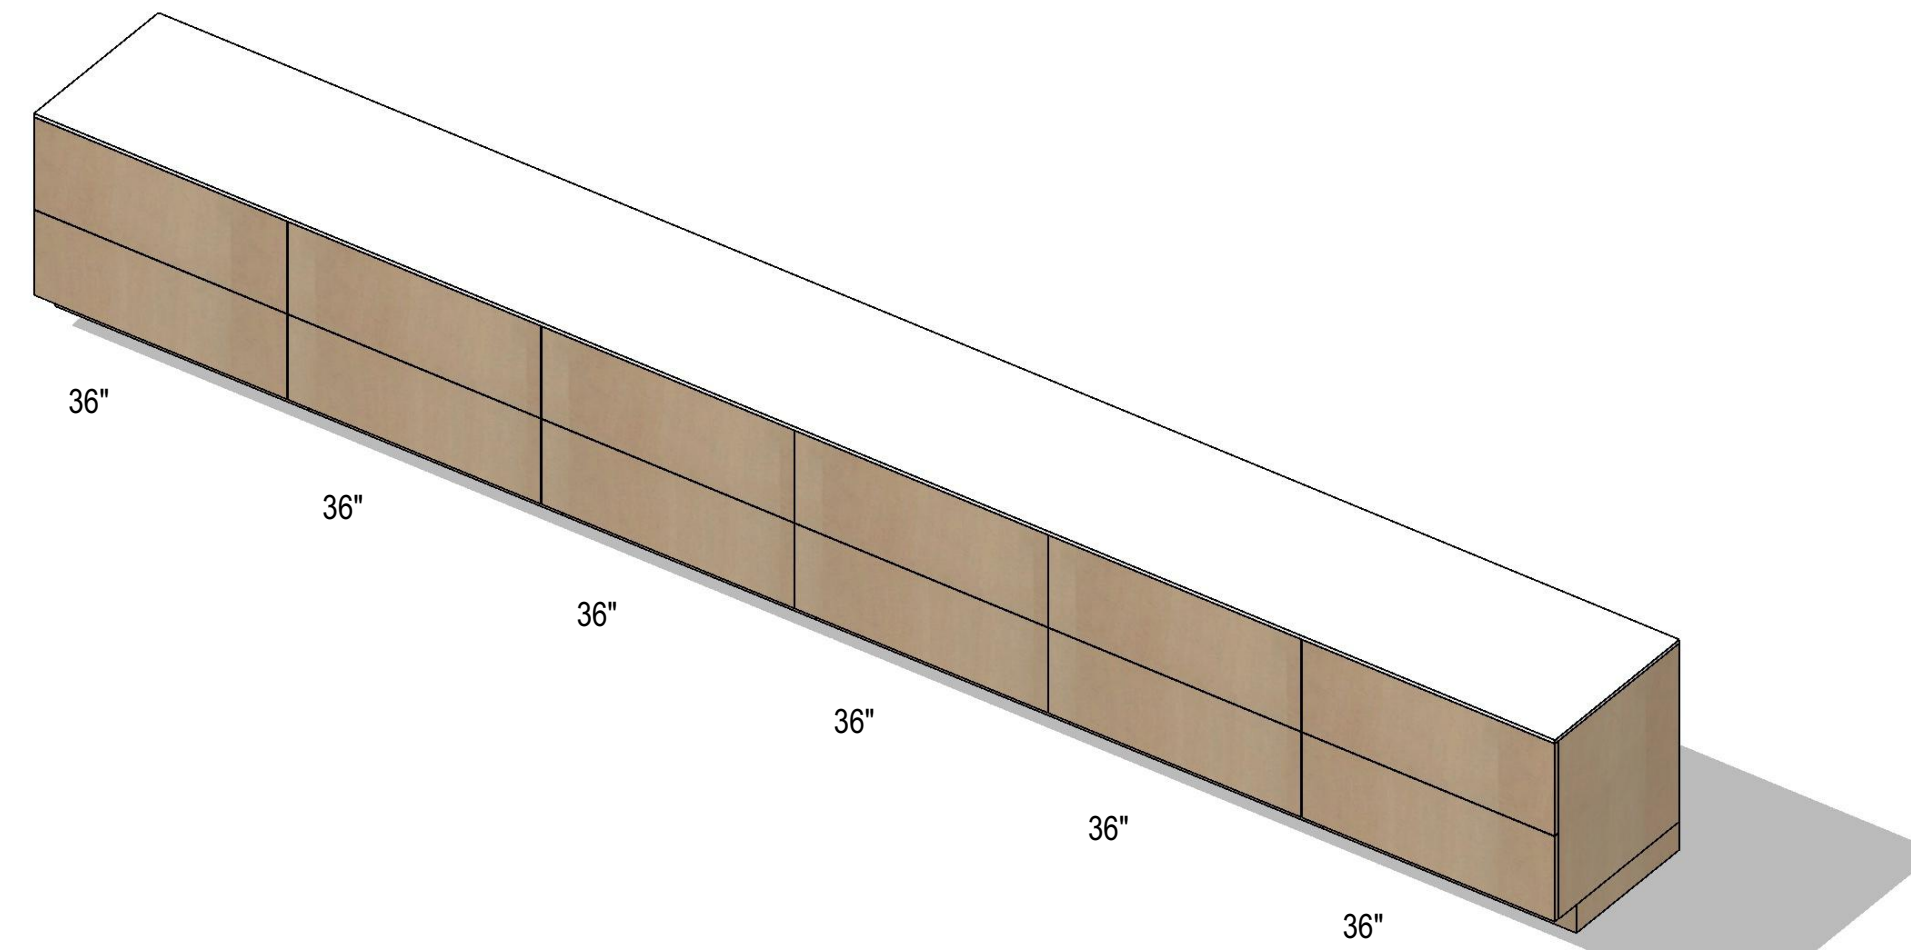- COUNTERTOP** • SOLID SURFACE TOP W/ PROTRUDING BULLNOSE EDGE
- BASE CABINETS** • 1 1/2" THICK FINISHED PLYWOOD COUNTERTOP SUBSTRUCTURE  
• PTD. STEEL IN-WALL / CONCEALED L-BRACKET  
• PROVIDE BRACKET SPACING AS REQUIRED  
• 1 1/2" THICK FINISHED PLYWOOD WATERFALL EDGE




#### 1 RECEPTION STORAGE CONSOLE

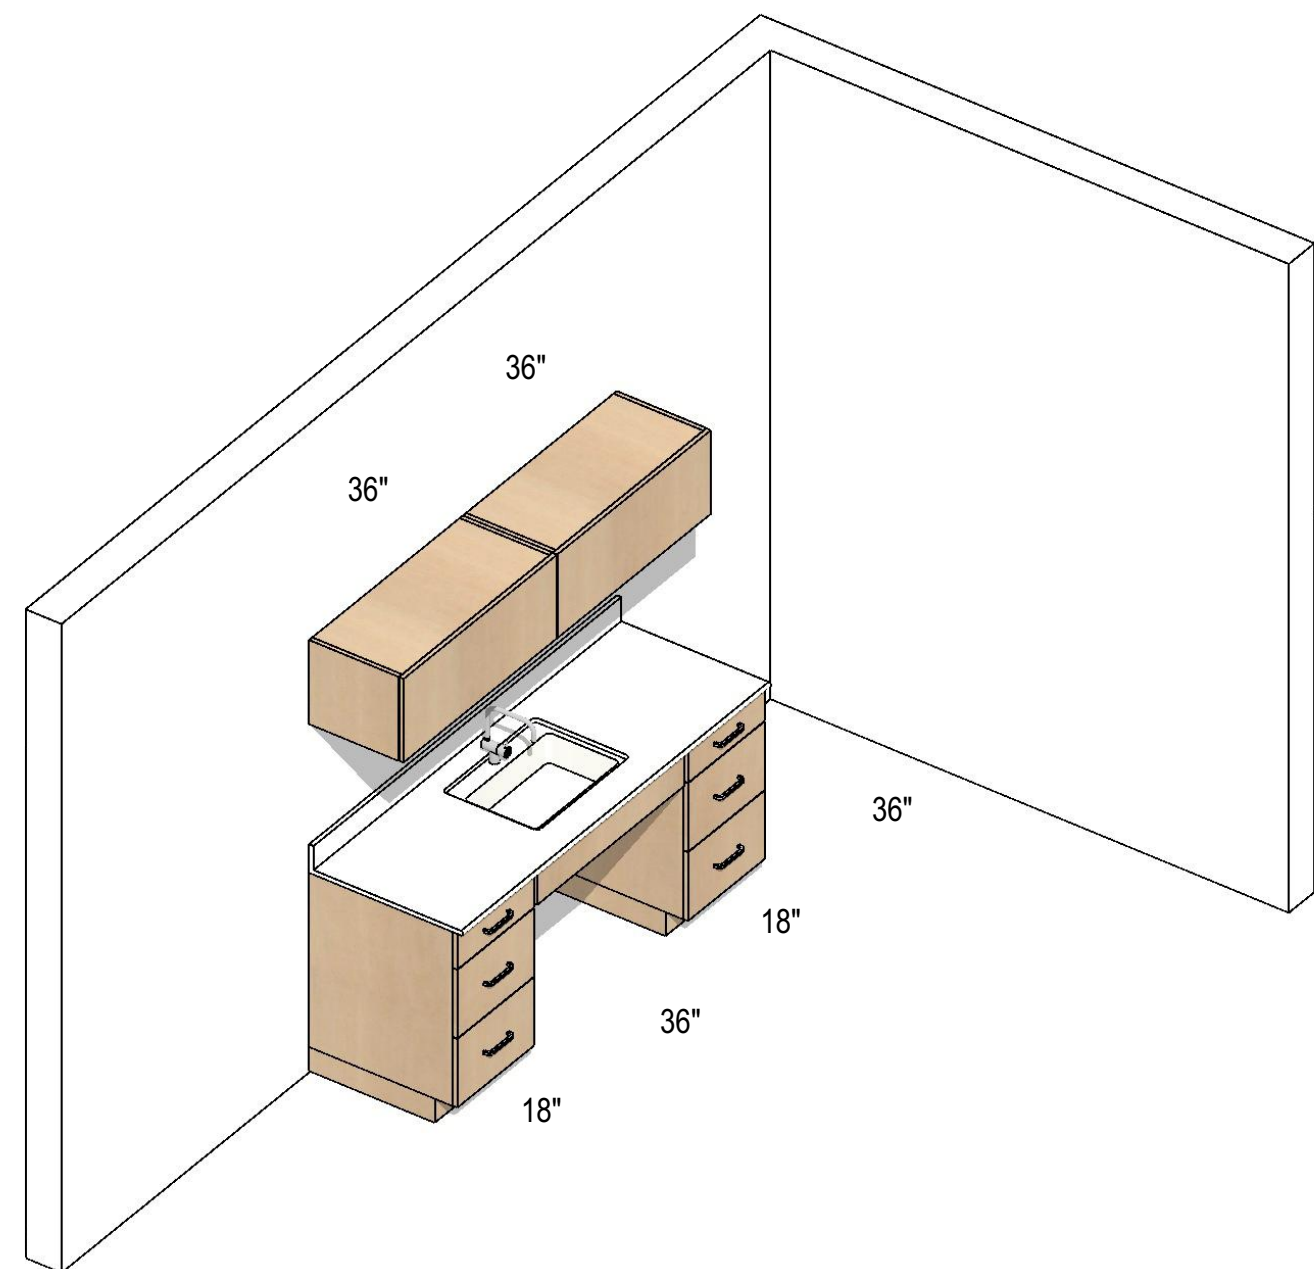- COUNTERTOP** • SOLID SURFACE TOP
- BASE CABINETS** • SIX 36" WIDE x 24" DEEP x 29" HIGH BASE CABINETS  
• 2 LATERAL FILE DRAWERS
- BASE / KICK** • 4" HIGH PLYWOOD KICK SET BACK 3" FROM FACE OF CABINET




#### 6 BREAKROOM CASEWORK

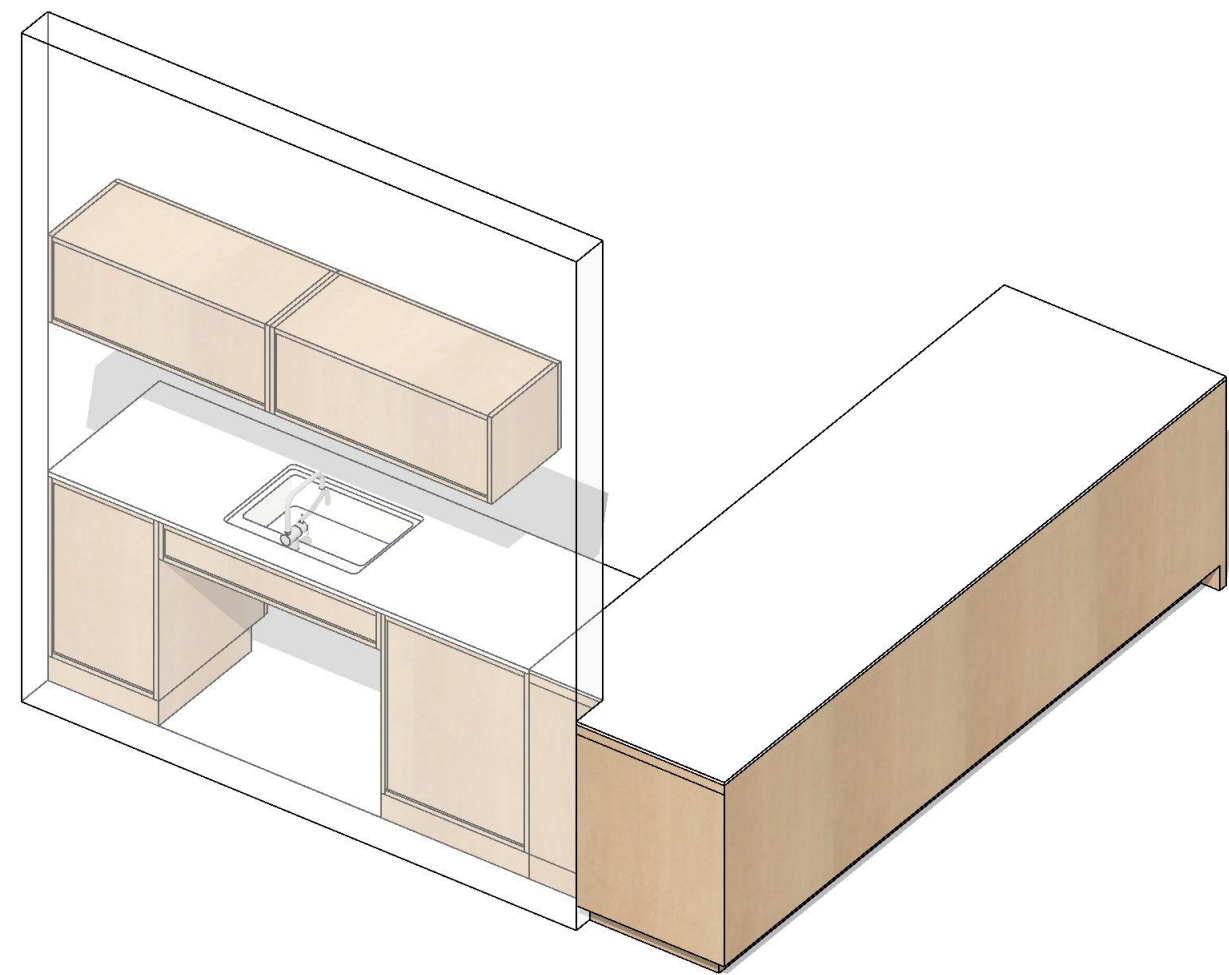- COUNTERTOP** • SOLID SURFACE TOP W/ PROTRUDING BULLNOSE FRONT EDGE  
• SOLID SURFACE SPLASH 4" HIGH
- BASE CABINETS** • TWO 18" WIDE x 24" DEEP x 33" HIGH CABINETS EITHER SIDE OF SINK  
• 6" HIGH TOP DRAWER + 2 EQ. DRAWERS BELOW  
• 18" WIDE x 24" DEEP ACCESSIBLE CABINET W/ UNDERMOUNT SINK  
• 6" HIGH FIXED PANEL AT FACE TO ALIGN W/ 6" HIGH DRAWER  
• PROVIDE ACCESSIBLE KNEE + TOE CLEARANCE AREA AT SINK  
• PROVIDE INSULATED EXPOSED PIPING
- BASE / KICK** • 4" HIGH PLYWOOD KICK SET BACK 3" FROM FACE OF CABINET
- WALL CABINETS** • TWO 36" WIDE x 14" DEEP x 14" HIGH WALL CABINETS  
• BASE OF CABINET +24" TO COUNTERTOP SURFACE  
• REFER TO ELEC. FOR UNDERCABINET LIGHTING



#### 5 CAFE WORK + SERVICE COUNTER

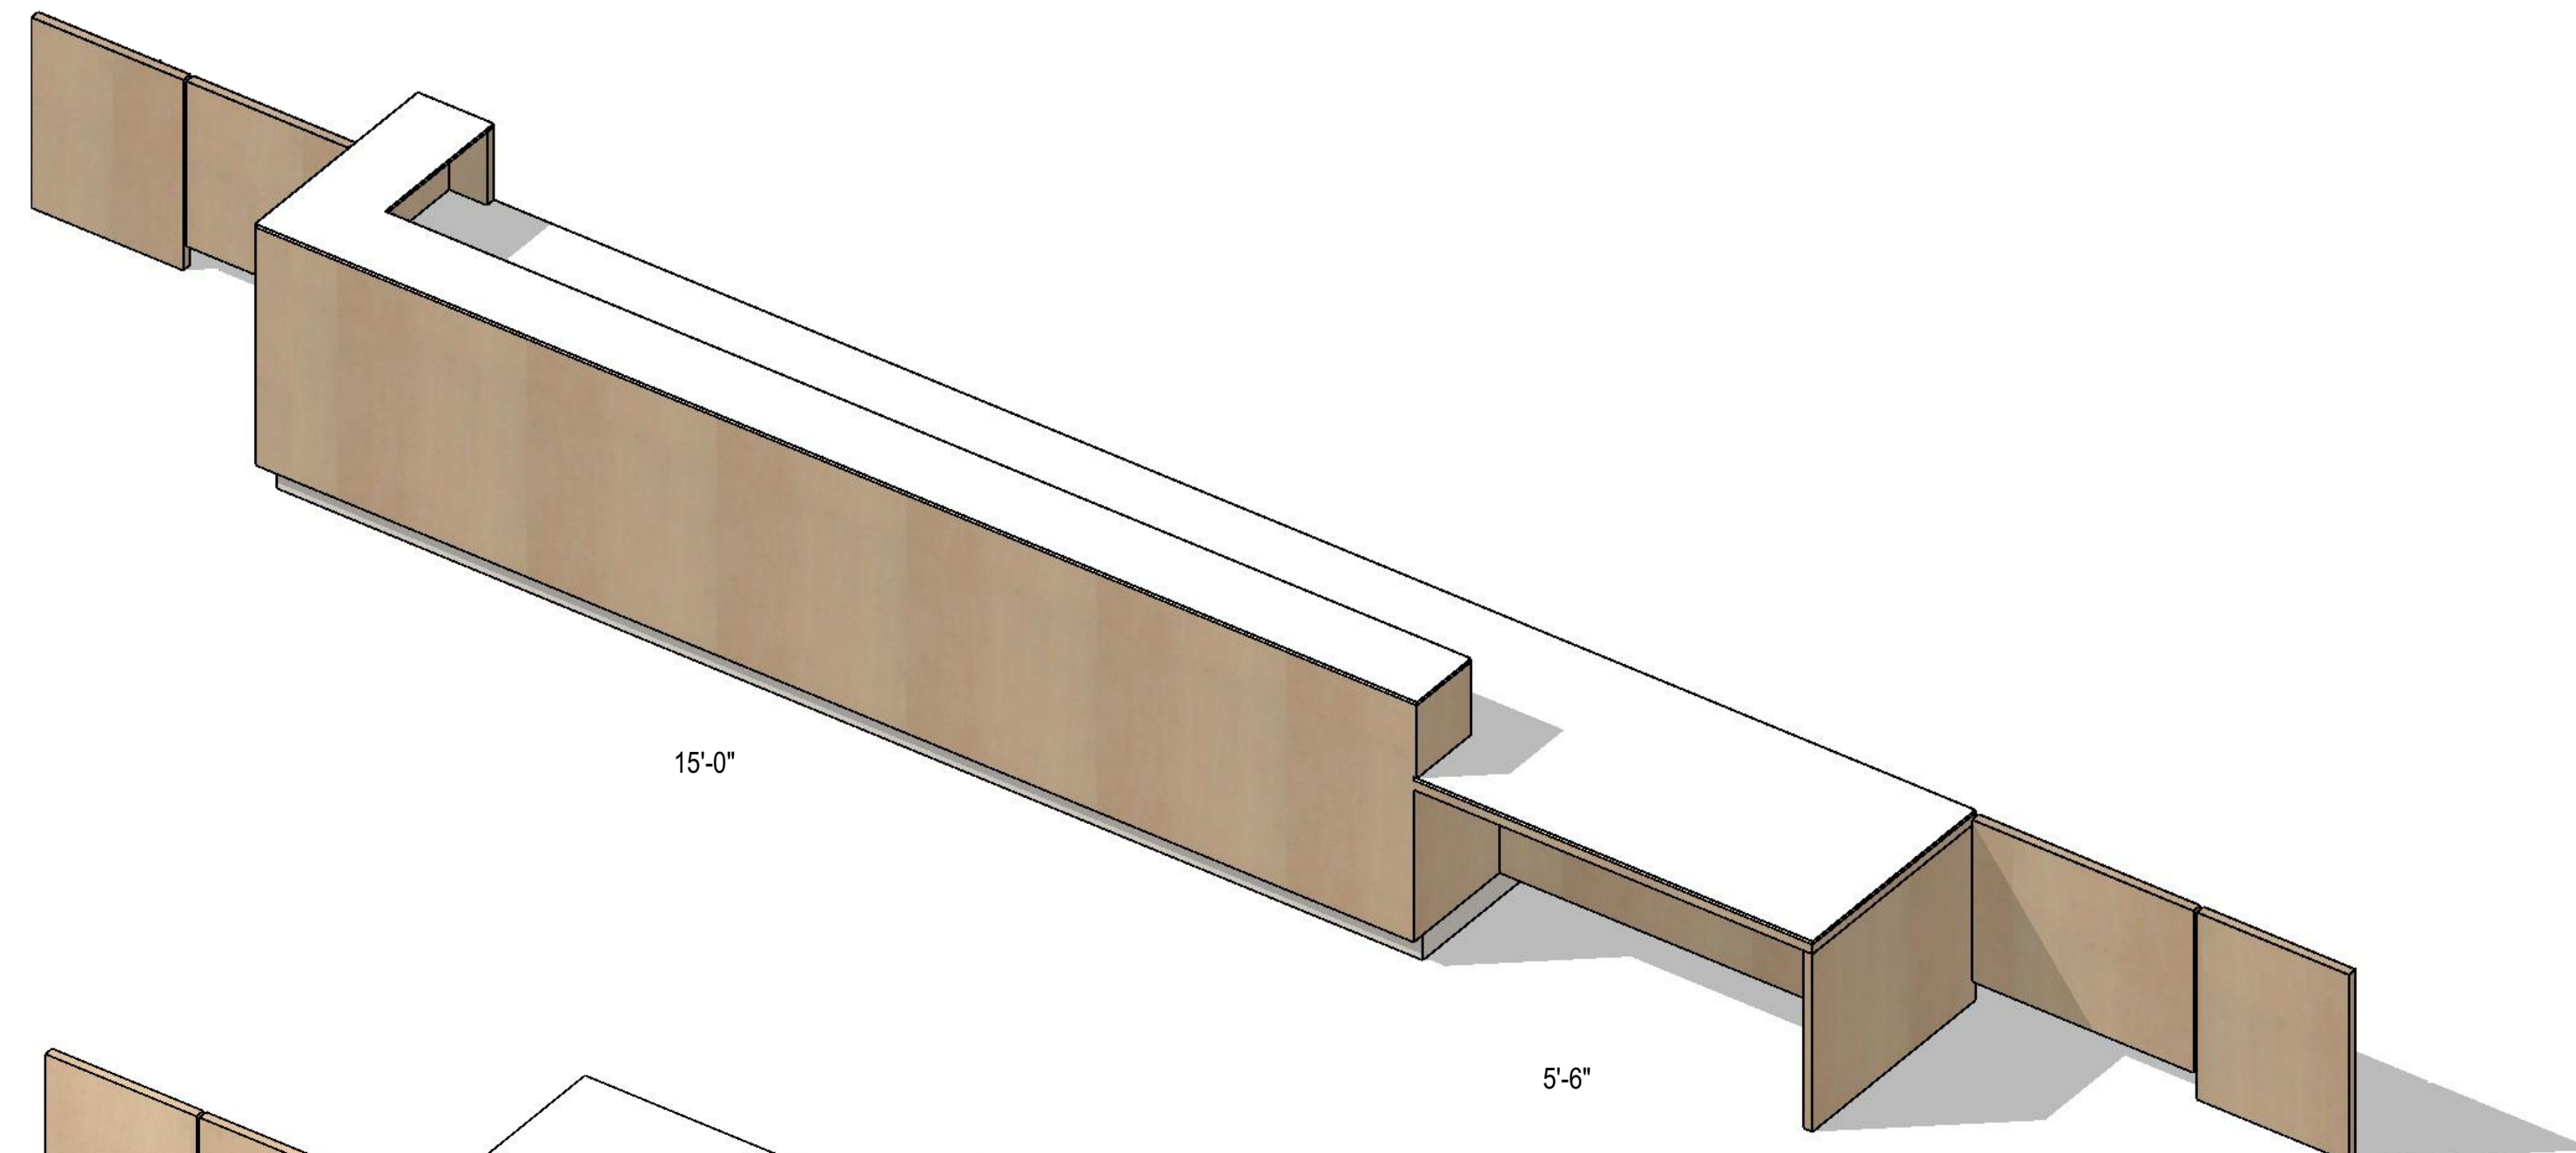- COUNTERTOP** • SOLID SURFACE TOP W/ PROTRUDING BULLNOSE FRONT EDGE  
• SOLID SURFACE SPLASH 4" HIGH
- BASE CABINETS** • ONE 18" WIDE x 24" DEEP x 33" HIGH CABINET  
• ONE 24" WIDE x 24" DEEP x 33" HIGH CABINET  
• 6" HIGH TOP DRAWER + 2 EQ. DRAWERS BELOW  
• 18" WIDE x 24" DEEP ACCESSIBLE CABINET W/ UNDERMOUNT SINK  
• 6" HIGH FIXED PANEL AT FACE TO ALIGN W/ 6" HIGH DRAWER  
• PROVIDE ACCESSIBLE KNEE + TOE CLEARANCE AREA AT SINK  
• PROVIDE INSULATED EXPOSED PIPING  
• 1 1/2" THICK FINISHED PLYWOOD WATERFALL EDGE + INTERMEDIATE SUPPORTS
- BASE / KICK** • 4" HIGH PLYWOOD KICK SET BACK 3" FROM FACE OF CABINET
- WALL CABINETS** • TWO 36" WIDE x 14" DEEP x 14" HIGH WALL CABINETS  
• BASE OF CABINET +24" TO COUNTERTOP SURFACE  
• REFER TO ELEC. FOR UNDERCABINET LIGHTING
- EQUIPMENT** • PROVIDE ONE 24" WIDE DISHWASHER  
• PROVIDE ONE 24" WIDE UNDERCOUNTER REFRIGERATOR W/ GLASS DOOR  
• COORDINATE REQUIREMENTS FOR: TOASTER OVEN AND INDUSTRIAL EXPRESSO MACHINE



#### 2 RECEPTION DESK 1ST FLOOR

- COUNTERTOP** • SOLID SURFACE TOP W/ PROTRUDING BULLNOSE FRONT EDGE  
• HIGH LOW COUNTER CONFIGURATION  
• HIGH COUNTER AT 41" A.F.F. x 12" DEEP W/ POWER AND DATA BELOW OVERHANG  
• LOW COUNTER AT 29" A.F.F. x 36" DEEP
- BASE CABINETS** • 1 1/2" THICK FINISHED PLYWOOD COUNTERTOP SUBSTRUCTURE  
• PLYWOOD SINISH INTERMEDIATE SUPPORT AS NEEDED  
• TWO 36" WIDE x 24" DEEP x 25" HIGH BASE CABINETS  
• THREE DRAWERS, ONE LATERAL FILE DRAWER  
• 1 1/2" THICK FINISHED PLYWOOD MODESTY PANEL AT ACCESSIBLE COUNTERTOP  
• 1 1/2" THICK FINISHED PLYWOOD WATERFALL EDGE
- BASE / KICK** • 4" HIGH PLYWOOD KICK SET BACK 3" FROM FACE OF CABINET
- SWING GATES** • 1 1/2" THICK FINISHED PLYWOOD SWING GATRES WITH CONCEALED HINGES  
• 1 1/2" THICK FINISHED PLYWOOD FIXED SIDELIGHT PANEL

#### GENERAL NOTES

- PLYWOOD STAIN COLORS NOT SHOWN. REFER TO A600 FOR STAIN COLORS. FINAL COLOR SELECTION FOR EACH CABINET SHALL BE BY OWNERS REPRESENTATIVE.
- PROVIDE HARDWARE NOT SHOW.



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NO. DATE REVISION

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PMA PROJECT NO.  
23007

DRAWING TITLE

CASEWORK 3D  
VIEWS AND NOTES  
FIRST FLOOR

SCALE

DATE  
02/28/2024

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SHEET NO.

A501



GENERAL NOTES

1. PLYWOOD STAIN COLORS NOT SHOWN. REFER TO A600 FOR STAIN COLORS. FINAL COLOR SELECTION FOR EACH CABINET SHALL BE BY OWNERS REPRESENTATIVE.

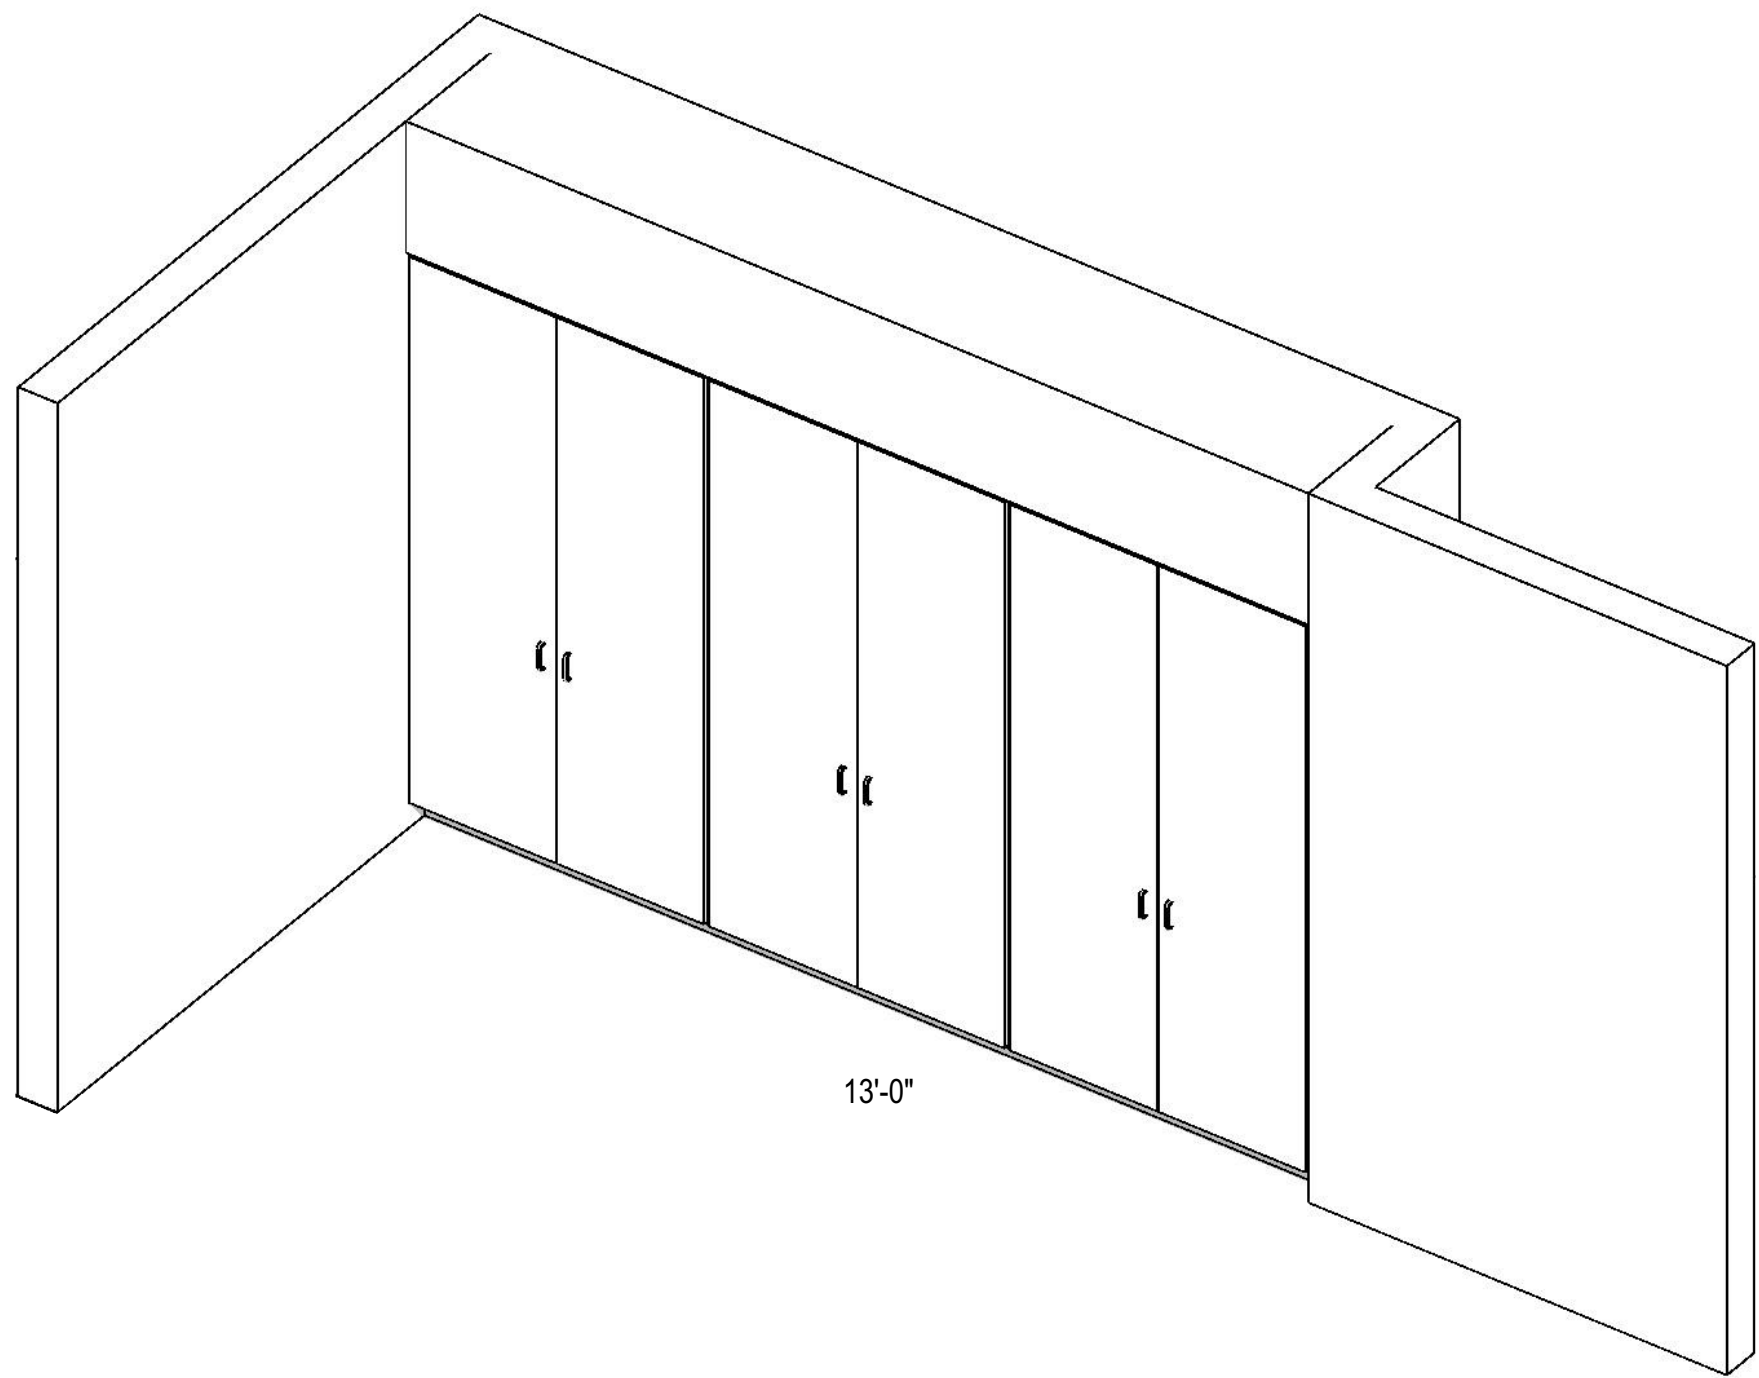
2. PROVIDE HARDWARE NOT SHOW.



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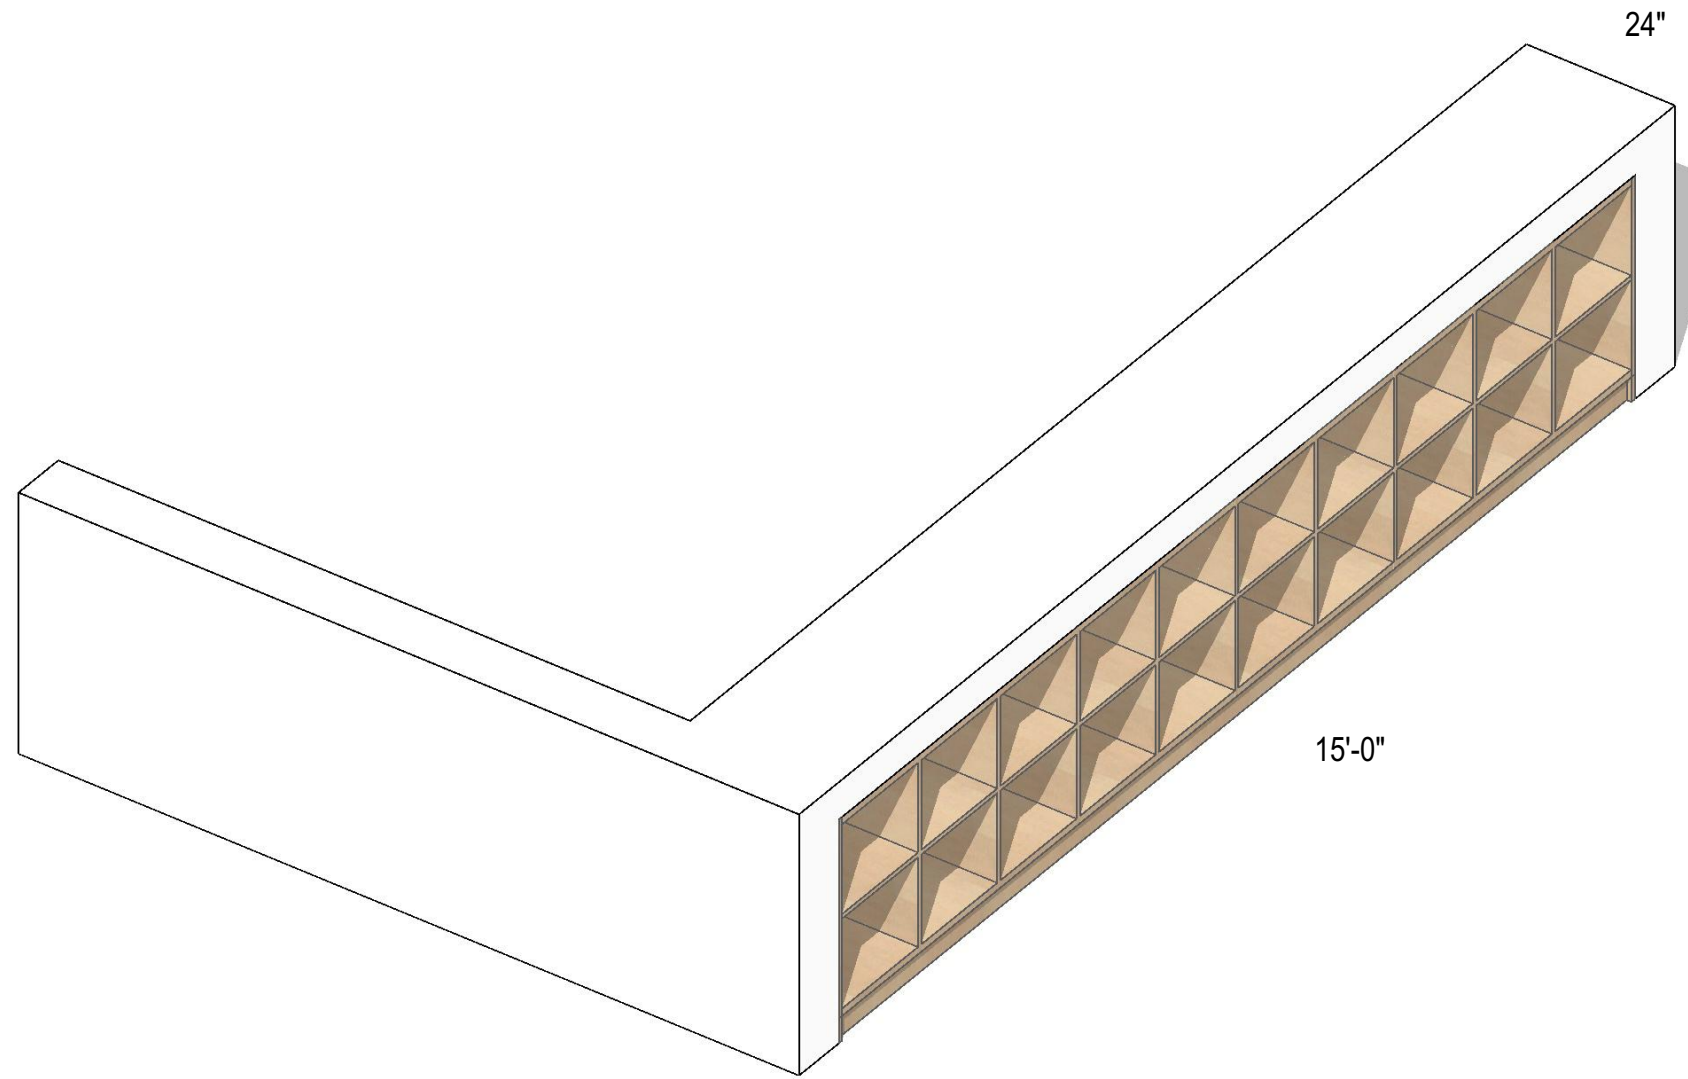
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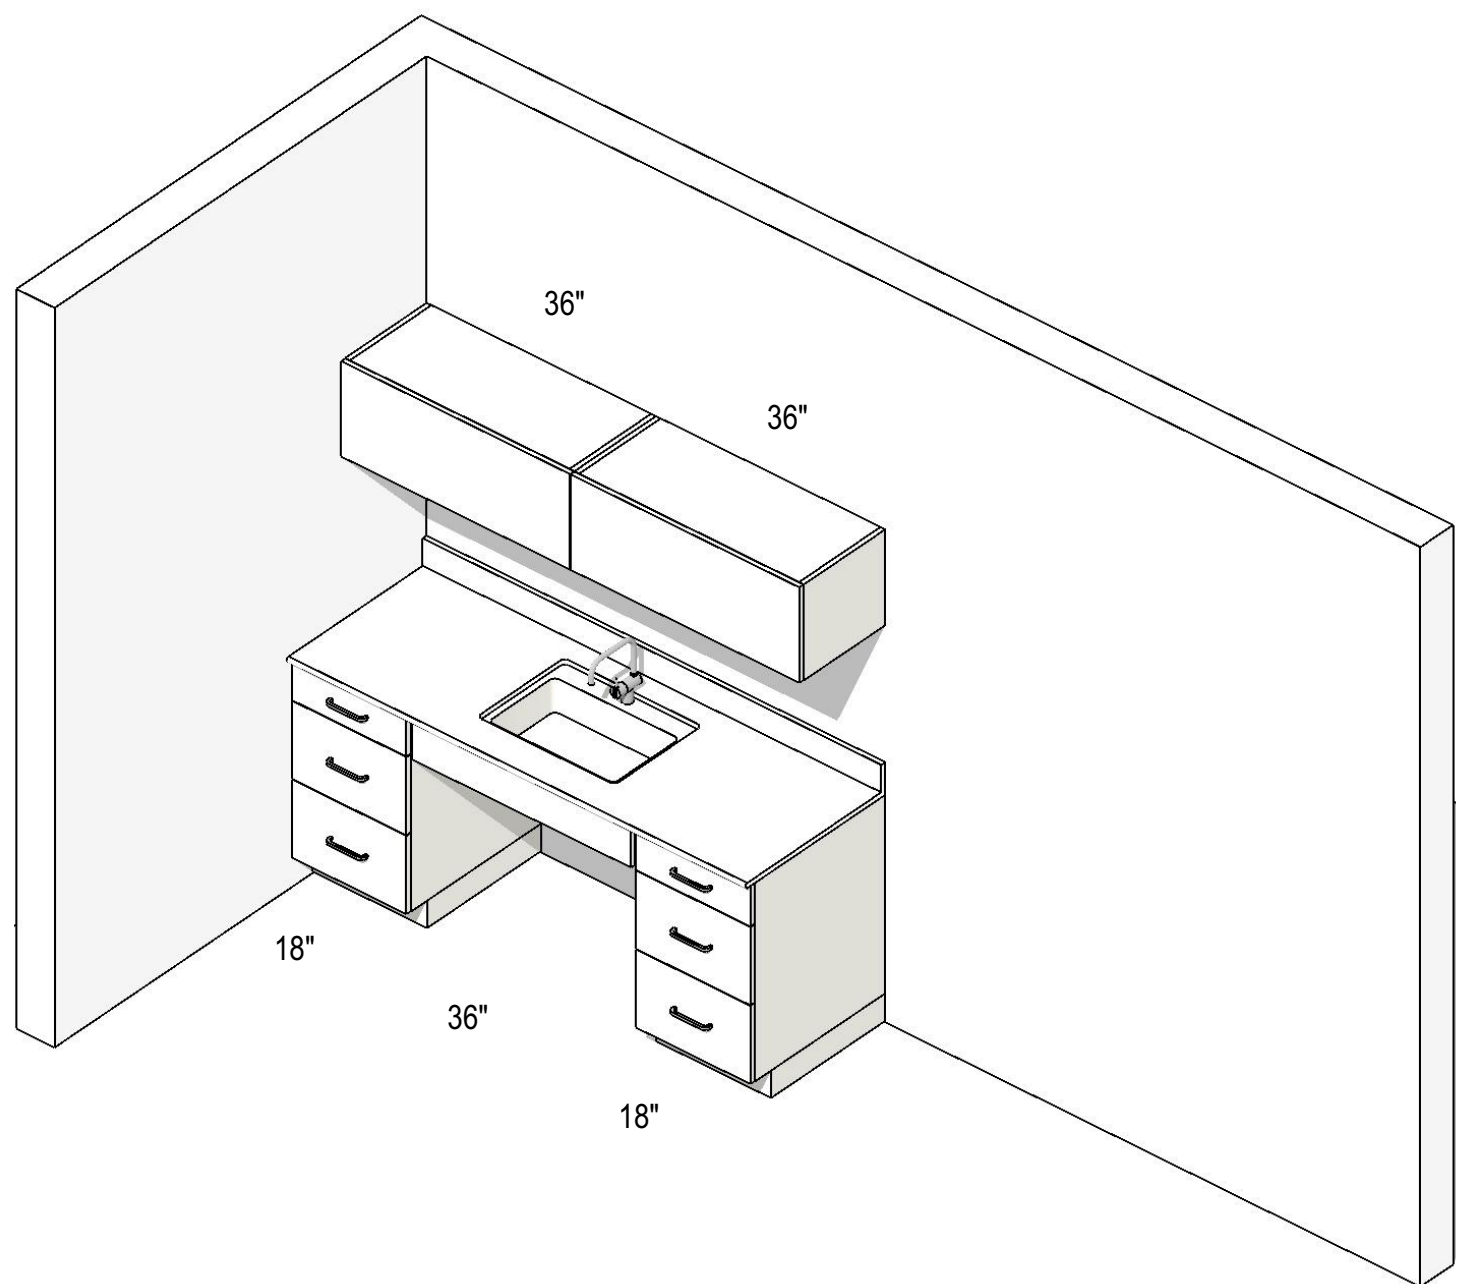
### 3 SNACK STATION PANTRY

- CABINETS**
- THREE 46" WIDE x 18" DEEP x 7'-0" HIGH CABINETS
  - 6 ADJUSTABLE SHELVES
  - STAINED PLYWOOD DOORS - FACE OF DOORS FLUSH WITH ADJACENT WALL SURFACE
- BASE / KICK**
- 4" HIGH STAINED PLYWOOD KICK SET BACK 3" FROM FACE OF CABINET





### 1 STORAGE CUBBIES AT STAIR NO. 1 GUARDRAIL

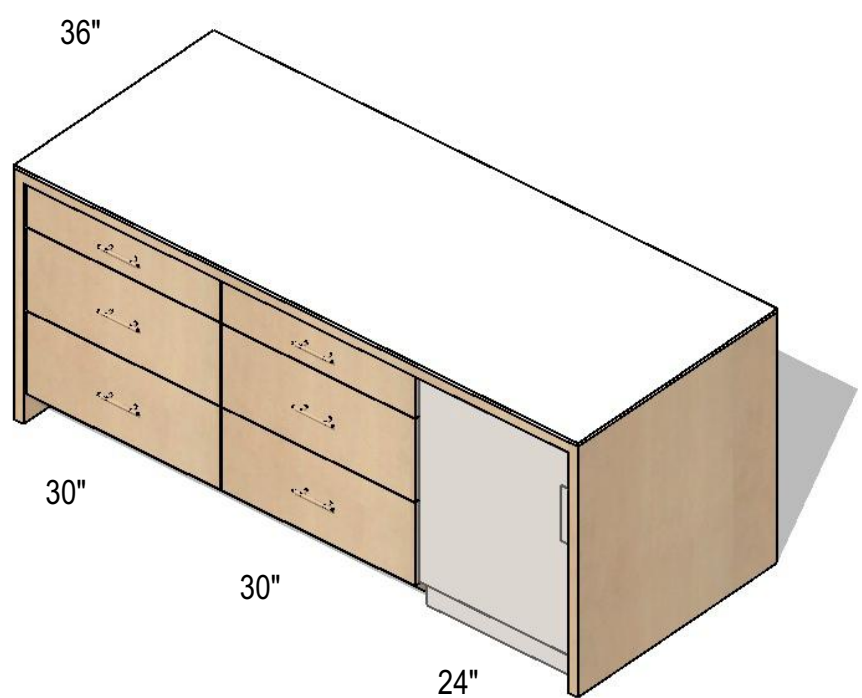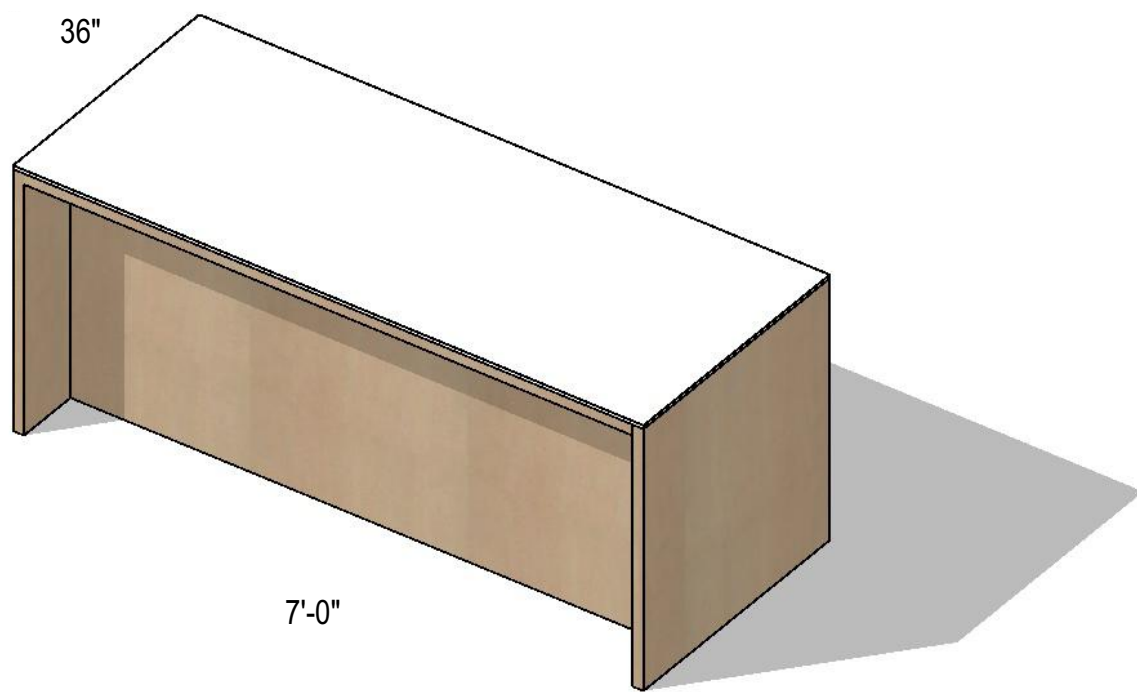- COUNTERTOP**
- SOLID SURFACE TOP OVER 42" H. LOW GUARDRAIL WALL
- BASE CABINETS**
- 20 CUBBIES DOUBLE STACKED OPENINGS W/ 3/4" PLYWOOD DIVIDERS
- BASE / KICK**
- 4" HIGH PLYWOOD KICK SET BACK 3" FROM FACE OF CABINET





### 5 EXAM ROOM HEALTHCARE CASEWORK

- COUNTERTOP**
- SOLID SURFACE TOP W/ PROTRUDING BULLNOSE FRONT EDGE
  - SOLID SURFACE SPLASH 4" HIGH
- BASE CABINETS**
- TWO 18" WIDE x 24" DEEP x 33" HIGH CABINETS EITHER SIDE OF SINK
  - 6" HIGH TOP DRAWER + 2 EQ. DRAWERS BELOW
  - 18" WIDE x 24" DEEP ACCESSIBLE CABINET W/ UNDERMOUNT SINK
  - 6" HIGH FIXED PANEL AT FACE TO ALIGN W/ 6" HIGH DRAWER
  - PROVIDE ACCESSIBLE KNEE + TOE CLEARANCE AREA AT SINK
  - PROVIDE INSULATED EXPOSED PIPING
- BASE / KICK**
- 4" HIGH KICK SET BACK 3" FROM FACE OF CABINET
- WALL CABINETS**
- TWO 36" WIDE x 14" DEEP x 14" HIGH WALL CABINETS
  - BASE OF CABINET +24" TO COUNTERTOP SURFACE
  - REFER TO ELEC. FOR UNDERCABINET LIGHTING



### 4 SNACK STATION ISLAND

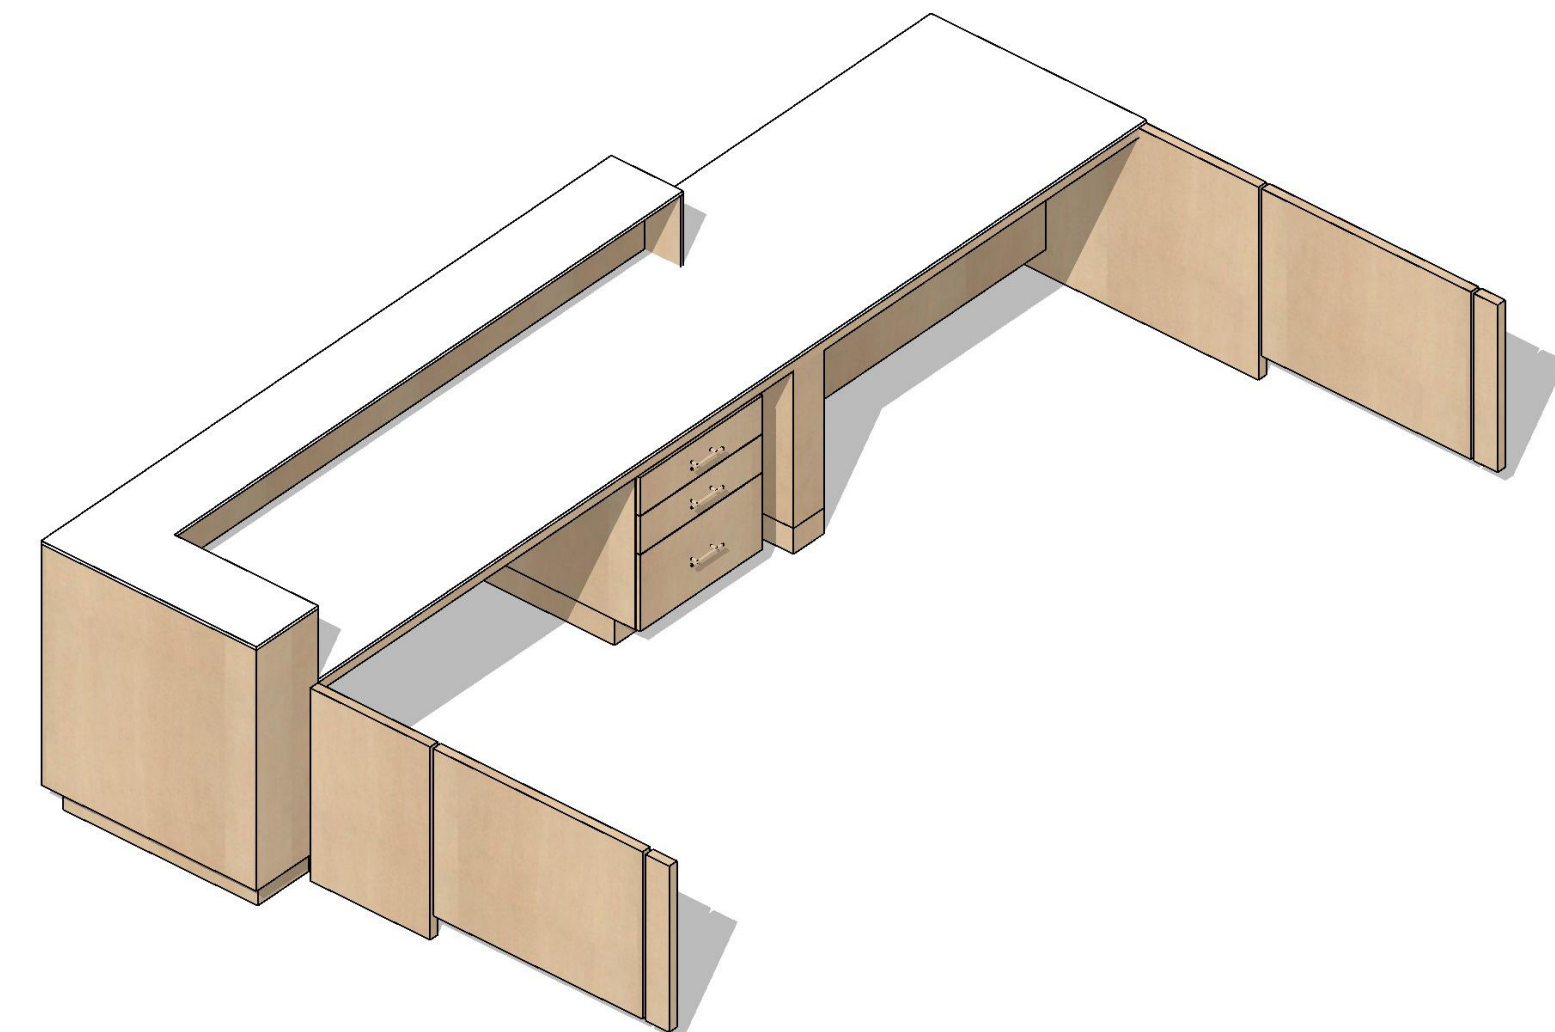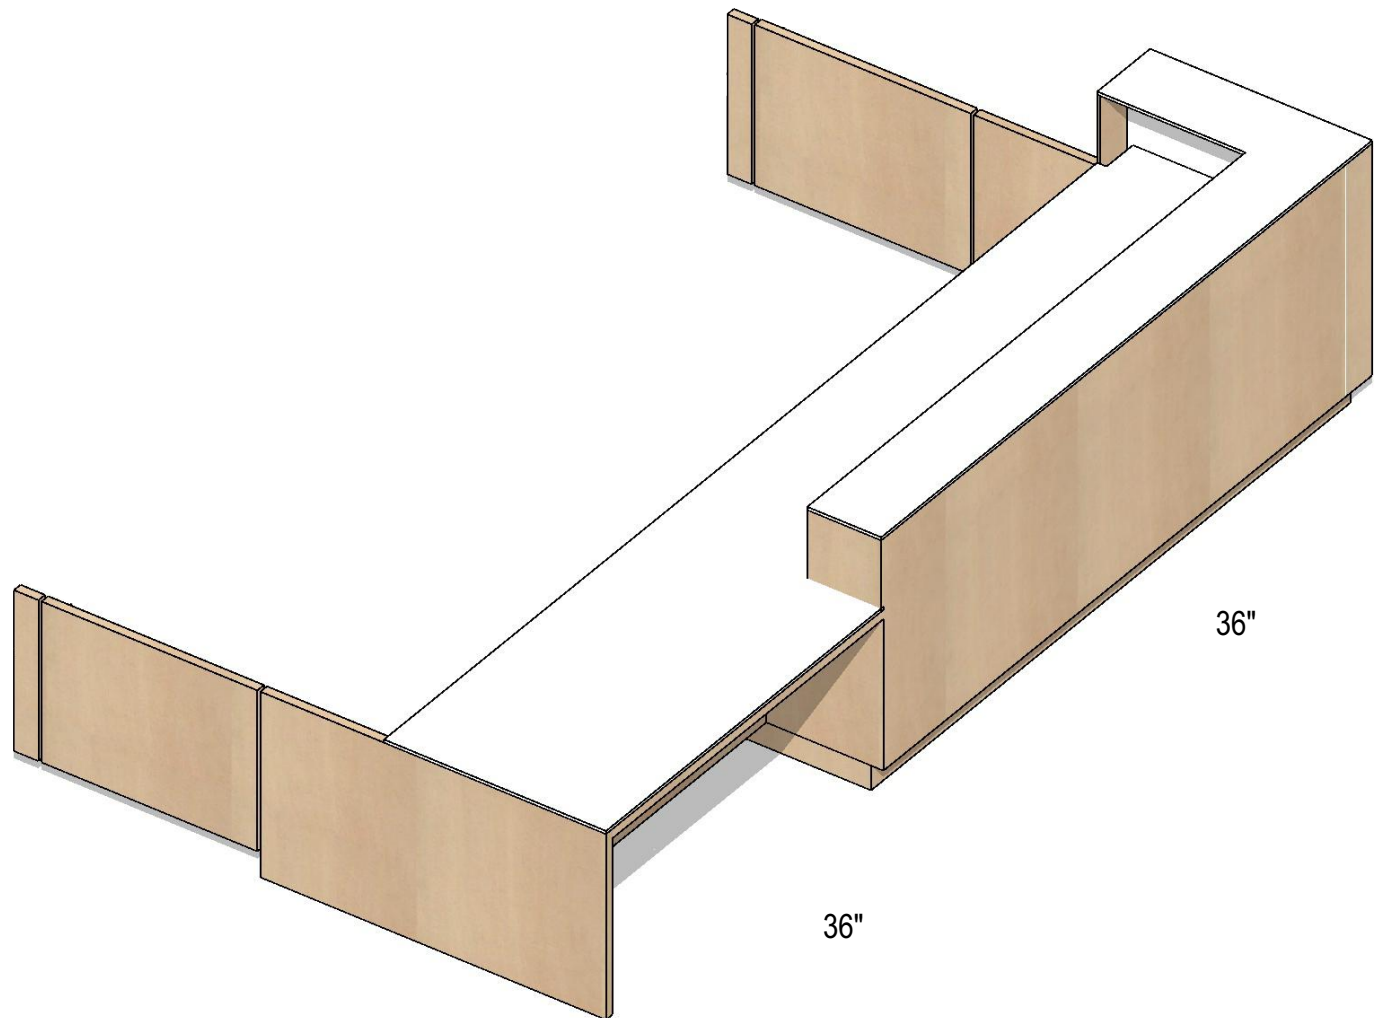- COUNTERTOP**
- SOLID SURFACE TOP W/ PROTRUDING BULLNOSE EDGE
- BASE CABINETS**
- TWO 24" WIDE x 24" DEEP x 33" HIGH CABINET
  - 6" HIGH TOP DRAWER + 2 EQ. DRAWERS BELOW
  - 1 1/2" THICK FINISHED PLYWOOD WATERFALL EDGE AT ENDS
- BASE / KICK**
- 4" HIGH PLYWOOD KICK SET BACK 3" FROM FACE OF CABINET
- EQUIPMENT**
- PROVIDE ONE 24" WIDE UNDERCOUNTER REFRIGERATOR W/ GLASS DOOR
  - COORDINATE REQUIREMENTS FOR CHARGING STATION
  - COORDINATE REQUIREMENTS FOR: KEURIG MACHINE



### 2 RECEPTION DESK 2ND FLOOR

- COUNTERTOP**
- SOLID SURFACE TOP W/ PROTRUDING BULLNOSE FRONT EDGE
  - HIGH LOW COUNTER CONFIGURATION
  - HIGH COUNTER AT 41" A.F.F. x 12" DEEP W/ POWER AND DATA BELOW OVERHANG
  - LOW COUNTER AT 29" A.F.F. x 36" DEEP
- BASE CABINETS**
- 1 1/2" THICK FINISHED PLYWOOD COUNTERTOP SUBSTRUCTURE
  - PLYWOOD SINISH INTERMEDIATE SUPPORT AS NEEDED
  - ONE 36" WIDE x 24" DEEP x 25" HIGH BASE CABINETS
  - THREE DRAWERS, ONE LATERAL FILE DRAWER
  - 1 1/2" THICK FINISHED PLYWOOD MODESTY PANEL AT ACCESSIBLE COUNTERTOP
  - 1 1/2" THICK FINISHED PLYWOOD WATERFALL EDGE
- BASE / KICK**
- 4" HIGH PLYWOOD KICK SET BACK 3" FROM FACE OF CABINET
- SWING GATES**
- 1 1/2" THICK FINISHED PLYWOOD SWING GATRES WITH CONCEALED HINGES
  - 1 1/2" THICK FINISHED PLYWOOD FIXED SIDELIGHT PANEL

NO. DATE REVISION

**allcove**  
BEACH CITIES  
HEALTH DISTRICT

100% PRELIMINARY  
DESIGN SUBMITTAL

PMA PROJECT NO.  
23007

DRAWING TITLE  
CASEWORK 3D  
VIEWS AND NOTES  
SECOND FLOOR

SCALE

DATE  
02/28/2024

DRAWN  
E.C.

CHECKED  
P.M.

SHEET NO.  
A502



WINDOW SCHEDULE

DOOR #	ROOM NAME	DOOR					NOTES
		MATERIAL	FINISH	GLASS	WIDTH	HEIGHT	
W100	WORK ROOM	AL	MP	GL-1	7'-9"	9'-0"	2
W101	WORK ROOM	AL	MP	GL-1	13'-0"	9'-0"	2
W102	WORK ROOM	AL	MP	GL-1	7'-9"	9'-0"	2
W103	STAIR NO. 2	AL	MP	GL-1	3'-0"	9'-0"	
W104	OFFICE	AL	MP	GL-1	3'-0"	9'-0"	1
W105	BREAKROOM	AL	MP	GL-1	3'-0"	9'-0"	1
W106	CAFE	AL	MP	GL-1	8'-9"	9'-0"	1
W201	STAIR NO. 2	AL	MP	GL-1	3'-0"	13'-0"	
W202	SENSORY ROOM	AL	MP	GL-1	8'-8"	5'-6"	1
W203	THE COVE	AL	MP	GL-1	5'-6"	5'-6"	2
W204	GROUP ROOM	AL	MP	GL-1	31'-3"	5'-6"	1
W205	CHAT ROOM	AL	MP	GL-1	54'-5"	5'-6"	1
W206	PRIVACY ROOM	AL	MP	GL-1	27'-0"	5'-6"	1

NOTES:

- OPERABLE CASEMENT WINDOW(S)
- OPERABLE TRANSOM WINDOW(S)

MATERIAL LEGEND

<b>DOOR CONSTRUCTION</b>	
HM	HOLLOW METAL
AL	ALUMINUM
SC	SOLID CORE WOOD
<b>FACING AND FINISH</b>	
AP	FACTORY FINISH
MP	METAL, PAINTED
PL	PLASTIC LAMINATE
<b>FRAME CONSTRUCTION</b>	
AL	ALUMINUM
HM	HOLLOW METAL
<b>GLASS</b>	
GL-1	1" INSULATED TEMPERED GLASS
GL-2	5/16" TEMPERED LAMINATED GLASS

DOOR SCHEDULE

DOOR #	ROOM NAME	DOOR						FRAME		NOTES
		MATERIAL	FINISH	WIDTH	HEIGHT	THICKNESS	GLASS	MATERIAL	FINISH	
D100	INTAKE	AL	MP	5'-11 1/2"	8'-10"	1 3/4"	GL-1	AL	MP	
D102	CAFE	AL	MP	3'-0"	8'-10"	1 3/4"	GL-1	AL	MP	
D103A	LARGE GROUP ROOM	AL	MP	3'-0"	8'-10"	1 3/4"	GL-1	AL	MP	
D103B	LARGE GROUP ROOM	AL	MP	3'-0"	8'-10"	1 3/4"	GL-1	AL	MP	
D103C	LARGE GROUP ROOM	AL	MP	19'-0"	8'-10"	1 3/4"	GL-1	AL	MP	
D103D	LARGE GROUP ROOM	SC	PL	3'-0"	8'-10"	1 3/4"	GL-1	HM	MP	
D103E	LARGE GROUP ROOM	SC	PL	3'-0"	8'-10"	1 3/4"	GL-1	HM	MP	
D104	STAIR NO. 1	AL	MP	3'-0"	8'-10"	1 3/4"	GL-1	AL	MP	
D106A	RECEPTION DESK	SC	PL	3'-0"	8'-10"	1 3/4"	GL-2	HM	MP	
D106B	RECEPTION DESK	SC	PL	3'-0"	8'-10"	1 3/4"	GL-2	HM	MP	
D106C	STAIR NO. 2	HM	MP	3'-0"	8'-10"	1 3/4"	GL-2	HM	MP	
D108	BREAKROOM	SC	PL	3'-0"	8'-10"	1 3/4"	GL-2	HM	MP	
D109	OFFICE	SC	PL	3'-0"	8'-10"	1 3/4"	GL-2	HM	MP	
D110	STORAGE	SC	PL	8'-0"	8'-10"	1 3/4"	-	HM	MP	
D111	WORKSTATIONS	SC	PL	3'-0"	8'-10"	1 3/4"	-	HM	MP	
D112	ELECTRICAL ROOM	HM	MP	3'-6"	8'-10"	1 3/4"	-	HM	MP	
D113	TELECOM ROOM	SC	PL	3'-0"	8'-10"	1 3/4"	-	HM	MP	
D114	FIRE RISER	HM	MP	3'-0"	8'-10"	1 3/4"	-	HM	MP	
D115	MECH ROOM	HM	MP	3'-0"	8'-10"	1 3/4"	-	HM	MP	
D116	STAIR NO. 2	HM	MP	3'-0"	8'-10"	1 3/4"	-	HM	MP	
D117	UNISEX RESTROOM	SC	PL	3'-0"	8'-10"	1 3/4"	-	HM	MP	
D118	UNISEX RESTROOM	SC	PL	3'-0"	8'-10"	1 3/4"	-	HM	MP	
D200A	EXTERIOR TERRACE	AL	MP	3'-0"	8'-10"	1 3/4"	GL-1	AL	MP	
D200B	EXTERIOR TERRACE	AL	MP	3'-0"	8'-10"	1 3/4"	GL-1	AL	MP	
D201A	EXTERIOR TERRACE	AL	MP	8'-0"	8'-10"	1 3/4"	GL-1	AL	MP	
D201B	EXTERIOR TERRACE	AL	MP	8'-0"	8'-10"	1 3/4"	GL-1	AL	MP	
D201C	EXTERIOR TERRACE	AL	MP	8'-0"	8'-10"	1 3/4"	GL-1	AL	MP	
D204	EXAM ROOM	SC	PL	3'-0"	8'-10"	1 3/4"	-	HM	MP	
D206	GROUP ROOM	SC	PL	3'-0"	8'-10"	1 3/4"	GL-2	HM	MP	
D207	CHAT ROOM	SC	PL	3'-0"	8'-10"	1 3/4"	GL-2	HM	MP	
D208	CHAT ROOM	SC	PL	3'-0"	8'-10"	1 3/4"	GL-2	HM	MP	
D209	CHAT ROOM	SC	PL	3'-0"	8'-10"	1 3/4"	GL-2	HM	MP	
D210	PRIVACY ROOM	SC	PL	3'-0"	8'-10"	1 3/4"	-	HM	MP	
D211	CHAT ROOM	SC	PL	3'-0"	8'-10"	1 3/4"	GL-2	HM	MP	
D212	CHAT ROOM	SC	PL	3'-0"	9'-0"	1 3/4"	GL-2	HM	MP	
D213	CHAT ROOM	SC	PL	3'-0"	8'-10"	1 3/4"	GL-2	HM	MP	
D214	GROUP ROOM	SC	PL	3'-0"	8'-10"	1 3/4"	GL-2	HM	MP	
D215	CLEAN ROOM	SC	PL	3'-0"	8'-10"	1 3/4"	-	HM	MP	
D216	SOLID ROOM	SC	PL	3'-0"	8'-0"	1 3/4"	-	HM	MP	
D217	STORAGE	SC	PL	3'-0"	8'-0"	1 3/4"	-	HM	MP	
D218	JANITOR ROOM	SC	PL	3'-0"	8'-0"	1 3/4"	-	HM	MP	
D219	UNISEX RESTROOM	HM	MP	3'-0"	8'-0"	1 3/4"	-	HM	MP	
D220	UNISEX RESTROOM	HM	MP	3'-0"	8'-0"	1 3/4"	-	HM	MP	
D221	THE COVE	SC	PL	3'-0"	8'-10"	1 3/4"	-	HM	MP	
D222	STAIR NO. 2	SC	PL	3'-0"	8'-0"	1 3/4"	GL-2	HM	MP	

GENERAL NOTES

- ALL AL. FRAMES, LOUVERS, H.M. FRAMES + DOORS TO BE PAINTED TO MATCH ADJACENT WALL COLOR U.N.O.
- PAINTED FRAMES + LOUVERS TO BE EGGSHELL PAINT FINISH.
- PROVIDE AL. SCREENS AT ALL OPERABLE WINDOWS.
- PROVIDE CODE REQUIRED ACCESSORIES AT ALL RESTROOMS.
- SUBMIT SAMPLES AND/OR MOCKUPS FOR FINAL COLOR SELECTIONS BY OWNER'S REPRESENTATIVE, TYP.

COLOR LEGEND

WOOD STAIN COLORS

MINWAX WATER-BASED SOLID STAIN  
C1 MW 1010 HONEYDEW  
C2 MW1098 NATURAL PEACH  
C3 MW 1167 WOODROSE  
C4 MW1225 BLUE HAWAII  
C5 MW1168 WISTERIA

HEALTH CARE CASEWORK (EXAM ROOM)

FORMICA PLASTIC LAMINATE  
1196 PURPLE DYE

SOLID SURFACE COLORS

CORIAN  
CAMEO WHITE

RUBBER STAIR TREAD FINISH COLOR

MOHAWK COLORWAYS  
COLOR: MERRIGOLD 241

COLUMN COVERS

PAC-CLAD  
WHITE, MATTE

WOOD DOORS PLASTIC LAMINATE

WHITE TO MATCH ADJACENT WALL

CURTAINWALL FRAMES

BONE WHITE - KYNAR  
CUSTOM COLOR TO MATCH C5 SHINGLE

GYPSUM BOARD - PAINT

SW 7005 PURE WHITE - SHERWIN WILLIAMS

CEMENT PLASTER - PAINT

SW 7005 PURE WHITE - SHERWIN WILLIAMS  
CUSTOM COLOR TO MATCH C5 SHINGLE

FELT WALL COVERING

SELECTIONS PER OWNER'S REP.  
FILZFELT

MATERIAL LEGEND

FLOOR MATERIAL

FG FOOT GRILL  
LVT LUXURY VINYL TILE  
CPT CARPET TILE  
CONC CONCRETE SEALED  
SDT STATIC DISSIPATIVE COATING ON CONC.  
QT QUARRY TILE, UNGLAZED, SEALED  
PP PEDESTAL PAVERS  
RFF RUBBER FLOOR FINISH

BASE MATERIAL

RB RUBBER BASE  
QTB QUARRY TILE COVE BASE

WALL FINISH

GB PTD. GYPSUM BOARD  
WP ACOUSTICAL WALL PANEL  
PW FIRE-RETARDANT TREATED PLYWOOD

CEILING MATERIAL

GB PTD. GYPSUM BOARD  
ACT ACOUSTICAL CEILING TILES  
AT ACOUSTICAL TILE - DIRECT MOUNT

PAINT FINISH CODE LIST

PAINT

P1.1 WHITE - SEMI GLOSS  
P1.2 WHITE - EGG SHELL  
P2.1 CEILING WHITE - SEMI GLOSS  
P2.2 CEILING WHITE - EGG SHELL  
P3.1 MATCH SHINGLE C5 - EGGSHELL

FINISH SCHEDULE

NO.	ROOM NAME	FLOOR		WALL FINISH				CEILING		NOTES
		MATERIAL	BASE	NORTH	SOUTH	EAST	WEST	MATERIAL	HEIGHT	
A100	INTAKE	FG	RB	-	-	GB (P1.1)	GB (P1.1)	GB (P2.1)	9'-0"	
A101	LOBBY + RECEPTION	LVT	RB	-	GB (P1.1) + WP	-	-	GB (P2.1) + AT	9'-0"	
A102	LARGE GROUP ROOM	LVT	RB	GB (P1.1) + WP	GB (P1.1)	GB (P1.1)	GB (P1.1) + WP	GB (P2.1) + AT	9'-0"	
A103	CAFE	LVT	RB	GB (P1.1)	GB (P1.1)	GB (P1.1)	GB (P1.1)	GB (P2.1)	9'-0"	
A104	WORKSTATIONS	LVT	RB	GB (P1.1) + WP	-	-	GB (P1.1)	GB (P2.1)	9'-0"	
A105	RECEPTION DESK	LVT	RB	GB (P1.1) + WP	-	GB (P1.1)	GB (P1.1)	GB (P2.1)	9'-0"	
A106	WORK ROOM	CPT	RB	-	GB (P1.1)	GB (P1.1)	GB (P1.1)	ACT	9'-0"	
A107	PRINT	LVT	RB	-	GB (P1.1)	-	-	ACT	9'-0"	
A108	BREAKROOM	LVT	RB	GB (P1.2)	GB (P1.2)	GB (P1.2)	GB (P1.2)	GB (P2.2)	9'-0"	1+2
A109	OFFICE	CPT	RB	GB (P1.1)	GB (P1.1)	GB (P1.1)	GB (P1.1)	ACT	9'-0"	
A110	STORAGE	LVT	RB	GB (P1.2)	GB (P1.2)	GB (P1.2)	GB (P1.2)	GB (P2.2)	9'-0"	
A111	ELEV. ROOM	CONC	RB	GB (P1.1)	GB (P1.1)	GB (P1.1)	GB (P1.1)	(P2.2)	-	
A112	ELECTRICAL ROOM	CONC	RB	GB (P1.1) + PW	GB (P1.1) + PW	GB (P1.1) + PW	GB (P1.1) + PW	(P2.2)	-	
A113	TELECOM ROOM	SDT	RB	GB (P1.1) + PW	GB (P1.1) + PW	GB (P1.1) + PW	GB (P1.1) + PW	(P2.2)	-	
A114	FIRE RISER	CONC	RB	GB (P1.1)	GB (P1.1)	GB (P1.1)	GB (P1.1)	(P2.2)	-	
A115	MECH ROOM	CONC	RB	GB (P1.1)	GB (P1.1)	GB (P1.1)	GB (P1.1)	(P2.2)	-	
A116	STAIR NO. 1	RFF	RB	GB (P1.1)	GB (P1.1)	GB (P1.1)	GB (P1.1)	GB (P2.1)	9'-0"	
A116	STAIR NO. 1	RFF	RB	GB (P1.1)	GB (P1.1)	GB (P1.1)	GB (P1.1)	GB (P2.1)	9'-0"	
A116	STAIR NO. 2	CONC	RB	GB (P1.1)	GB (P1.1)	GB (P1.1)	GB (P1.1)	GB (P2.1)	9'-0"	
A117	UNISEX RESTROOM	QT	QTB	SSF	SSF	SSF	SSF	GB (P2.2)	9'-0"	
A118	UNISEX RESTROOM	QT	QTB	SSF	SSF	SSF	SSF	GB (P2.2)	9'-0"	
A200	EXTERIOR TERRACE	PP		PL (P3.1)	PL (P3.1)	PL (P3.1)	PL (P3.1)	-	-	
A201	THE COVE	LVT	RB	GB (P1.1)	-	GB (P1.1)	GB (P1.1)	GB (P2.1) + AT	9'-0"	2
A202	RECEPTION	LVT	RB	-	GB (P1.1) + WP	-	-	GB (P2.1)	-	
A203	COMMUNITY WALL	LVT	RB	GB (P1.1)	GB (P1.1)	GB (P1.1)	GB (P1.1)	GB (P2.1)	-	
A204	EXAM ROOM	LVT	RB	GB (P1.2) + WP	GB (P1.2)	GB (P1.2)	GB (P1.2) + WP	GB (P2.2) + AT	9'-0"	
A205	SENSORY ROOM	LVT	RB	GB (P1.1) + WP	GB (P1.1)	GB (P1.1) + WP	GB (P1.1)	GB (P2.1)	9'-0"	
A206	GROUP ROOM	LVT	RB	GB (P1.1) + WP	GB (P1.1)	GB (P1.1)	GB (P1.1) + WP	GB (P2.1) + AT	9'-0"	1
A207	CHAT ROOM	LVT	RB	GB (P1.1) + WP	GB (P1.1)	GB (P1.1)	GB (P1.1) + WP	GB (P2.1) + AT	9'-0"	
A208	CHAT ROOM	LVT	RB	GB (P1.1)	GB (P1.1) + WP	GB (P1.1)	GB (P1.1) + WP	GB (P2.1) + AT	9'-0"	
A209	CHAT ROOM	LVT	RB	GB (P1.1) + WP	GB (P1.1)	GB (P1.1) + WP	GB (P1.1)	GB (P2.1) + AT	9'-0"	
A210	PRIVACY ROOM	LVT	RB	GB (P1.1) + WP	GB (P1.1)	GB (P1.1) + WP	GB (P1.1)	GB (P2.1) + AT	9'-0"	
A211	CHAT ROOM	LVT	RB	GB (P1.1) + WP	GB (P1.1)	GB (P1.1)	GB (P1.1) + WP	GB (P2.1) + AT	9'-0"	
A212	CHAT ROOM	LVT	RB	GB (P1.1)	GB (P1.1) + WP	GB (P1.1) + WP	GB (P1.1)	GB (P2.1) + AT	9'-0"	
A213	CHAT ROOM	LVT	RB	GB (P1.1) + WP	GB (P1.1)	GB (P1.1) + WP	GB (P1.1)	GB (P2.1) + AT	9'-0"	
A214	GROUP ROOM	LVT	RB	GB (P1.1) + WP	GB (P1.1)	GB (P1.1) + WP	GB (P1.1)	GB (P2.1) + AT	9'-0"	1
A215	CLEAN ROOM	LVT	RB	GB (P1.2)	GB (P1.2)	GB (P1.2)	GB (P1.2)	GB (P2.2)	9'-0"	
A216	SOLID ROOM	LVT	RB	GB (P1.2)	GB (P1.2)	GB (P1.2)	GB (P1.2)	GB (P2.2)	9'-0"	
A217	STORAGE	LVT	RB	GB (P1.2)	GB (P1.2)	GB (P1.2)	GB (P1.2)	GB (P2.2)	9'-0"	
A218	JANITOR ROOM	CONC	QTB	GB (P1.2)	GB (P1.2)	GB (P1.2)	GB (P1.2)	GB (P2.2)	9'-0"	
A219	UNISEX RESTROOM	QT	QTB	SSF	SSF	SSF	SSF	GB (P2.2)	9'-0"	
A220	UNISEX RESTROOM	QT	QTB	SSF	SSF	SSF	SSF	GB (P2.2)	9'-0"	
A222	STAIR NO. 2	CONC.	RB	GB (P1.1)	GB (P1.1)	GB (P1.1)	GB (P1.1)	GB (P2.1)	9'-0"	

NOTES:

- PROVIDE WALL-MOUNTED MARKERBOARD
- PROVIDE WALL-MOUNTED TACK BOARD



PAUL MURDOCH  
ARCHITECTS

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LOS ANGELES, CA 90048  
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THE DRAWINGS AND SPECIFICATIONS AND IDEAS, DESIGNS, AND ARRANGEMENTS REPRESENTED THEREBY ARE AND SHALL REMAIN THE PROPERTY OF THE ARCHITECT, AND NO PART THEREOF SHALL BE COPIED, DISCLOSED TO OTHERS, OR USED IN CONNECTION WITH ANY WORK OR PROJECT OTHER THAN THE SPECIFIC PROJECT FOR WHICH THEY HAVE BEEN PREPARED AND DEVELOPED WITHOUT THE WRITTEN CONSENT OF THE ARCHITECT. USUAL CONTACT WITH THESE DRAWINGS OR SPECIFICATIONS SHALL CONSTITUTE CONCLUSIVE EVIDENCE OF ACCEPTANCE OF THESE RESTRICTIONS. WRITTEN DIMENSIONS ON THESE DRAWINGS SHALL HAVE PRECEDENCE OVER SCALED DIMENSIONS. CONTRACTORS SHALL VERIFY AND BE RESPONSIBLE FOR ALL DIMENSIONS AND CONDITIONS ON THE JOB AND THIS OFFICE MUST BE NOTIFIED OF ANY VARIATIONS FROM THE DIMENSIONS AND CONDITIONS SHOWN BY THESE DRAWINGS. SHOP DETAILS MUST BE SUBMITTED TO THIS OFFICE FOR REVIEW BEFORE PROCEEDING WITH FABRICATION.



GENERAL NOTES

COMMON

1. FURNISH ALL LABOR, MATERIALS, SERVICES, EQUIPMENT AND APPLIANCES REQUIRED FOR THE RENOVATION OF EXISTING MECHANICAL SYSTEMS INCLUDING HVAC SYSTEMS, PLUMBING, AND MISCELLANEOUS SYSTEMS AS INDICATED.
2. COMPLY WITH THE FOLLOWING CODES:
- A. 2022 CALIFORNIA BUILDING CODE (CBC)
  - B. 2022 CALIFORNIA PLUMBING CODE (CPC)
  - C. 2022 CALIFORNIA MECHANICAL CODE (CMC)
  - D. 2022 CALIFORNIA ELECTRICAL CODE (CEC)
  - E. 2022 CALIFORNIA BUILDING ENERGY EFFICIENCY STANDARDS (DEC)
  - F. ALL OTHER APPLICABLE STATE AND LOCAL CODES APPLYING TO THE PROPOSED CONSTRUCTION.
3. ITEMS MARKED (N) OR SHOWN DARK ARE NEW. ITEMS MARKED (E) OR SHOWN LIGHT ARE EXISTING TO REMAIN. DIAGONALLY HATCHED ITEMS INDICATE EXISTING ITEMS TO BE DEMOLISHED. PROVIDE ALL SAFETY DEVICES, SUPPORTS, MISCELLANEOUS STEEL, WELDING, FLASHING, ETC. AND PROVISIONS AS NECESSARY.
4. ALL MATERIALS SHALL BE FABRICATED AND INSTALLED IN A NEAT AND WORKMAN LIKE MANNER WITH THE COORDINATION OF ALL INVOLVED TRADES.
5. "OR EQUAL" MEANS EQUIVALENT OR SUPERIOR IN PERFORMANCE, MATERIALS, WORKMANSHIP AND APPEARANCE TO THOSE SPECIFIED.
6. PROVIDE ALL REQUIRED SUBMITTALS FOR REVIEW.
7. INSTALLING CONTRACTOR SHALL OBTAIN AND PAY FOR ALL PERMITS AND LICENSES REQUIRED BY ANY GOVERNING AUTHORITY OR LOCAL MUNICIPALITY FOR HIS PORTION OF THE WORK.
8. PROVIDE ACCESS DOORS FOR DAMPERS, VALVES, ETC. WHERE WALLS OR CEILINGS MUST BE PENETRATED TO ACCESS MECHANICAL EQUIPMENT.
9. THESE DRAWINGS ARE DIAGRAMMATIC AND INDICATE THE GENERAL ARRANGEMENT OF COMPONENTS AND THEIR RELATED CONNECTIONS. PATHWAY PLACEMENT IS ONLY REPRESENTATIVE OF A GENERAL LOCATION UNLESS INDICATED OTHERWISE BY DIMENSIONS. SYMBOLS ARE USED EXTENSIVELY WHICH MAY NOT EXACTLY REPRESENT ACTUAL SIZES. THE DRAWINGS DO NOT SHOW ALL OFFSETS, TRANSITIONS AND DEVICES NECESSARY FOR A COMPLETE AND FUNCTIONAL SYSTEM AS REQUIRED BY THE CONTRACT DOCUMENTS. IT IS THE RESPONSIBILITY OF THE CONTRACTOR TO PLACE THESE COMPONENTS SUCH THAT THEY OFFER FULL FUNCTIONALITY WITHOUT INTERFERENCE FROM HVAC, PLUMBING, ELECTRICAL AND OTHER BUILDING SYSTEMS.
10. ALL DIMENSIONS ARE INSIDE NET FREE AREA.
11. COORDINATE ALL CONSTRUCTION ACTIVITIES WITH OWNER PRIOR BEGINNING WORK. GIVE OWNER SUFFICIENT NOTICE OF INTERRUPTIONS AND DURATION OF ACTIVITIES OR SHUTDOWNS. ALL SHUTDOWNS SHALL BE AT THE CONVENIENCE OF THE OWNER AND SHALL NOT RESULT IN CONSTRUCTION DELAYS OR ADDITIONAL COSTS TO THE OWNER. PROVIDE ALL OVERTIME OR AFTERHOURS WORK AS REQUIRED.
12. EXAMINE ALL EXISTING CONDITIONS RELATED TO THE INSTALLATION OF NEW AND RENOVATED SYSTEMS INCLUDING, BUT NOT LIMITED TO, ACCESS REQUIREMENTS, UTILITY SERVICE CONNECTIONS, CONSTRUCTION MATERIALS, HAZARDS, CODE VIOLATIONS, SCHEDULING OF WORK, OR ANY CONDITION THAT AFFECTS EITHER THE CONSTRUCTION SCHEDULE OR COST. THE OWNER SHALL NOT BE RESPONSIBLE FOR ADDITIONAL COSTS ARISING FROM CONDITIONS WHICH ARE OBSERVABLE OR COULD BE REASONABLY EXPECTED BUT WHICH MAY NOT BE SPECIFICALLY MENTIONED.
13. INSTALLING CONTRACTOR TO SURVEY SITE AND STUDY COMPLETE ARCHITECTURAL PLANS PRIOR TO SUBMITTING BID. CONTRACTOR SHALL BE RESPONSIBLE TO GENERATE SHOP DRAWING DETAILS OMITTED ON PLANS WHICH MAY BE REQUIRED IN THE FIELD.
14. AIR BALANCE, INCLUDING OUTSIDE AIR, SHALL BE PERFORMED BY A CERTIFIED NEBB OR AABC AIR BALANCE PROFESSIONAL TO THE SPECIFICATIONS STATED ON THE PLANS. A COPY OF THE CERTIFIED REPORT SHALL BE PRESENTED TO THE BUILDING INSPECTOR PRIOR TO THE FINAL APPROVAL.

EQUIPMENT

1. MANUFACTURER SERVICE CLEARANCE FOR ALL EQUIPMENT SHALL BE MAINTAINED. DO NOT LOCATE PLENUM MOUNTED EQUIPMENT ABOVE WALLS. RELOCATE FIRE SPRINKLER PIPING, CONDUIT AND OTHER OBSTRUCTIONS AS NECESSARY TO MAINTAIN SERVICE CLEARANCES. THE REQUIRED SERVICE DISTANCE FROM MECHANICAL EQUIPMENT TO SCREENING, PARAPETS, WALLS, AND OTHER EQUIPMENT SHALL BE A MINIMUM OF 30" ON THE SERVICE SIDE OF THE EQUIPMENT, OR AS REQUIRED BY THE MANUFACTURER'S INSTALLATION INSTRUCTIONS, IF THE INSTRUCTIONS REQUIRE A GREATER CLEARANCE.
2. CLEARANCES AROUND EQUIPMENT SHOWN IN THESE PLANS SHALL BE CONSIDERED DIAGRAMMATIC UNLESS NOTED OTHERWISE. IN THE CASE THAT CLEARANCES INDICATED ON THESE PLANS DO NOT MEET OR EXCEED THE MANUFACTURER'S RECOMMENDATIONS, SUCH INSTANCES SHALL BE BROUGHT TO THE ATTENTION OF THE ENGINEER PRIOR TO INSTALLATION.

AIR DISTRIBUTION

1. DURING CONSTRUCTION, ENDS OF DUCT OPENINGS ARE TO BE SEALED, AND MECHANICAL EQUIPMENT IS TO BE COVERED.
2. FLEXIBLE DUCTWORK SHALL BE ACOUSTICAL, LOW PRESSURE TYPE WITH INTERIOR LINER, METAL HELIX, 1" FIBERGLASS INSULATION, AND COPOLYMER SEAMLESS. OUTSIDE SLEEVE, THE ENTIRE FLEXIBLE DUCT ASSEMBLY SHALL BE LISTED IN ACCORDANCE WITH UL 181 CLASS 1 AIR DUCT MATERIAL. THE MAXIMUM LENGTH OF ANY FLEX DUCT SHALL BE 6'-0".
3. FACTORY MANUFACTURED HVAC DUCTS WILL BE CLASS ONE OR ZERO. ALL DUCTWORK FOR HEATING AND COOLING SYSTEM OR EVAPORATIVE COOLING SYSTEM SHALL BE CONDUCTED THROUGH DUCT SYSTEMS CONSTRUCTED OF METAL AS SET FORTH IN THE SMACNA HVAC DUCT CONSTRUCTION STANDARD - METAL AND FLEXIBLE. FACTORY MADE AIR DUCTS SHALL BE APPROVED FOR USE INTENDED OR SHALL COMPLY WITH THE GOVERNING MECHANICAL CODE.
4. LOW PRESSURE DUCTWORK SHALL BE GALVANIZED STEEL, OR GAUGES CONFORMING TO LATEST EDITION OF SMACNA STANDARDS BASED ON 1" W.G. PRESSURE UNLESS SPECIFICALLY NOTED OTHERWISE ON THE DRAWINGS. THE GALVANIZED DUCT COATING IS TO BE G-90.
5. INSULATION APPLIED TO THE EXTERIOR OF THE DUCTS LOCATED INSIDE THE BUILDING SHALL HAVE A FLAME SPREAD OF NOT MORE THAN 25 AND SMOKE DENSITY NOT EXCEEDING 50 WHEN TESTED AS A COMPOSITE INSTALLATION.
6. ALL INSULATION AND LINING MATERIALS INSTALLED WITHIN DUCTS ARE TO HAVE MOLD, HUMIDITY AND EROSION SURFACE. MATERIALS SHALL HAVE A MOLD, HUMIDITY AND EROSION RESISTANT FACE THAT MEETS THE REQUIREMENTS OF UL 181.
7. PROVIDE R-8 DUCT INSULATION, 1.5" THICK FIBERGLASS WITH VAPOR BARRIER, AND DUCT SEALING WITH FIELD VERIFICATION IS REQUIRED FOR DUCTS IN UNCONDITIONED SPACES IN NEW BUILDINGS. DUCT SEALING IS ALSO REQUIRED IN EXISTING BUILDINGS WHEN THE AIR CONDITIONER IS REPLACED.
8. PROVIDE ACOUSTICAL BOOTS ON TRANSFER OPENINGS PASSING THROUGH ACOUSTIC PARTITIONS.
9. DIFFUSERS, GRILLES, AND REGISTER INSTALLATION SHALL BE COORDINATED WITH OTHER TRADES.
10. APPROXIMATE DIFFUSER THROAT SIZE IS INDICATED ON THE PLANS. FACE SIZE SHALL BE IN ACCORDANCE WITH THE FRAME REQUIREMENTS. ALL DIFFUSERS LAY-IN CEILINGS SHALL BE EQUAL TO THE GRID SPACING (TYPICALLY 24" X 24"). DIFFUSERS IN HARD CEILINGS SHALL BE THROAT SIZE PLUS 2" (TYPICAL).
11. PROVIDE A BALANCING DAMPER AT EVERY SUPPLY AND RETURN BRANCH CONNECTION TO EACH INDIVIDUAL DIFFUSER OR GRILLE IN ENVIRONMENTAL SUPPLY, RETURN, AND EXHAUST DUCTS. THE DAMPER SHALL BE LOCATED AT THE TAP FROM THE MAIN TRUNK DUCT. FOR SIMPLICITY, THESE DAMPERS ARE NOT SHOWN ON THE PLANS. OPPOSED BLADE DAMPERS AT THE DIFFUSER THROAT SHALL NOT BE RELIED UPON AS THE SOLE MEANS OF BALANCING AND SHALL NOT BE ACCEPTED IN LIEU OF A BRANCH DAMPER. INSTALL DAMPER, OR PROVIDE REMOTE ACTUATORS IN AN ACCESSIBLE LOCATION. PROVIDE ACCESS DOORS IN HARD CEILINGS.
12. ALL DIFFUSERS ARE FOUR-WAY THROW, UNLESS OTHERWISE NOTED.
13. RETURN GRILLES TO MATCH SUPPLY DIFFUSERS, UNLESS OTHERWISE NOTED.
14. FLEX DUCTS SHALL BE ATTACHED TO ALL REGISTERS, GRILLES, COLLARS, AND FITTINGS ACCORDING TO ITS LISTING. PROVIDE A MINIMUM OF TWO WRAPS OF UL 181 TAPE AND A PANDUIT STRAP ON THE INSIDE LINER AND A MINIMUM OF TWO WRAPS OF UL 181 TAPE OR A PANDUIT STRAP, OR BOTH ON THE OUTSIDE COVER.
15. SIZE OF BRANCH DUCT CONNECTION TO DIFFUSER, FLEX, AND TAP, IS EQUAL TO DIFFUSER NECK SIZE UNLESS OTHERWISE NOTED.

(E)

(N)

(RE)

A/C

AHU

A/C

ARCH

ATS

CKT

CO

CTR

CTRTOP

DB

DISC

DN

DWG

E

EM

FC

FD

FLA

FSD

GALV

GFCI

GRD

LCL

LML

LTG

LV

MECH

MTB

MVBC

N

NE

NC

NTS

NW

PB

PNL

REC

S

SC

SD

SE

SW

SW

T/C

TYP

U/G

UNO

UPS

V

VIF

W

WP

XFMR

ABBREVIATIONS

EXISTING

REMOVE

RELOCATED

AIR CONDITIONER

AIR-FAULT CIRCUIT INTERRUPTER

AUTHORITY HAVING JURISDICTION

AMPS IN-RUSH CURRENT

ARCHITECTURAL

AUTOMATIC TRANSFER SWITCH

CIRCUIT

CONDUIT ONLY

CENTER

COUNTERTOP

DISTRIBUTION BOARD

DISCONNECT

DOWN

DRAWING

EAST

EMERGENCY

FLEXIBLE CONNECTION

FIRE DAMPER

FULL LOAD AMPS

FIRE SMOKE DAMPER

GALVANIZED

GROUND FAULT CIRCUIT INTERRUPTER

GROUND

LONG CONTINUOUS LOAD

LARGEST MOTOR LOAD

LIGHTING

LOW-VOLTAGE

MECHANICAL

MAIN TELEPHONE BOARD

MULTI-WIRE BRANCH CIRCUIT

NORTH

NORTHEAST

NOT IN CONTRACT

NOT TO SCALE

NORTHWEST

PULL BOX

PANEL

RECEPTACLE

SOUTH

SEPARATE CIRCUIT

SMOKE DETECTOR

SOUTHEAST

SWITCH

SOUTHWEST

TIME CLOCK

TYPICAL

UNDERGROUND

UNLESS NOTED OTHERWISE

UNINTERRUPTIBLE POWER SOURCE

VOLTS

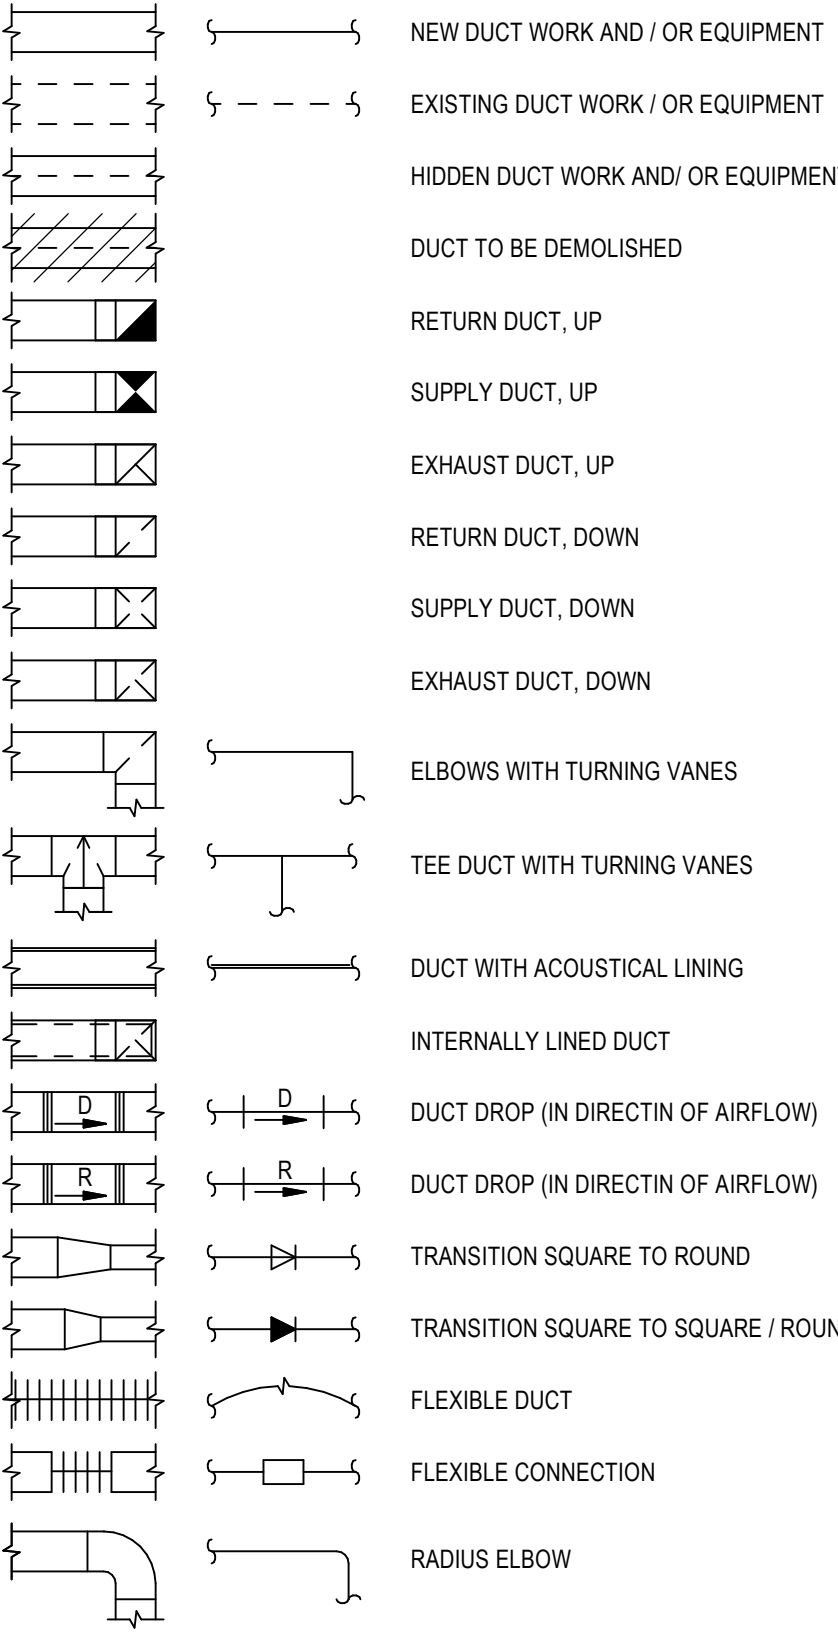
VERIFY IN FIELD

WEST

WATERPROOF

TRANSFORMER

MECHANICAL LEGEND



1 SITE PLAN

1" = 100'-0"

SCOPE OF WORK

HVAC FOR NEW MULTI-PURPOSE CENTER. PACKAGED ROOF TOP UNIT, VRF HEAT PUMPS WITH HEAT RECOVERY, VRF FAN COILS, ROOF EXHAUST, ROOF MAKEUP/ FRESH AIR FANS.

SHEET INDEX - MECHANICAL


SHEET NO. SHEET NAME

M-0.1	MECHANICAL LEAD SHEET
M-0.2	HVAC ZONING SCHEME
M-0.3	SCHEDULES
M-1.0	1ST FLOOR HVAC PLAN
M-1.1	2ND FLOOR HVAC PLAN
M-1.2	ROOF HVAC PLAN

PAUL MURDOCH ARCHITECTS

6310 SAN VICENTE BLVD. SUITE 400  
LOS ANGELES, CA 90048  
T. 310 358-0993

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25061 AVENUE STANFORD, VALENCIA, CA 91355  
PHONE: (818) 886-2190 FAX: (818) 886-2131

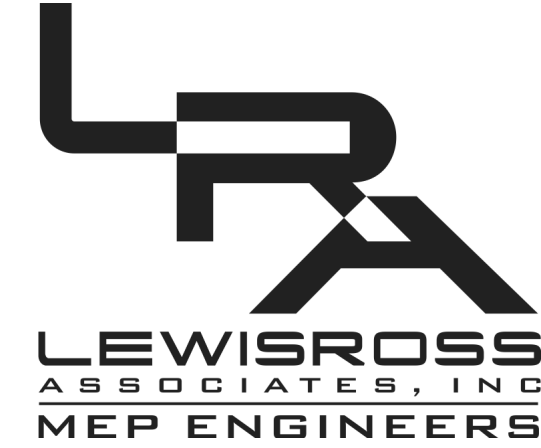PROJECT NAME: 23-115

PROJECT NAME: BCHD allcove

PROJECT ADDRESS: -

REV DESCRIPTION DATE


allcove BEACH CITIES HEALTH DISTRICT

100% PRELIMINARY DESIGN SUBMITTAL

PMA PROJECT NO.: 23007

DRAWING TITLE:

MECHANICAL LEAD SHEET

SCALE: AS SHOWN

DATE: 02/28/2024

DRAWN BY: CHECKED BY:


UK TP

SHEET NO.

M-0.1

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PROJECT NAME: BCHD allcove		
PROJECT ADDRESS: -		
REV	DESCRIPTION	DATE

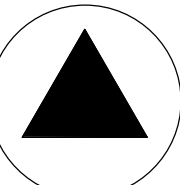allcove  
BEACH CITIES  
HEALTH DISTRICT

100% PRELIMINARY DESIGN SUBMITTAL

PMA PROJECT NO. 23007

DRAWING TITLE:

HVAC ZONING SCHEME

SCALE: AS SHOWN

DATE: 02/28/2024


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M-0.2

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1 HVAC ZONING SCHEME - 1ST FLOOR

3/16" = 1'-0"

2 HVAC ZONING SCHEME - 2ND FLOOR

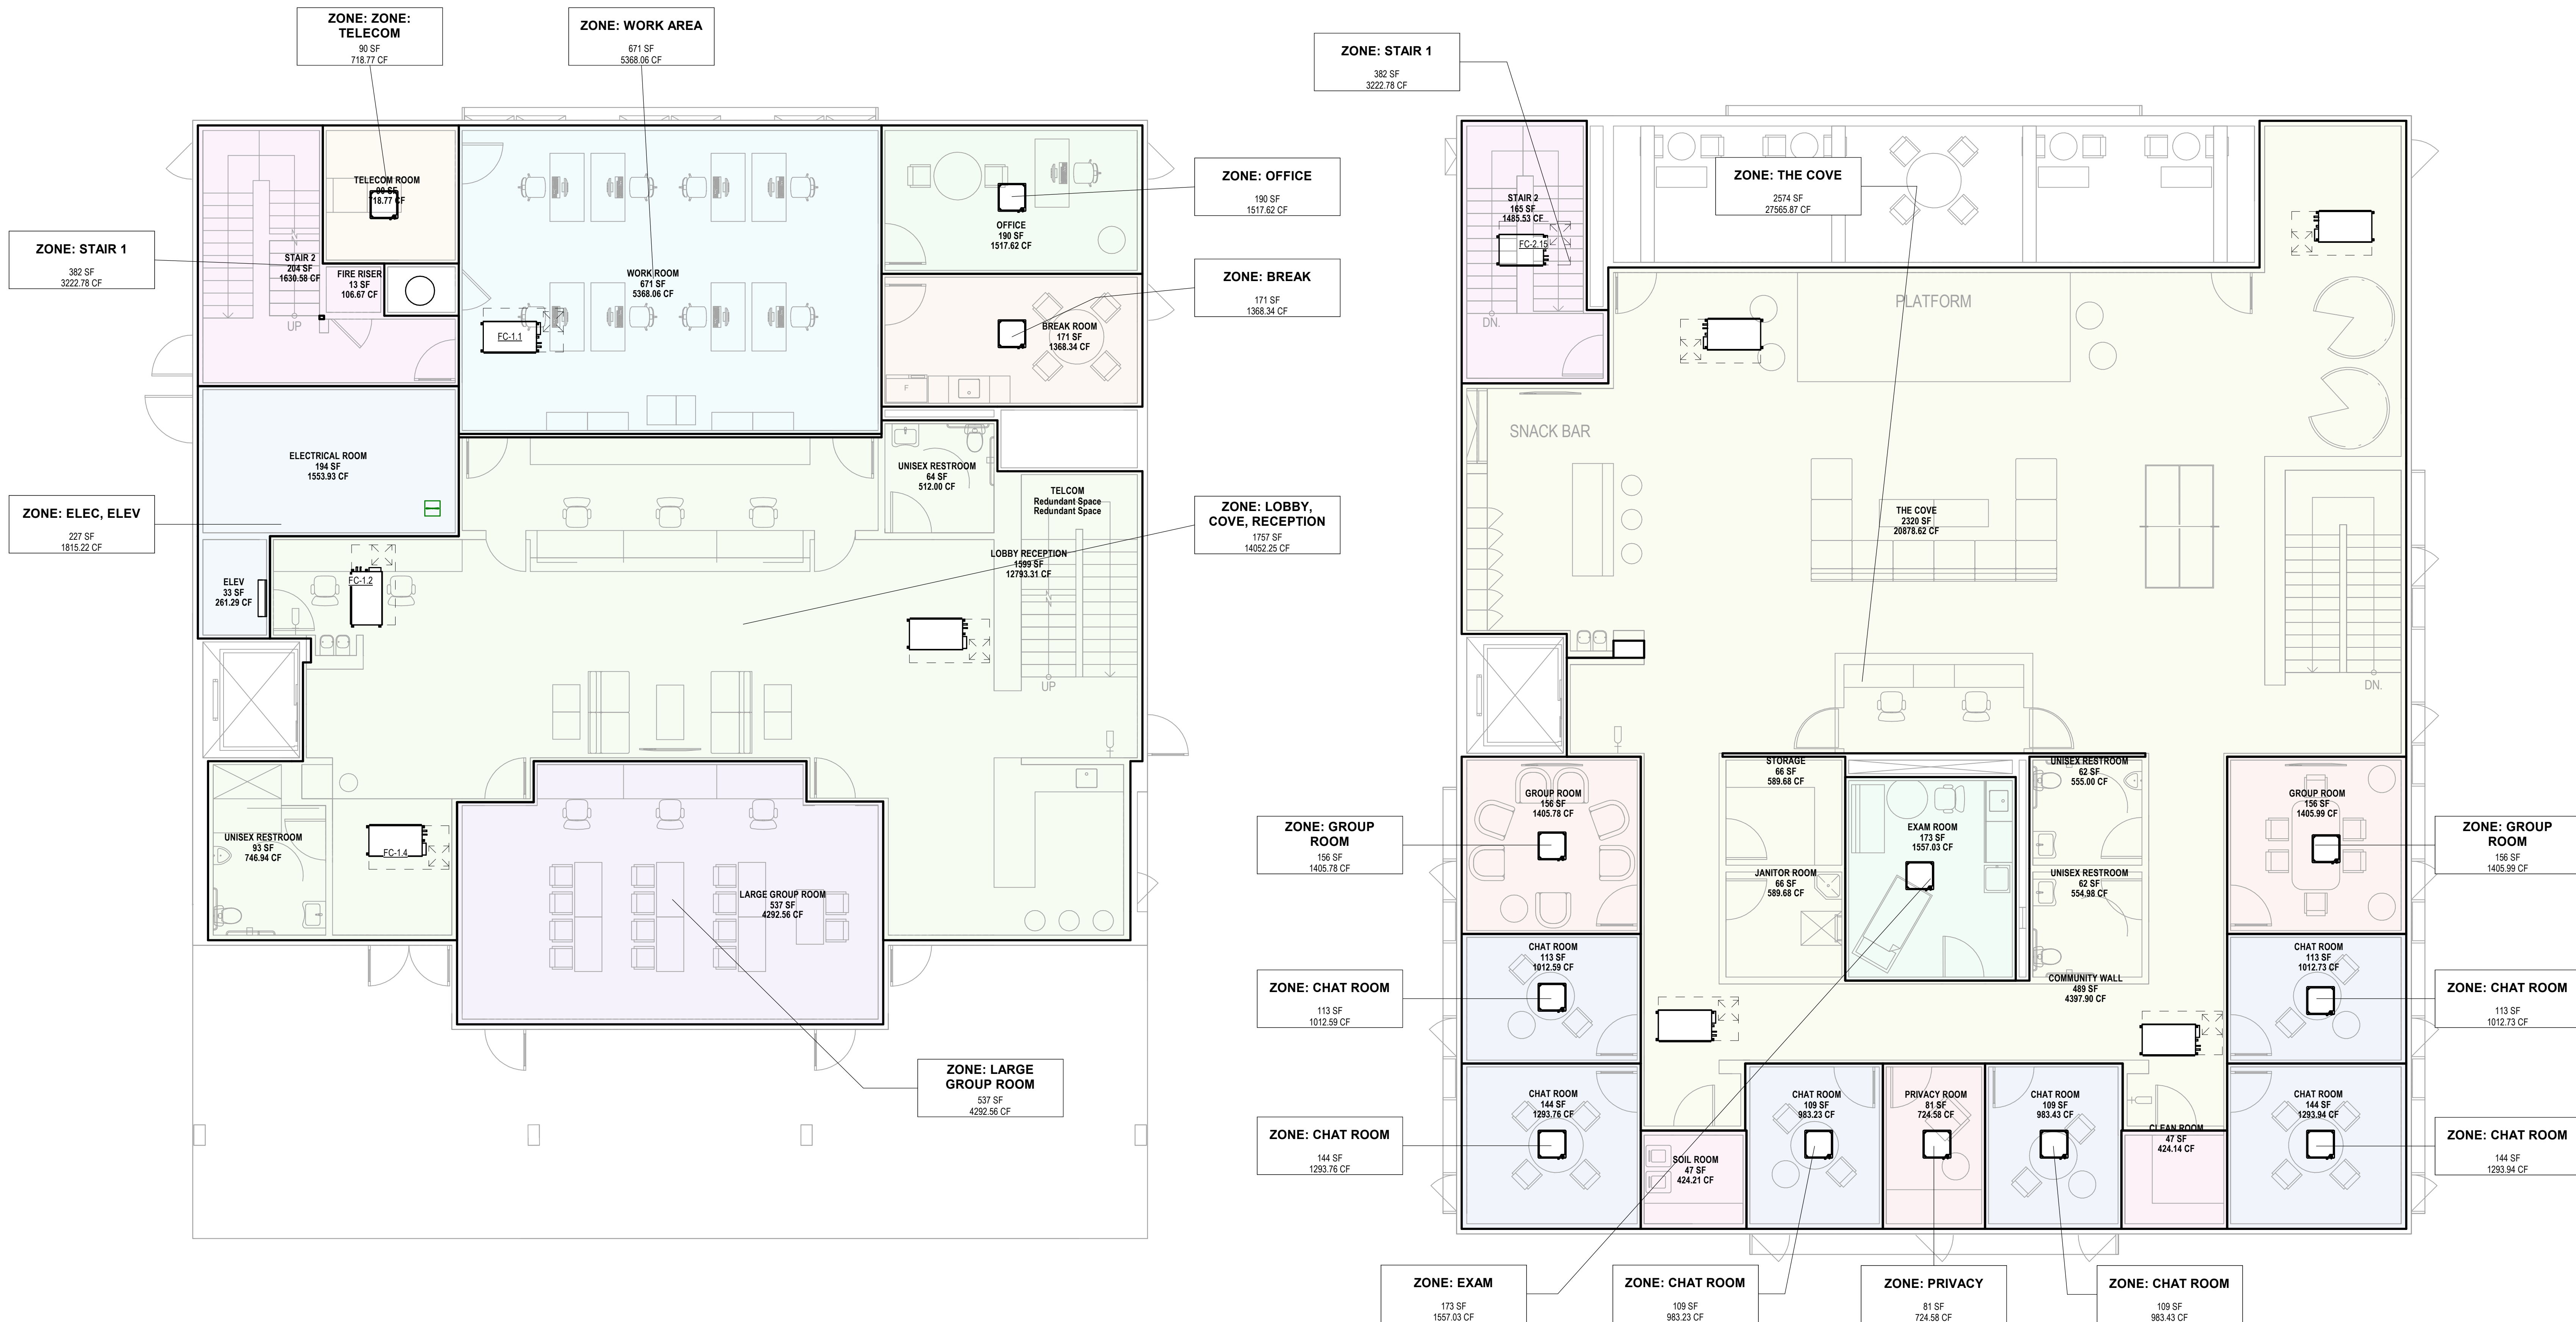3/16" = 1'-0"

- BREAK
- CHAT ROOM
- COVE
- ELEC, ELEV
- EXAM
- GROUP ROOM
- LARGE GROUP ROOM
- LOBBY, COVE, RECEPTION
- OFFICE
- PRIVACY
- STAIR 1
- THE COVE
- WORK AREA
- ZONE: TELECOM

WORKING - HVAC Zone Schedule				
Name	Level	Gross Area	Gross Volume	Comments
Default		607 SF	4857.13 CF	
OFFICE	1ST FLOOR	190 SF	1517.62 CF	
BREAK	1ST FLOOR	171 SF	1383.34 CF	
LOBBY, COVE, RECEPTION	1ST FLOOR	1757 SF	14022.25 CF	DEMAND CONTROL VENTILATION: GOOD CANDIDATE FOR PART-TIME PASSIVE VENTILATION.
EXAM	2ND FLOOR	173 SF	1557.03 CF	
WORK AREA	1ST FLOOR	671 SF	5368.06 CF	
ELEC, ELEV	1ST FLOOR	227 SF	1815.22 CF	AIR CONDITIONING TBD BASED ON EQUIPMENT REQUIREMENTS AND ELEVATOR SPECS
LARGE GROUP ROOM	1ST FLOOR	537 SF	4292.56 CF	DEMAND CONTROL VENTILATION
STAIR 1	2ND FLOOR	382 SF	3222.78 CF	AIR CONDITIONING TBD PENDING CONFIRMATION FROM OWNER. COULD PROVIDE VENTILATION ONLY FOR ENERGY SAVINGS.
THE COVE	2ND FLOOR	2574 SF	27565.87 CF	
GROUP ROOM	2ND FLOOR	156 SF	1405.78 CF	DEMAND CONTROL VENTILATION
CHAT ROOM	2ND FLOOR	113 SF	1012.59 CF	
CHAT ROOM	2ND FLOOR	144 SF	1293.76 CF	
CHAT ROOM	2ND FLOOR	109 SF	983.23 CF	
COVE	2ND FLOOR	94 SF	848.34 CF	
GROUP ROOM	2ND FLOOR	156 SF	1405.99 CF	DEMAND CONTROL VENTILATION
CHAT ROOM	2ND FLOOR	113 SF	1012.73 CF	
CHAT ROOM	2ND FLOOR	144 SF	1293.94 CF	
PRIVACY	2ND FLOOR	81 SF	724.58 CF	
CHAT ROOM	2ND FLOOR	109 SF	983.43 CF	
ZONE: TELECOM	1ST FLOOR	90 SF	718.77 CF	




OUTDOOR UNIT EQUIPMENT SCHEDULE														
TAG	MANUFA.	MODEL	CAPACITY IN TR	SERVES	TOTAL COOLING CAP.Btuh	TOTAL HEATING CAP.Btuh	OUTDOOR TEMP.(IN F.)			MCA	MOCP	VOLTAGE	WEIGHT (LBS)	REMARKS
							COOLING DB	COOLING WB	HEATING DB					
HP-1	LG	ARUM121BTES	10.0	FIRST FLOOR	119,700	135,000	83	68	41	30.9	40	208/230-3-40	550	1,2,3,4,5,6
HP-2	LG	ARUM072BTES	6.0	SECOND FLOOR	72,000	81,000	83	68	41	22.6	35	208/230-1-60	450	1,2,3,4,5,6
HP-3	LG	ARUM08TE5	8.0	SECOND FLOOR	96,000	108,000	83	68	41	28.5	40	208/230-3-40	550	1,2,3,4,5,6
<b>NOTES</b>  1- FOR UNIT PER MANUFACTURER'S RECOMMENDATION AND INSTALLATION MANUAL.  2- PROVIDE REFRIGERANT PIPING LENGTH AS REQUIRED BY MANUFACTURER FOR A COMPLETE AND OPERATINAL SYSTEM  3- EACH INDIVIDUAL MODULE REQUIRES A SEPARATE ELECTRICAL CONNECTION  4- PROVIDE UNIT WITH TWINNING KIT.  5- PROVIDE UNIT WITH BV SERIES BALL VALVES(BRAZED) FOR BRANCH CONTROLLERS BY MANUFACTURER.  6- PROVIDE UNIT WITH BRANCH CONTROLLER.														

VRF FAN COIL UNIT SCHEDULE																
TAG	MATCHING UNIT	MODEL	DESCRIPTION	SERVES	CFM	S.P	TOTAL COOLING CAP.Btuh	TOTAL HEATING CAP.Btuh	MIN. OA CFM	ELECTRICAL				WEIGHT (LBS)	REMARKS	
										MAX.WATTS	MCA	MOCP	VOLTAGE			
FC-1.1	HP-01/BC-1 &2	ARNU183M1A4	CEILING CONCEALED MID STATIC UNIT	FIRST FLOOR	641	0.4	19,100	21,500	96.15		190	1.6	15	208-1-60	75	1,2,3,4,6,7,8
FC-1.2		ARNU363M2A4	CEILING CONCEALED MID STATIC UNIT		1021	0.4	36,200	40,600	153.15		430	2.3	15	208-1-60	95	1,2,3,4,6,7,8
FC-1.3		ARNU363M2A4	CEILING CONCEALED MID STATIC UNIT		1021	0.4	36,200	40,600	153.15		430	2.3	15	208-1-60	95	1,2,3,4,6,7,8
FC-1.4		ARNU183M1A4	CEILING CONCEALED MID STATIC UNIT		641	0.4	19,100	21,500	96.15		190	1.6	15	208-1-60	75	1,2,3,4,6,7,8
FC-1.5		ARNU073D4	CEILING CASSETTE UNIT		247	-	7,500	8,500	-	15	0.4	15	208-1-60	30	1,4,5,6,7	
FC-1.6		ARNU073D4	CEILING CASSETTE UNIT		247	-	7,500	8,500	-	15	0.4	15	208-1-60	30	1,4,5,6,7	
FC-1.7		ARNU073D4	CEILING CASSETTE UNIT		247	-	7,500	8,500	-	15	0.4	15	208-1-60	30	1,4,5,6,7	
FC-1.8		ARNU073JSJ4	WALL MOUNTED FAN COIL UNIT		247	-	7,500	8,500	-	15	0.4	15	208-1-60	20	1,5,6,7	
TOTAL CONNECTED LOAD ON ODU							140,600	158,200								
FC-2.1	HP-02/BC-2	ARNU053D4	CEILING CASSETTE UNIT	SECOND FLOOR	247	-	7,500	8,500	-	15	0.4	15	208-1-60	30	1,4,5,6,7	
FC-2.2		ARNU073D4	CEILING CASSETTE UNIT		247	-	7,500	8,500	-	15	0.4	15	208-1-60	30	1,4,5,6,7	
FC-2.3		ARNU073D4	CEILING CASSETTE UNIT		247	-	7,500	8,500	-	15	0.4	15	208-1-60	30	1,4,5,6,7	
FC-2.4		ARNU053D4	CEILING CASSETTE UNIT		247	-	5,500	6,100	-	15	0.4	15	208-1-60	30	1,4,5,6,7	
FC-2.5		ARNU053D4	CEILING CASSETTE UNIT		247	-	5,500	6,100	-	15	0.4	15	208-1-60	30	1,4,5,6,7	
FC-2.6		ARNU053D4	CEILING CASSETTE UNIT		247	-	5,500	6,100	-	15	0.4	15	208-1-60	30	1,4,5,6,7	
FC-2.7		ARNU073D4	CEILING CASSETTE UNIT		247	-	7,500	8,500	-	15	0.4	15	208-1-60	30	1,4,5,6,7	
FC-2.8		ARNU073D4	CEILING CASSETTE UNIT		247	-	7,500	8,500	-	15	0.4	15	208-1-60	30	1,4,5,6,7	
FC-2.9	HP-03/BC-3	ARNU073D4	CEILING CASSETTE UNIT	SECOND FLOOR	247	-	7,500	8,500	-	15	0.4	15	208-1-60	30	1,4,5,6,7	
FC-2.10		ARNU073D4	CEILING CASSETTE UNIT		247	-	7,500	8,500	-	15	0.4	15	208-1-60	30	1,4,5,6,7	
TOTAL CONNECTED LOAD ON ODU							69,000	77,800								
FC-2.11	HP-03/BC-3	ARNU363M2A4	CEILING CONCEALED MID STATIC UNIT	SECOND FLOOR	1021	0.4	36,200	40,600	153.15		430	2.3	15	208-1-60	95	1,2,3,4,6,7,8
FC-2.12		ARNU363M2A4	CEILING CONCEALED MID STATIC UNIT		1021	0.4	36,200	40,600	153.15		430	2.3	15	208-1-60	95	1,2,3,4,6,7,8
FC-2.13		ARNU183M1A4	CEILING CONCEALED MID STATIC UNIT		641	0.4	19,100	21,500	96.15		190	1.6	15	208-1-60	75	1,2,3,4,6,7,8
FC-2.14		ARNU183M1A4	CEILING CONCEALED MID STATIC UNIT		641	0.4	19,100	21,500	96.15		190	1.6	15	208-1-60	75	1,2,3,4,6,7,8
FC-2.15		ARNU183M1A4	CEILING CONCEALED MID STATIC UNIT		641	0.4	19,100	21,500	96.15		190	1.6	15	208-1-60	75	1,2,3,4,6,7,8
TOTAL CONNECTED LOAD ON ODU							110,600	124,200								
NOTES																
1- INSTALL UNIT PER MANUFACTURERS RECOMMENDATION AND INSTALLATION MANUAL.																
2- PROVIDE UNIT WITH 1"THICK ACOUSTICALLY LINED SUPPLY AND RETURN AIR PLENUMS.																
3- PROVIDE FILTER BOX & MERV-13 FILTER																
4- PROVIDE UNIT WITH A PROGRAMMABLE THERMOSTAT.																
5- PROVIDE UNIT WITH CONDENSATE PUMP IF REQUIRED PER SITE																
6- PROVIDE UNIT WITH BACnet CONTROLLER.																
7- PROVIDE UNIT WITH BRANCH PIPING KIT.																
8- PROVIDE VIBRATION ISOLATION SPRING HANGERS W/A MINIMUM OF 1" STATIC DEFLECTION, EQUAL TO VIBRAX.																


FAN SCHEDULE

TAG	TYPE	SPACE SERVED	MFG'R	MODEL	DRIVE	CFM	ESP	RPM	ELECTRICAL				SONES	WEIGHT (LBS)	REMARKS
									VOLTS/PHASE/FREQ.	HP	FLA	WATTS			
EE-1	ROOF MOUNTED	FIRST FLOOR	GREENHECK	CUE-100	DIRECT	400	0.5	1,142	115/1/60	0.2	-	-	-	65	1, 2, 4, 6
EE-2	ROOF MOUNTED	SECOND FLOOR	GREENHECK	CUE-100	DIRECT	600	0.5	1,142	115/1/60	0.2	-	-	-	65	1, 2, 4, 6
EE-3	IN LINE CEILING	FIRST FLOOR	GREENHECK	SQ-95	DIRECT	200	0.2	1,142	115/1/60	0.1	-	-	-	50	1, 2, 5
SE-1	ROOF MOUNTED	FIRST FLOOR	GREENHECK	USF-15-B7	DIRECT	500	0.5	1,142	115/1/60	0.2	-	-	-	180	2, 3, 6
SE-2	ROOF MOUNTED	SECOND FLOOR	GREENHECK	USF-15-B7	DIRECT	500	0.5	1,142	115/1/60	0.2	-	-	-	180	2, 3, 6
NOTES:															
1. PROVIDE WITH BACKDRAFT DAMPER IN EXHAUST DUCT															
2. MOUNT IN CEILING/ ROOF PER MANUFACTURER'S REQUIREMENTS															
3. TO BE OPERATED ON VIA DEMAND FROM FAN COILS															
4. TO BE OPERATED VIA TIME CLOCK															
5. TO BE OPERATED VIA LINE VOLTAGE THERMOSTAT & OCCUPANCY SENSOR															
6. WITH SPEED CONTROL															

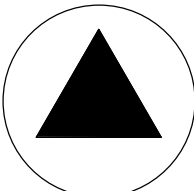

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25061 AVENUE STANFORD,  
VALENCIA, CA 91355  
PHONE: (818) 886-2190 FAX: (818) 886-2131

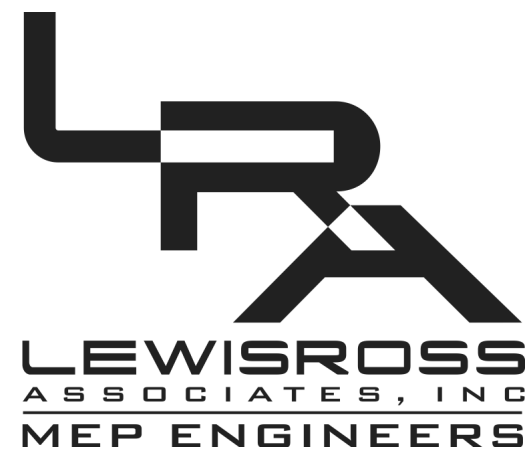PROJECT NAME: 23-115  
PROJECT NAME: BCHD allcove  
PROJECT ADDRESS: -

REV	DESCRIPTION	DATE

**allcove**  
BEACH CITIES  
HEALTH DISTRICT

100% PRELIMINARY DESIGN SUBMITTAL

PMA PROJECT NO. 23007  
DRAWING TITLE:  
**SCHEDULES**

SCALE: AS SHOWN  
DATE: 02/28/2024  
DRAWN BY:                      CHECKED BY:  
UK                                      TP  
SHEET NO.

**M-0.3**

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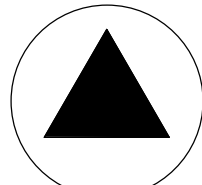
KEYNOTES MECHANICAL

# NOTE

- 1 VRF FAN COIL IN CEILING SPACE, PROVIDE MERV 13 FILTER BOX AND ACCESS IN CEILING.  
2 WALL MOUNTED VRF FAN COIL UNIT, PROVIDE CONDENSATE PUMP IF REQUIRED PER SITE CONDITION.  
3 OUTSIDE AIR INTAKE WALL CAP

GENERAL NOTE:

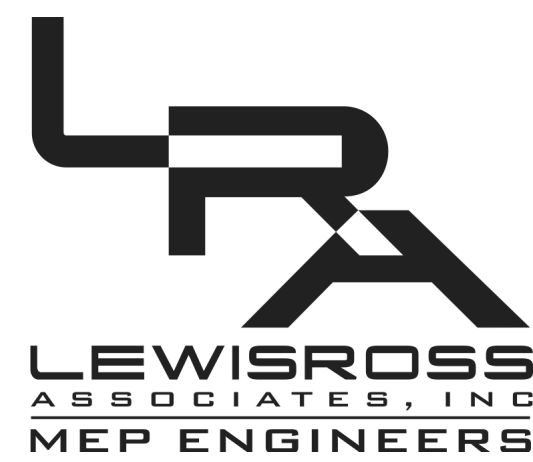
COORDINATE LOCATIONS FOR ALL MECHANICAL EQUIPMENT WITH CEILING MOUNTED DEVICES INCLUDING BUT NOT LIMITED TO LIGHT FIXTURE LAYOUTS, SPEAKERS AND AV PROJECTORS. FAN COIL UNIT LOCATIONS SHOWS DIAGRAMMATIC AND REQUIRES FURTHER COORDINATION WITH STRUCTURE AND DEVICES NOTED ABOVE.




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1 1ST FLOOR HVAC PLAN

1/4" = 1'-0"

PROJECT NAME: 23-115

PROJECT NAME: BCHD allcove

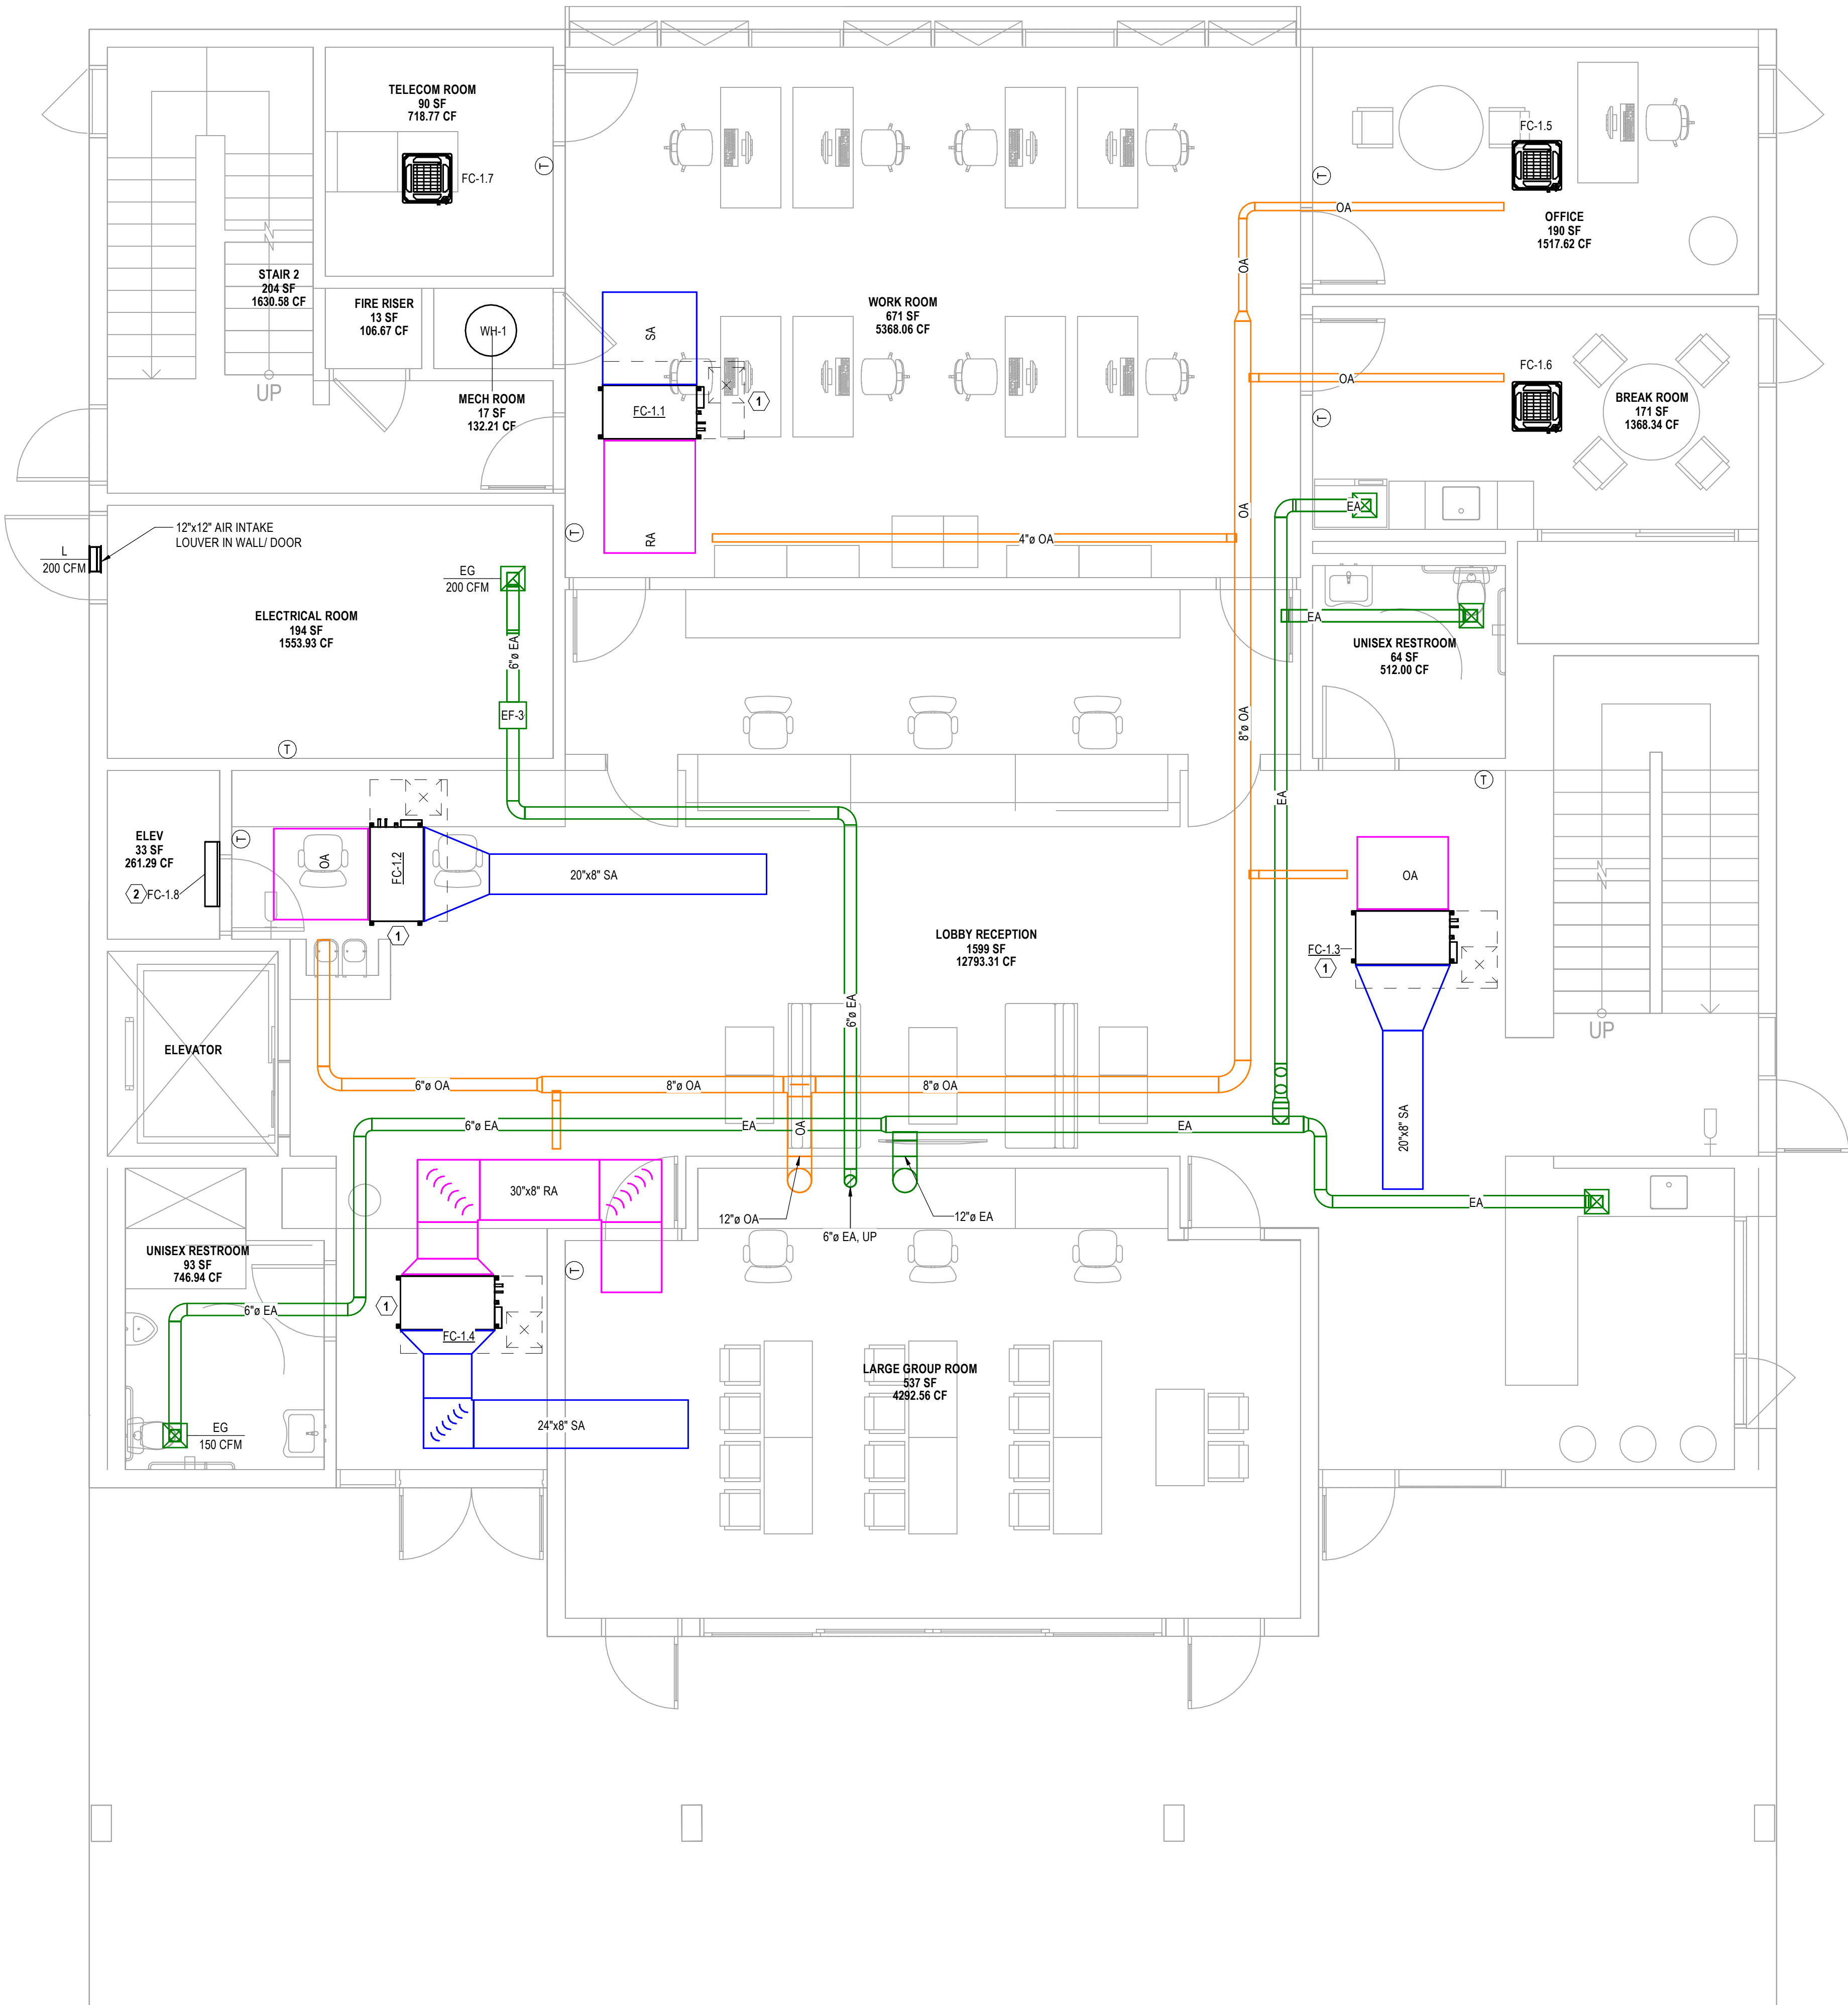PROJECT ADDRESS: -

REV	DESCRIPTION	DATE
-----	-------------	------


allcove  
BEACH CITIES  
HEALTH DISTRICT

100% PRELIMINARY DESIGN SUBMITTAL

PMA PROJECT NO. 23007

DRAWING TITLE:

1ST FLOOR HVAC PLAN

SCALE: AS SHOWN

DATE: 02/28/2024

DRAWN BY: UK CHECKED BY: TP

SHEET NO.

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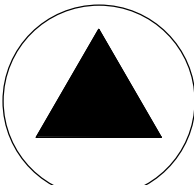


KEYNOTES MECHANICAL

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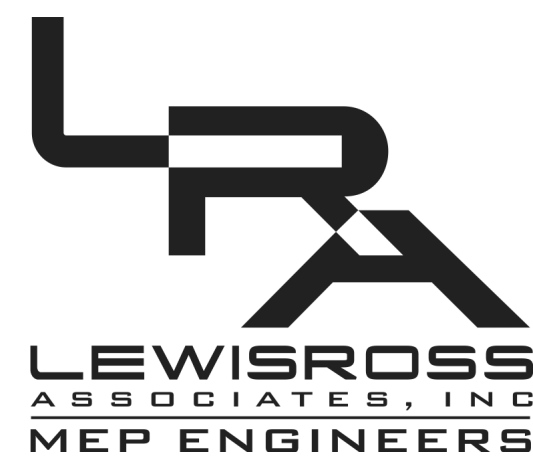
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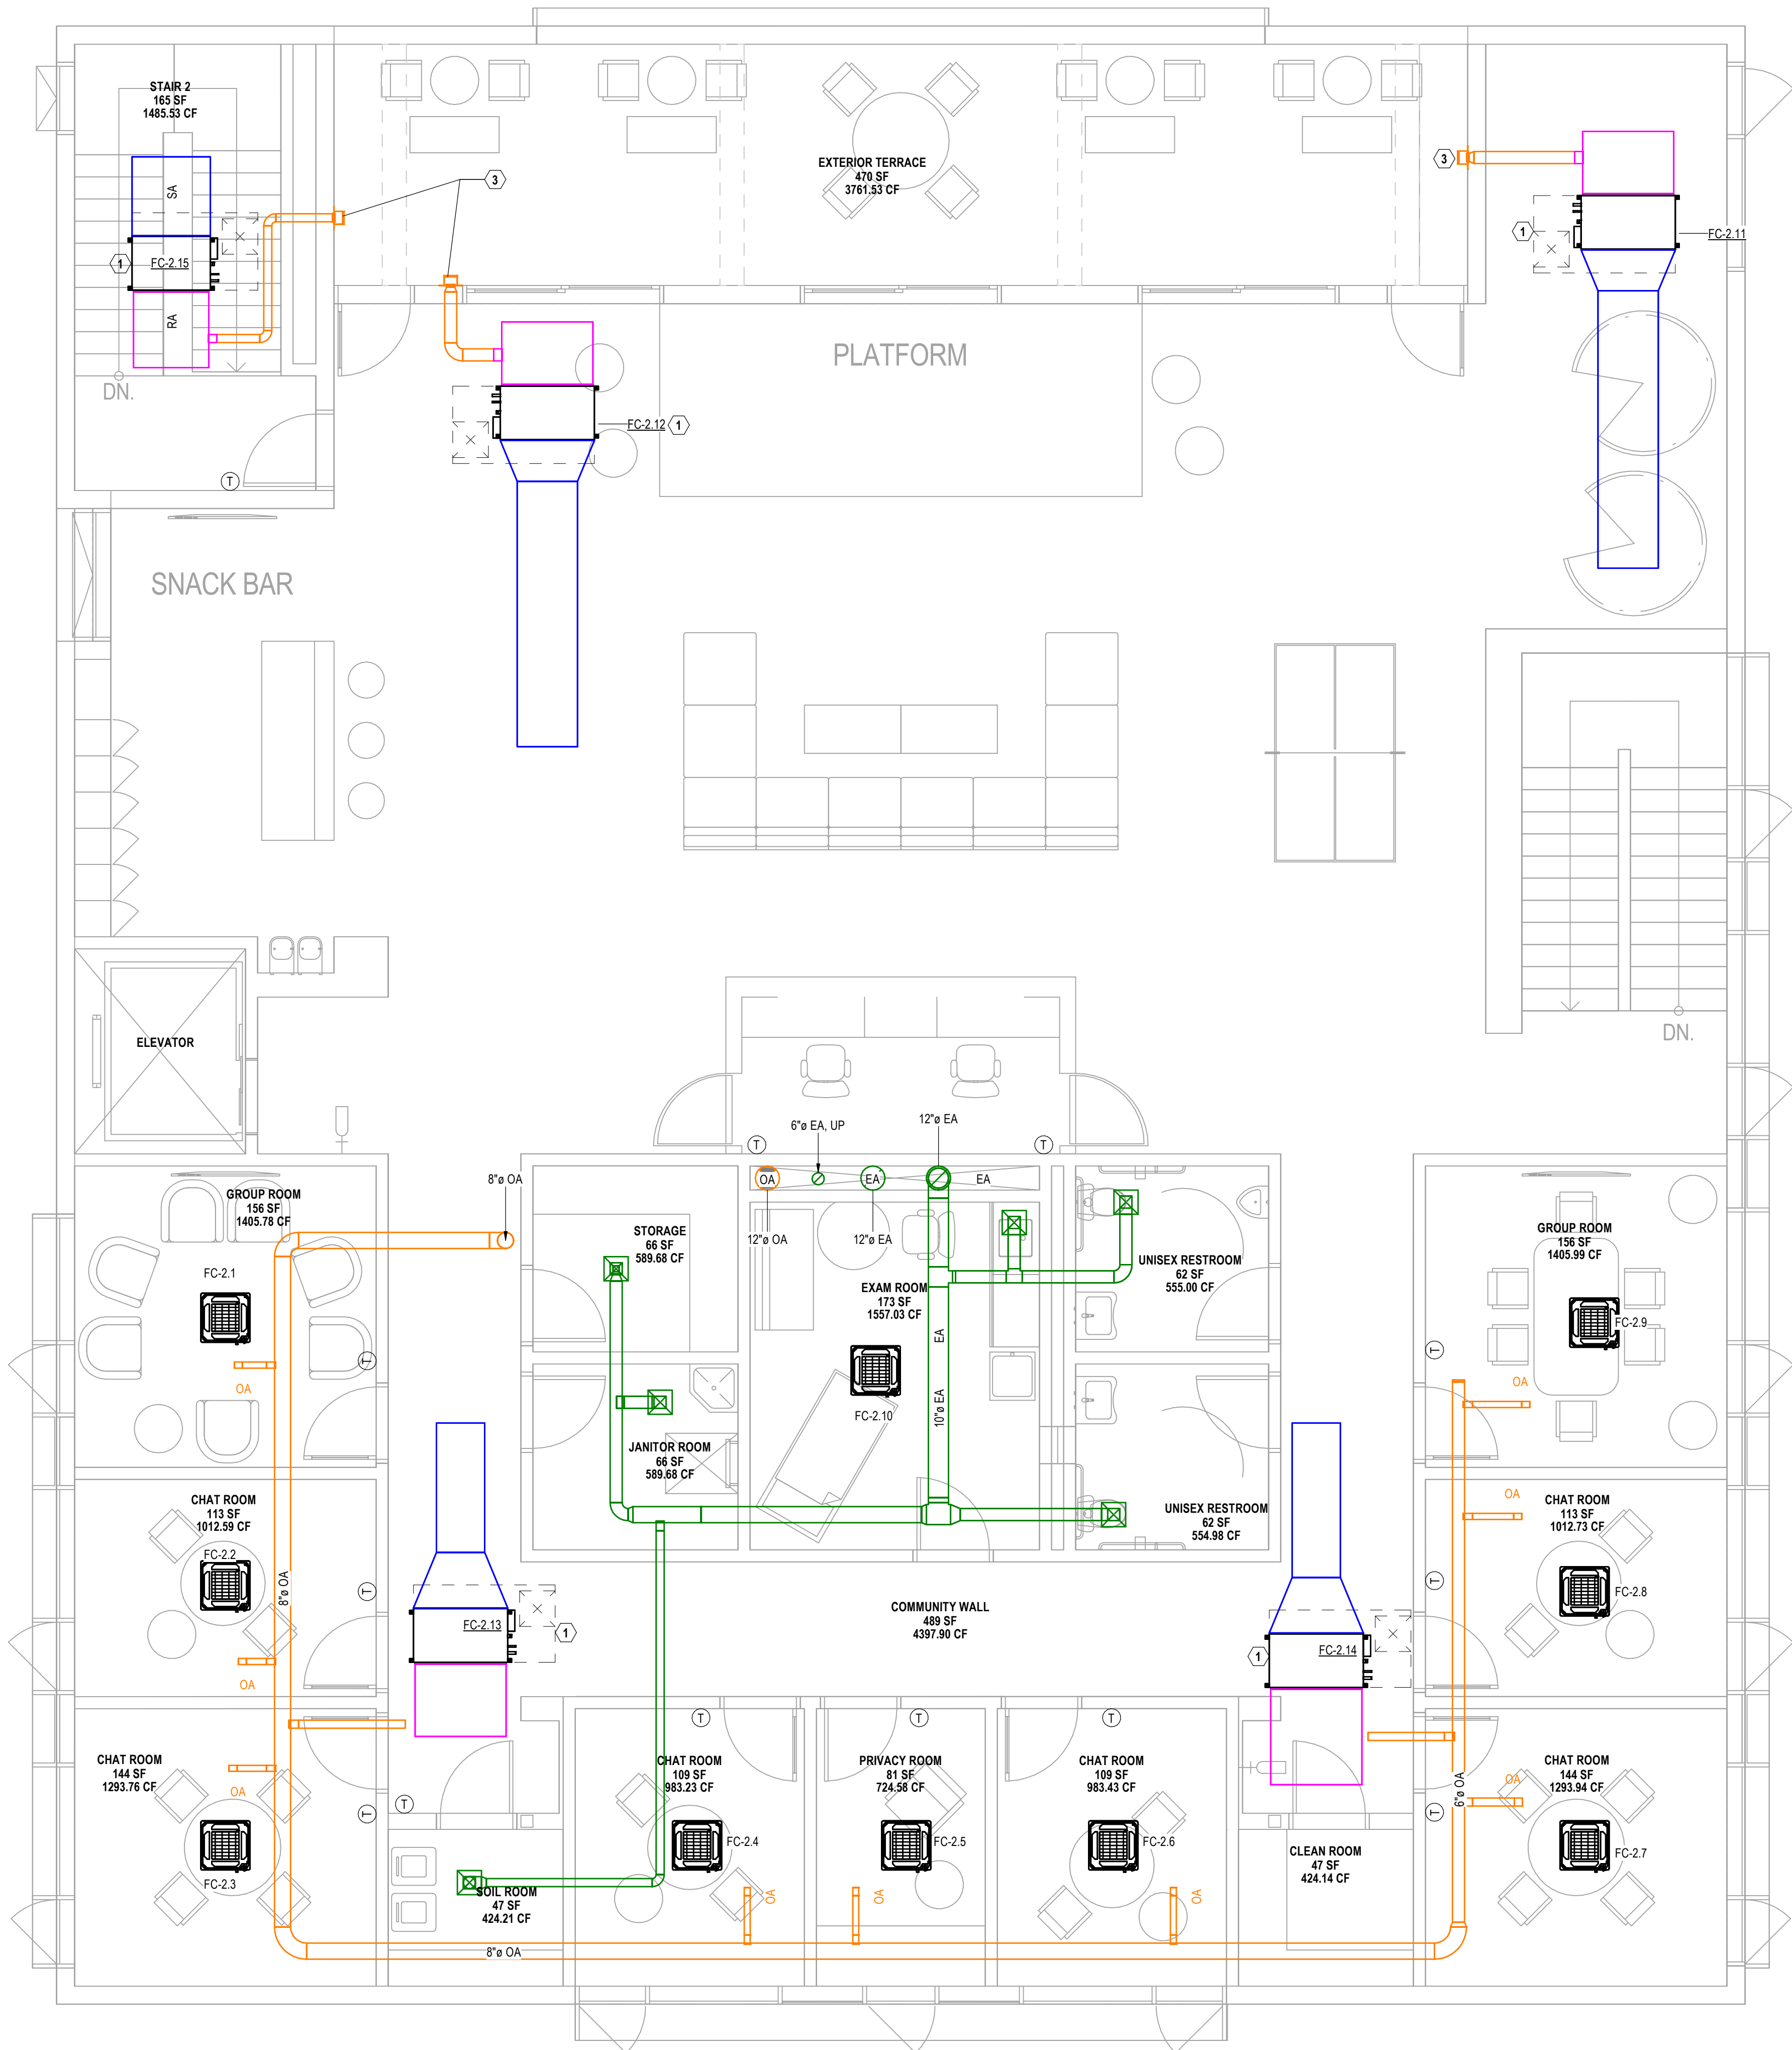
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25061 AVENUE STANFORD,  
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1 2ND FLOOR HVAC PLAN  
1/4" = 1'-0"

PROJECT NAME: 23-115		
PROJECT NAME: BCHD allcove		
PROJECT ADDRESS: -		
REV	DESCRIPTION	DATE

allcove  
BEACH CITIES  
HEALTH DISTRICT

100% PRELIMINARY DESIGN SUBMITTAL

PMA PROJECT NO. 23007

DRAWING TITLE:

2ND FLOOR HVAC PLAN

SCALE: AS SHOWN

DATE: 02/28/2024

DRAWN BY: CHECKED BY:

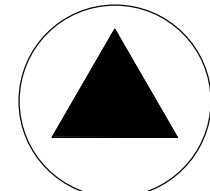
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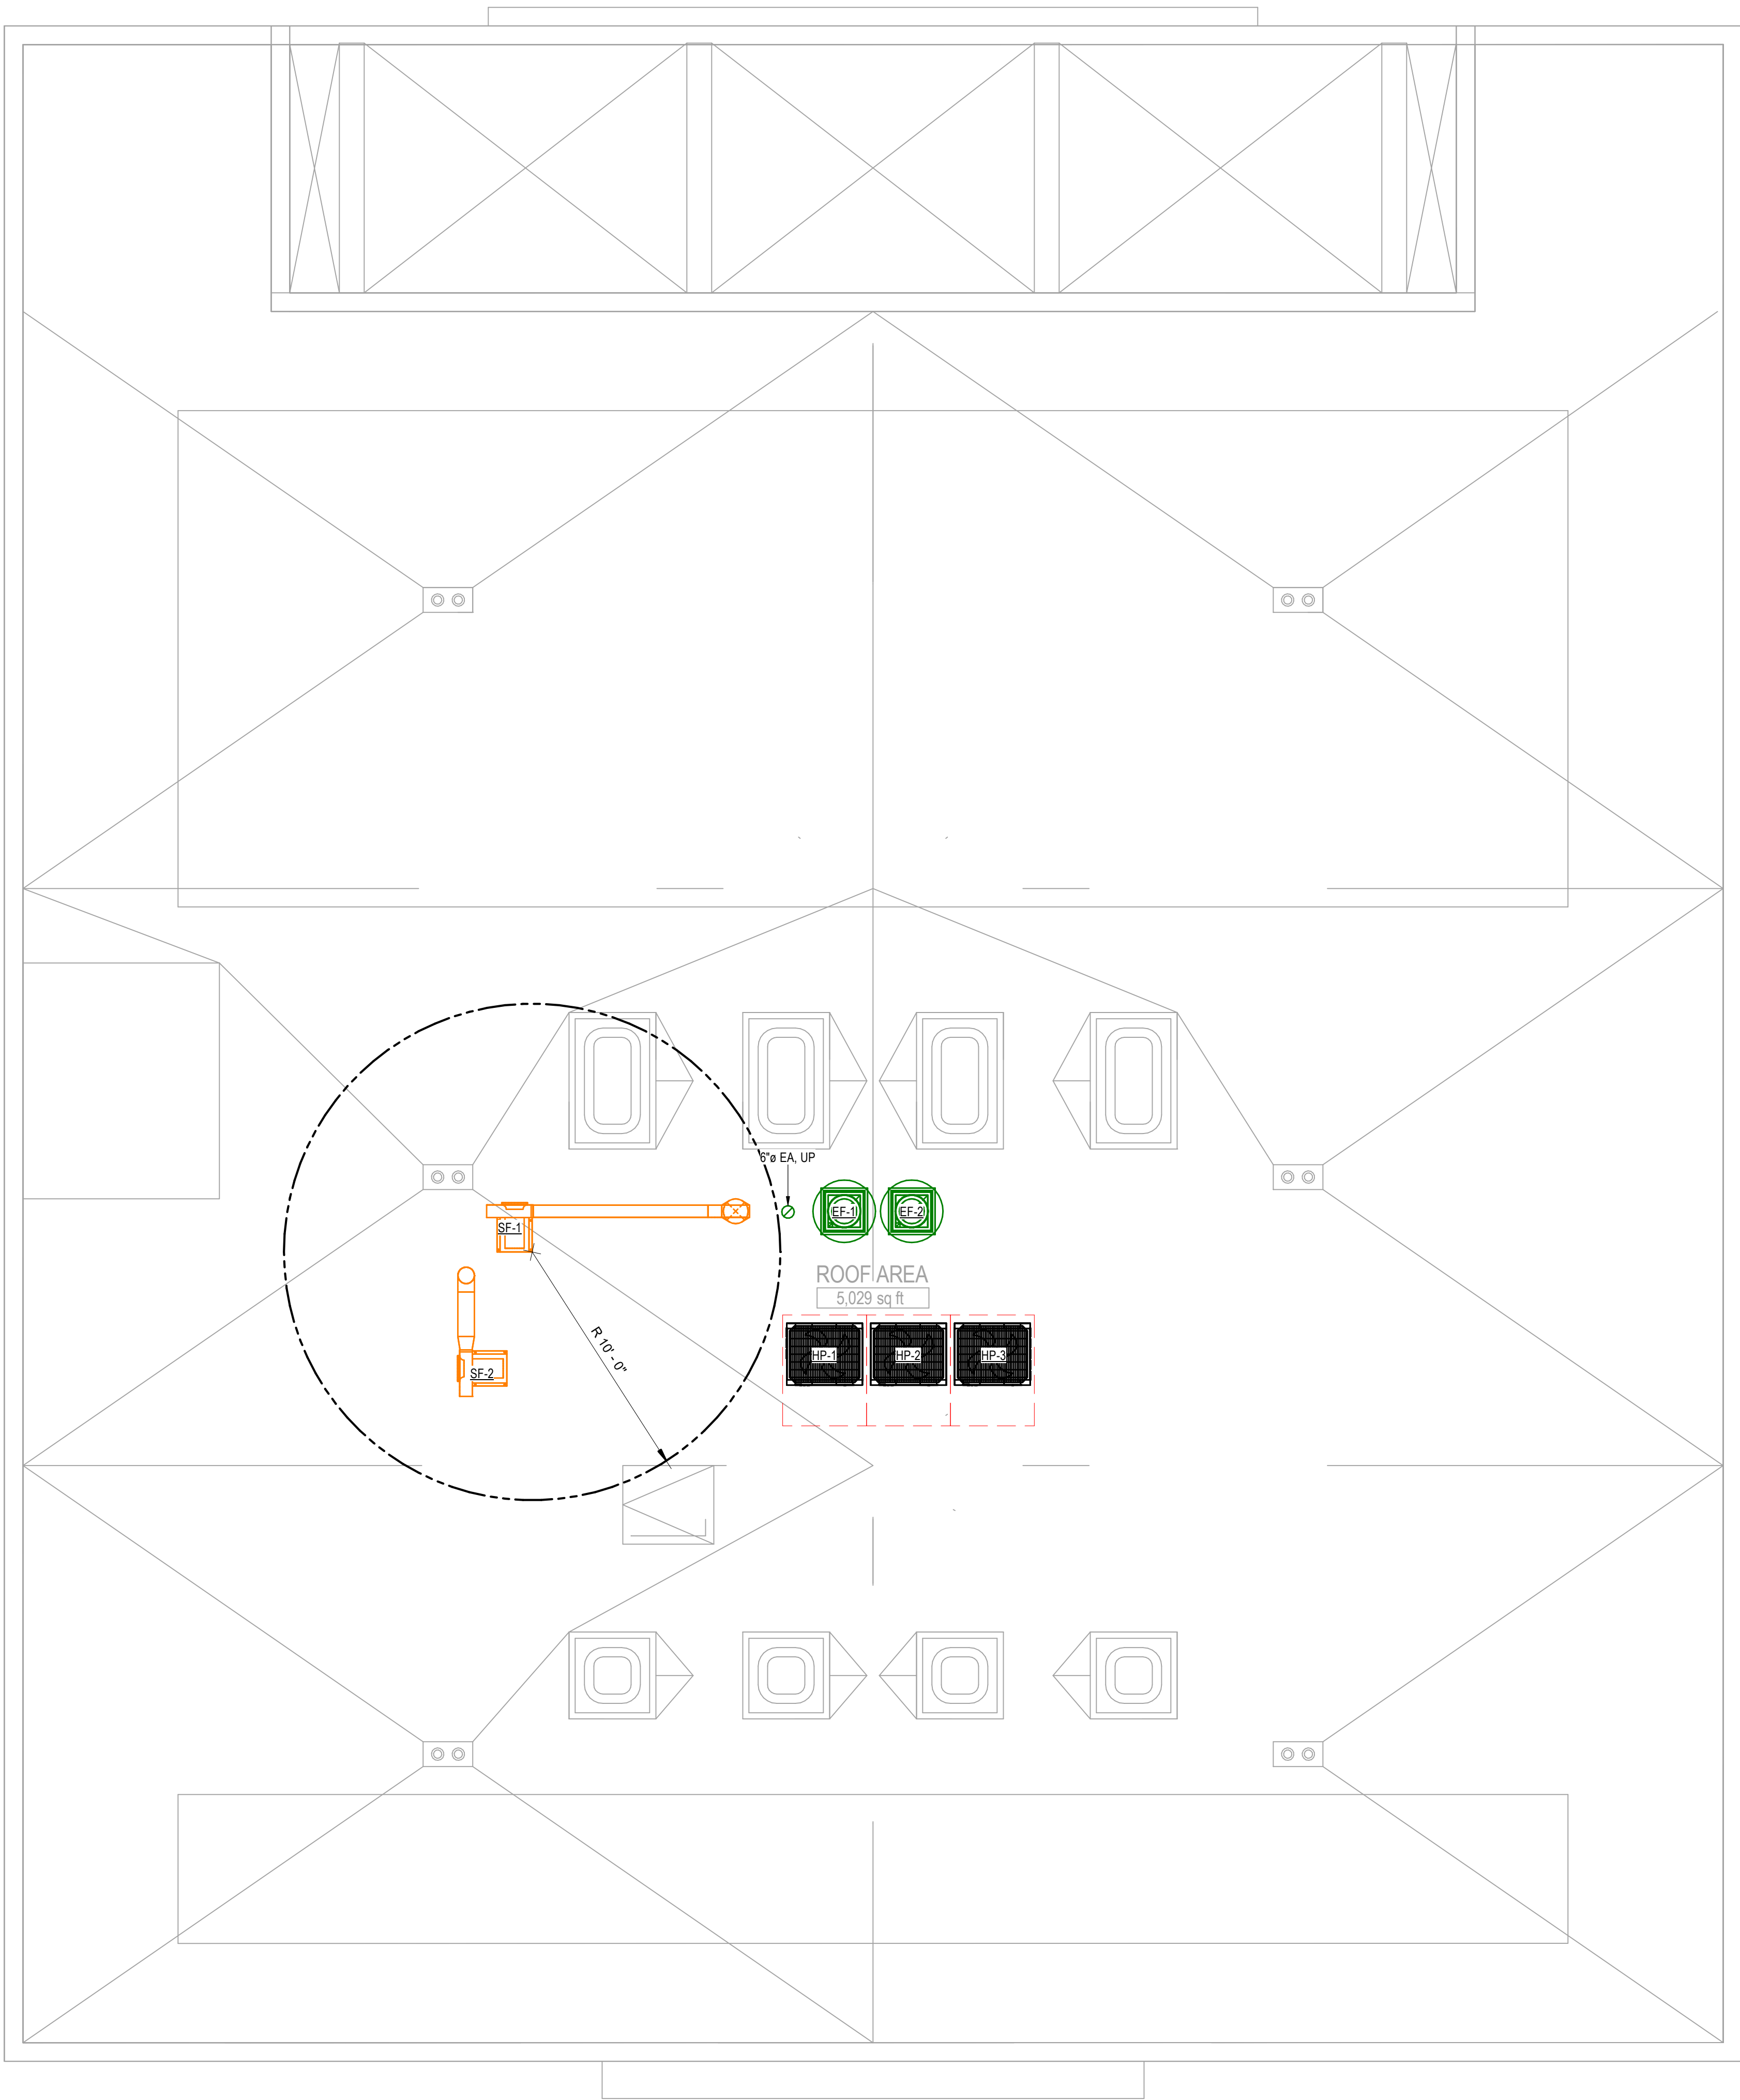
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1 ROOF HVAC PLAN  
1/4" = 1'-0"

PROJECT NAME: 23-115		
PROJECT NAME: BCHD allcove		
PROJECT ADDRESS: -		
REV	DESCRIPTION	DATE

allcove  
BEACH CITIES  
HEALTH DISTRICT

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PMA PROJECT NO. 23007  
DRAWING TITLE:  
ROOF HVAC PLAN

SCALE: AS SHOWN  
DATE: 02/28/2024  
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## GENERAL NOTES

## ABBREVIATIONS

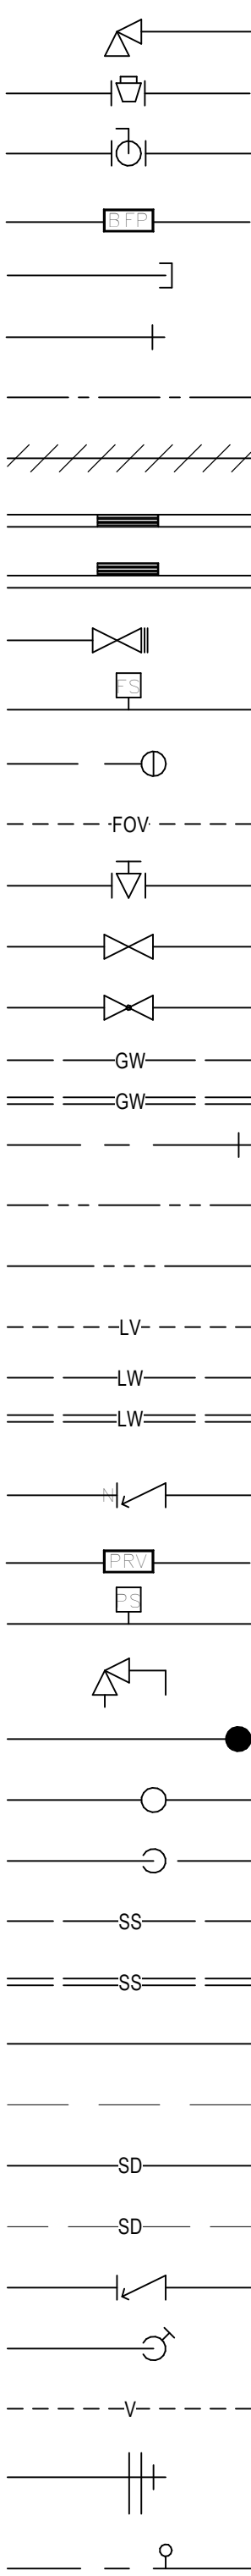
## PLUMBING LEGEND

COMMON


1. THE WORK OF THIS SECTION INCLUDES ALL PLUMBING WORK AND EQUIPMENT NECESSARY TO COMPLETELY EQUIP THE BUILDING FOR THE PROPOSED OCCUPANCY. THE CONTRACTOR SHALL SUPPLEMENTARY LABOR OR MATERIALS, WHETHER OR NOT SPECIFICALLY INDICATED, WITHOUT ADDITIONAL COST TO THE OWNER.
2. ALL WORK MARKED OR IDENTIFIED BY ITEMS MARKED (E) OR SHOWN LIGHT ARE EXISTING TO REMAIN. DIAGONALLY HATCHED AREAS INDICATE EXISTING ITEMS TO BE DEMOLISHED.
3. ACQUIRE A DAY PASS FOR ALL PERMITS, INSPECTIONS, AND RELATED FEES FOR THIS INSTALLATION. MAKE ALL ARRANGEMENTS WITH UTILITY COMPANIES FOR SERVICE AND CONNECTIONS.
4. VERIFY AND COORDINATE ROOM-IN, LOCATIONS AND DIMENSIONS FOR EQUIPMENT. PROVIDE ALL INTERCONNECTING PIPING AND APPURTENANCES REQUIRED AND MAKE ALL FINAL CONNECTIONS.
5. VERIFY ALL PLUMBING IN COORDINATION WITH ELECTRICAL, MECHANICAL, ARCHITECTURAL AND STRUCTURAL DRAWINGS AND TRADES.
6. VERIFY EXISTING SIZE, LOCATIONS, AND DEPTH (WHERE APPLICABLE) OF ALL EXISTING PIPING AND EQUIPMENT. VERIFY ALL EXISTING PIPING AND EQUIPMENT IS IN GOOD WORKING ORDER THAT INVERT ELEVATIONS ARE SUFFICIENT TO MAINTAIN REQUIRED SLOPES. SHOULD IT BE NECESSARY TO REROUTE LINES DUE TO CONDITIONS FOUND ON THE SITE OR IF NOTED IN THE EXISTING RECORDS, THE CONTRACTOR SHALL BE RESPONSIBLE FOR THE RELOCATION OF THE PIPE, BEFORE CONTINUING, NOTIFY THE ARCHITECT PRIOR TO INSTALLING ANY WORK WHICH MAY BE AFFECTED.
7. INSTALL HOT AND COLD WATER PIPING WITHIN 5' OF THE HEAT SOURCE IN NON-REGULATING SYSTEMS, BOTH BURIED AND EXPOSED, WITH MINIMUM 1" THICK MANVILLE MICROLOK 60-APT FIBERGLASS SNAP-ON INSULATION PER SECTION 6150Q AND 6151 (FIBERGLASS INSULATION). PROVIDE PROTECTIVE COATING, THERMAL BREAK, AND PROTECTIVE PERFORMANCE, MATERIAL, WORKMANSHIP AND APPEARANCE TO THOSE SPECIFIED. MAKE NO SUBSTITUTIONS WITHOUT PRIOR WORK ORDER APPROVAL.
8. VERIFICATION OF DIMENSIONS AND LOCATIONS OF EQUIPMENT ARE APPROXIMATE. BEFORE PROCEEDING WITH ANY WORK, CHECK AND VERIFY DIMENSIONS AND SIZES, AND ASSUME FULL RESPONSIBILITY FOR FITTING IN OF EQUIPMENT AND MATERIALS TO OTHER EXISTING EQUIPMENT AND MATERIALS. VERIFY ALL DIMENSIONS AND LOCATIONS OF EQUIPMENT HAVE BEEN INDICATED ON THE DRAWINGS. DIMENSIONS HAVE BEEN TAKEN FROM TYPICAL EQUIPMENT OF THE CLASS INDICATED ON THE DRAWINGS. DIMENSIONS HAVE BEEN TAKEN FROM TYPICAL EQUIPMENT. THE CONTRACTOR SHALL BE RESPONSIBLE FOR VERIFYING THAT EQUIPMENT COMPLETED FOR USE WILL FIT INTO SPACES PROVIDED, WITH AMPLE SPACE FOR MAINTENANCE REQUIREMENTS.
9. VERIFY ALL PIPING AND EQUIPMENT LOCATIONS INDICATED ON THE DRAWINGS ARE APPROXIMATE ONLY AND SHALL BE CHANGED TO MEET THE ARCHITECTURAL AND STRUCTURAL CONDITIONS AS REQUIRED. AT NO EXTRA COST TO THE OWNER.
10. VERIFY ALL PARTS, FITTINGS, AND CONNECTIONS ARE IDENTIFICATION DIAGRAMMATIC TO THE EXTENT THAT ALL OFFSETS, BENDS, SPECIAL FITTINGS, AND EXACT LOCATIONS ARE NOT INDICATED. LOCATION OF PIPING MAY VARY AS LONG AS INDICATED PIPE SIZES ARE INSTALLED. EXAMINE ALL EXISTING PIPING, FITTINGS, AND CONNECTIONS, DETERMINE BEST METHOD, EXACT LOCATION, ROUTES AND BUILDING ORSTRUCTIONS. INSTALL APPARATUS AND EQUIPMENT IN AVAILABLE LOCATIONS.
11. THE CONTRACTOR SHALL HAVE ALL APPLICABLE ORDINANCES, REGULATIONS, AND CODES. CONTRACTOR SHALL POSSESS A WORKING KNOWLEDGE OF ALL APPLICABLE CODES AND ORDINANCES AND SHALL CALL ATTENTION TO ANY DISCREPANCIES AND SEEK CLARIFICATIONS PRIOR TO SUBMITTING ANY REQUEST FOR REVISION. THE CONTRACTOR SHALL BE RESPONSIBLE FOR RESOLVING ALL DISCREPANCIES IN CASE OF CONFLICT BETWEEN CODES AND DRAWINGS OR SPECIFICATIONS. THE MORE STRINGENT SHALL PREVAIL.
12. NO CONTRACTOR SHALL BE RESPONSIBLE FOR THE NEED TO BE COORDINATE PER WORK IN LOCATION THEREOF.
13. NO EXTRA FEE WILL BE PAID FOR FURNISHING ITEMS REQUIRED BY THE CODES, BUT NOT NOTED OR SPECIFIED ON THE DRAWINGS. THE CONTRACTOR SHALL BE RESPONSIBLE FOR THE RULINGS AND INTERPRETATIONS OF THE ENFORCING AGENCIES SHALL BE CONSIDERED AS PART OF THE CODE.
14. SEWER LINE SHALL SLOPE AT 1/4" PER FOOT (2%) OR MORE.
15. TEST SEWER PIPING TO ENSURE IT IS WATER TIGHT AT ALL POINTS BY PLUGGING THE END OF THE BUILDING SEWER AT ITS POINTS OF CONNECTION TO THE EXISTING SEWER AND FILLING THE LINE WITH WATER TO 10' ABOVE THE FINISH FLOOR. THE CONTRACTOR SHALL BE RESPONSIBLE FOR THE RULINGS AND INTERPRETATIONS OF THE ENFORCING AGENCIES SHALL BE CONSIDERED AS PART OF THE CODE OR BY APPROVED EQUIVALENT LOW-PRESSURE AIR TEST. PLASTIC DWV PIPING SHALL NOT BE TESTED BY THE AIR TEST METHOD.
16. ALL SINKS, BATHTUBS, AND DRAIN PIPING BELOW HANDICAP LAVATORIALS AND SINKS WITH PROWAP INSULATION BY IT MCGURE AND OFFERT P.TRAP AGAINST WALL.
17. ALL REQUIRED CLEANOUTS SHALL BE INSTALLED AS PER SECTION 707 & 719 OF THE INTERNATIONAL PLUMBING CODE. FLUSH VALVES SHALL BE INSTALLED AS PER SECTION 707 & 719. ONLY WHEN EASILY ACCESSIBLE AND COORDINATE LOCATIONS WITH THE ARCHITECT PRIOR TO INSTALLATION TO ACCOUNT FOR ALL EQUIPMENT, CABINETS, AND OTHER TRADES.
18. ALL PLUMBING IS TO BE INSTALLED FOR FIXTURES AND EQUIPMENT SHALL BE PROVIDED WITH A LINE SIZE SHUT OFF VALVE.
19. ALL PLUMBING MATERIALS SHALL BE IN THE WATER SUPPLY SYSTEM. EXCEPT VALVES AND SIMILAR EQUIPMENT, ALL PLUMBING SHALL BE INSTALLED IN ACCORDANCE WITH THE FOLLOWING:
20. PROVIDE SHUT OFF VALVES ON PIPES AT POINT OF TIE-IN TO EXISTING SYSTEM. ALL VALVES, UNIONS, AND FITTINGS TO BE OF THE SAME SIZE AS THE PIPE UNLESS OTHERWISE NOTED.
21. ALL VALVES SHALL BE FULLY OPERABLE AND BE INSTALLED IN ACCORDANCE WITH THE FOLLOWING:
22. NEW OR REPAIRED POTABLE WATER SYSTEMS SHALL BE DISINFECTED PRIOR TO USE.
23. ACCORDING TO THE METHOD SET IN SECTION 609.9 OF THE PLUMBING CODE.
24. ALL PLUMBING IS TO BE INSTALLED IN ACCORDANCE WITH THE FOLLOWING: TO BE LISTED OR LABELED AND INSTALLED AS PER A RECOGNIZED APPLICABLE AGENCY.

- (E)  
(N)  
(N)  
A/C  
AHJ  
ARCH  
(RE)  
AVC  
AS  
BC  
BFP  
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CHWR  
CLWV  
CLWV  
CO  
CSP  
CW  
CTRTOP  
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VAC  
VOC  
VTR  
WCO  
WHA  
WIF  
XFM

- [illegible]



ANGLE VALVE  
BALANCING COCK  
BALL VALVE  
BACKFLOW PREVENTER  
CAP OR PLUG ON END OF PIPE  
CLEANOUT  
COLD WATER  
DEMOLISH  
FIRE HOSE CABINET (RECESSED)  
FIRE HOSE CABINET (SURFACE MOUNTED)  
FIRE HOSE VALVE  
FLOW SWITCH  
FLOOR CLEANOUT, CLEANOUT TO GRADE  
FUEL OIL VENT  
GAS COCK, GAS STOP  
GATE VALVE  
GLOVE VALVE  
GREASE WASTE  
(SHOWN AS DOUBLE LINE BELOW GROUND)  
HOSE BIBB  
HOT WATER  
HOT WATER RETURN  
LABORATORY VENT  
LABORATORY WASTE  
(SHOWN AS DOUBLE LINE BELOW GROUND)  
NON-SLAM CHECK VALVE  
PRESSURE REDUCING VALVE  
PRESSURE SWITCH  
PRESSURE-TEMPERATURE RELIEF VALVE  
RISER DOWN  
RISER UP  
RISE OR DROP  
SANITARY SEWER  
(SHOWN AS DOUBLE LINE BELOW GROUND)  
SEWER OR WASTE ABOVE GRADE  
SEWER OR WASTE BELOW GRADE  
STORM DRAIN ABOVE GRADE  
STORM DRAIN BELOW GRADE  
SWING CHECK VALVE  
VALVE IN RISER  
VENT  
WALL CLEANOUT  
WATER HAMMER ARRESTOR

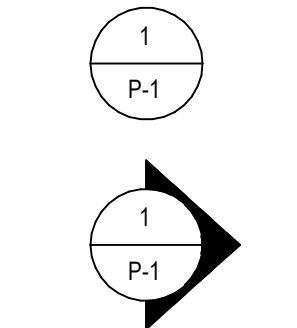

## PLUMBING MATERIAL SCHEDULE

SERVICE	LOCATION	COPPER TYPE "M" (THIN WALLED)	COPPER TYPE "L" (MEDIUM WALLED)	COPPER TYPE "K" (THICK WALLED)?	PVC SCHEDULE 808	CAST IRON?	NOTED NOTES
WATER	INSIDE		•				1
	OUTSIDE		•				1
SANITARY DRAINAGE	BELOW GRADE			•	•		
	INSIDE						3
SANITARY VENT	BELOW GRADE					•	5,6
CONDENSATE DRAINAGE	INSIDE	•				•	4
	OUTSIDE		•				
INDIRECT WASTE	INSIDE		•				1
	OUTSIDE		•				1

NOTES:  
1. LEAD FREE SOLDERED FITTINGS  
2. ABS IS NOT ALLOWED IN BUILDINGS OVER TWO STORIES. PROVIDE CAST IRON DWV.  
3. TYLER 4 BAND NO-HUB COUPLINGS.  
4. TYLER 2 BAND NO-HUB COUPLINGS.  
5. DO NOT USE IN THERMAL RISER.  
6. GASKETED JOINT FOR PVC.  
7. 3" & SMALLER, SOFT TEMPER BRAZED JOINTS W/ BITUMINOUS COATING.  
8. TEMPERATURES MUST NOT EXCEED 120°F, NOT ALLOWED INSIDE OR BELOW BUILDING.

## STANDARD PIPE SUPPORT SPACING SCHEDULE

PIPE SIZE	SUPPORT ROD DIAMETER	MAX SUPPORT SPAN, STEEL PIPE (FT)	MAX SUPPORT SPAN, COPPER PIPE (FT)
1/2"	3/8"	5	5
3/4"	3/8"	8	8
1"	3/8"	8	8
1-1/2"	3/8"	8	8
2"	3/8"	10	8
2-1/2"	1/2"	10	-
3"	1/2"	10	-
3-1/2"	1/2"	10	-
4"	5/8"	10	-

## WASTE & VENT SIZING CHART

PIPE SIZE	DRAINAGE FU	VENT FU
1 1/2"	2	8
2"	8	24
2 1/2"	14	48
3"	35	84
4"	216	256
6"	720	1380

## OVERALL SITE PLAN

## PLUMBING FIXTURE SCHEDULE

PROVIDE DAHL OR BRASSCRAFT 1/4 TURN STOP VALVES, SUPPLY TUBES, AND ESCUTCHEON PLATES FOR ALL FIXTURES. SUBMIT ALL FIXTURES TO ARCHITECT FOR APPROVAL PRIOR TO PURCHASE									
TAG	DESCRIPTION	SIMILAR TO		WASTE	VENT	COLD WATER	HOT WATER	NOTES	
		MFR	MODEL						
DF	DRINKING WATER FOUNTAIN	BY ARCHITECT	BY ARCHITECT	2"	1 1/2"	1/2"			
HB	COLD WATER STUB W/ ANGLE STOP VALVE					1/2"			
HI	COLD WATER STUB W/ ANGLE STOP VALVE					1/2"			
LAV	WALL-HUNG LAVATORY	BY ARCHITECT	BY ARCHITECT	2"	1 1/2"	1/2"	1/2"	VERIFY SPEC W/ ARCHITECT	
LS	LAUNDRY SINK	BY ARCHITECT	BY ARCHITECT	2"	1 1/2"	3/4"	3/4"	VERIFY SPEC W/ ARCHITECT	
OSD	15 Diameter Roof Drain	Zum Industries, LLC	Z1715-3BW	0"					
SD	15 Diameter Roof Drain	Zum Industries, LLC	Z1715-3BW	0"					
SE	SINK, EXAM	BY ARCHITECT	BY ARCHITECT	1 1/2"	1 1/2"	1/2"	1/2"	VERIFY SPEC W/ ARCHITECT	
SH	SHOWER	BY ARCHITECT	BY ARCHITECT	2"	1 1/2"	1/2"	1/2"	VERIFY SPEC W/ ARCHITECT	
SK	SINK, KITCHEN	BY ARCHITECT	BY ARCHITECT	1 1/2"	1 1/2"	3/4"	1/2"	VERIFY SPEC W/ ARCHITECT	
UR	WALL-HUNG URINAL	<varies>	<varies>	2"	1 1/2"	3/4"		0.5 GPF, BACK-SPLUD, PROVIDE ECOPOWER HIGH-EFFICIENCY URINAL FLUSH VALVE.	
WC	WATER CLOSET	BY ARCHITECT	BY ARCHITECT	3"	2"	1 1/4"		VERIFY SPEC W/ ARCHITECT	
WM-O					0"	0"	0"		
WM-F						0"	0"		

## WATER HEATER SCHEDULE - ELECTRIC STORAGE

TAG	SIMILAR TO		STORAGE CAPACITY	RECOVER @ 60°F RISE	ELECTRICAL				HW	CW	REMARKS
	MFR	MODEL			MOCp	Ø	V	W			
WH-1	RHEEM	PROP450	50.0 gal	0 GPM	15 A	1	120 V	4500 VA		1"	HEAT PUMP WATER HEATER, PROVIDE EXPANSION TANK & HOT WATER RECIRCULATION PUMP

## SCOPE OF WORK

DOMESTIC WATER, WASTE AND VENT PIPING FOR NEW MULTI-PURPOSE CENTER

## SHEET INDEX - PLUMBING

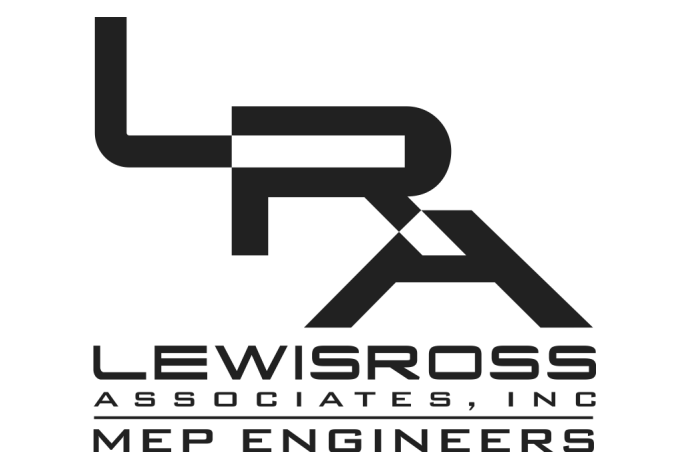
SHEET NO. SHEET NAME

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P-0.2	PLUMBING SITE PLAN
P-1.0	BELOW GROUND PLUMBING PLAN
P-1.1	FIRST FLOOR PLUMBING PLAN
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PS-1.0	FIRST FLOOR STORM WATER DRAINAGE PLAN
PS-1.1	SECOND FLOOR STORM WATER DRAINAGE PLAN
PS-1.2	ROOF STORM WATER PLAN

PAUL MURDOCH  
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25061 AVENUE STANFORD,  
VALENCIA, CA 91355  
PHONE: (818) 886-2190 FAX: (818) 886-2131

**PROJECT NAME:** 23-115

PROJECT NAME: BCHD allcover

**PROJECT ADDRESS: -**

[illegible]

**allcove**  
BEACH CITIES  
HEALTH DISTRICT

**100% PRELIMINARY DESIGN SUBMITTAL**

PMA PROJECT NO. 23007

DRAWING TITLE:  
**PLUMBING LEAD SHEET**

SCALE: AS SHOW

DATE: 02/28/2024

DRAWN BY: \_\_\_\_\_ CHECKED BY: \_\_\_\_\_

UK	TP
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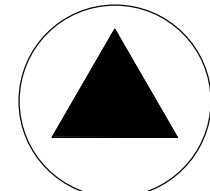
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SHEET NO.

## 1-0.1

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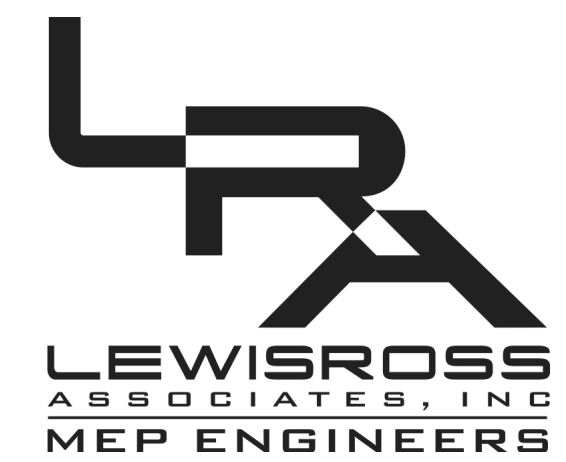





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1 PLUMBING SITE PLAN  
1/8" = 1'-0"

PROJECT NAME: 23-115

PROJECT NAME: BCHD allcove

PROJECT ADDRESS: -

REV	DESCRIPTION	DATE
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PMA PROJECT NO. 23007

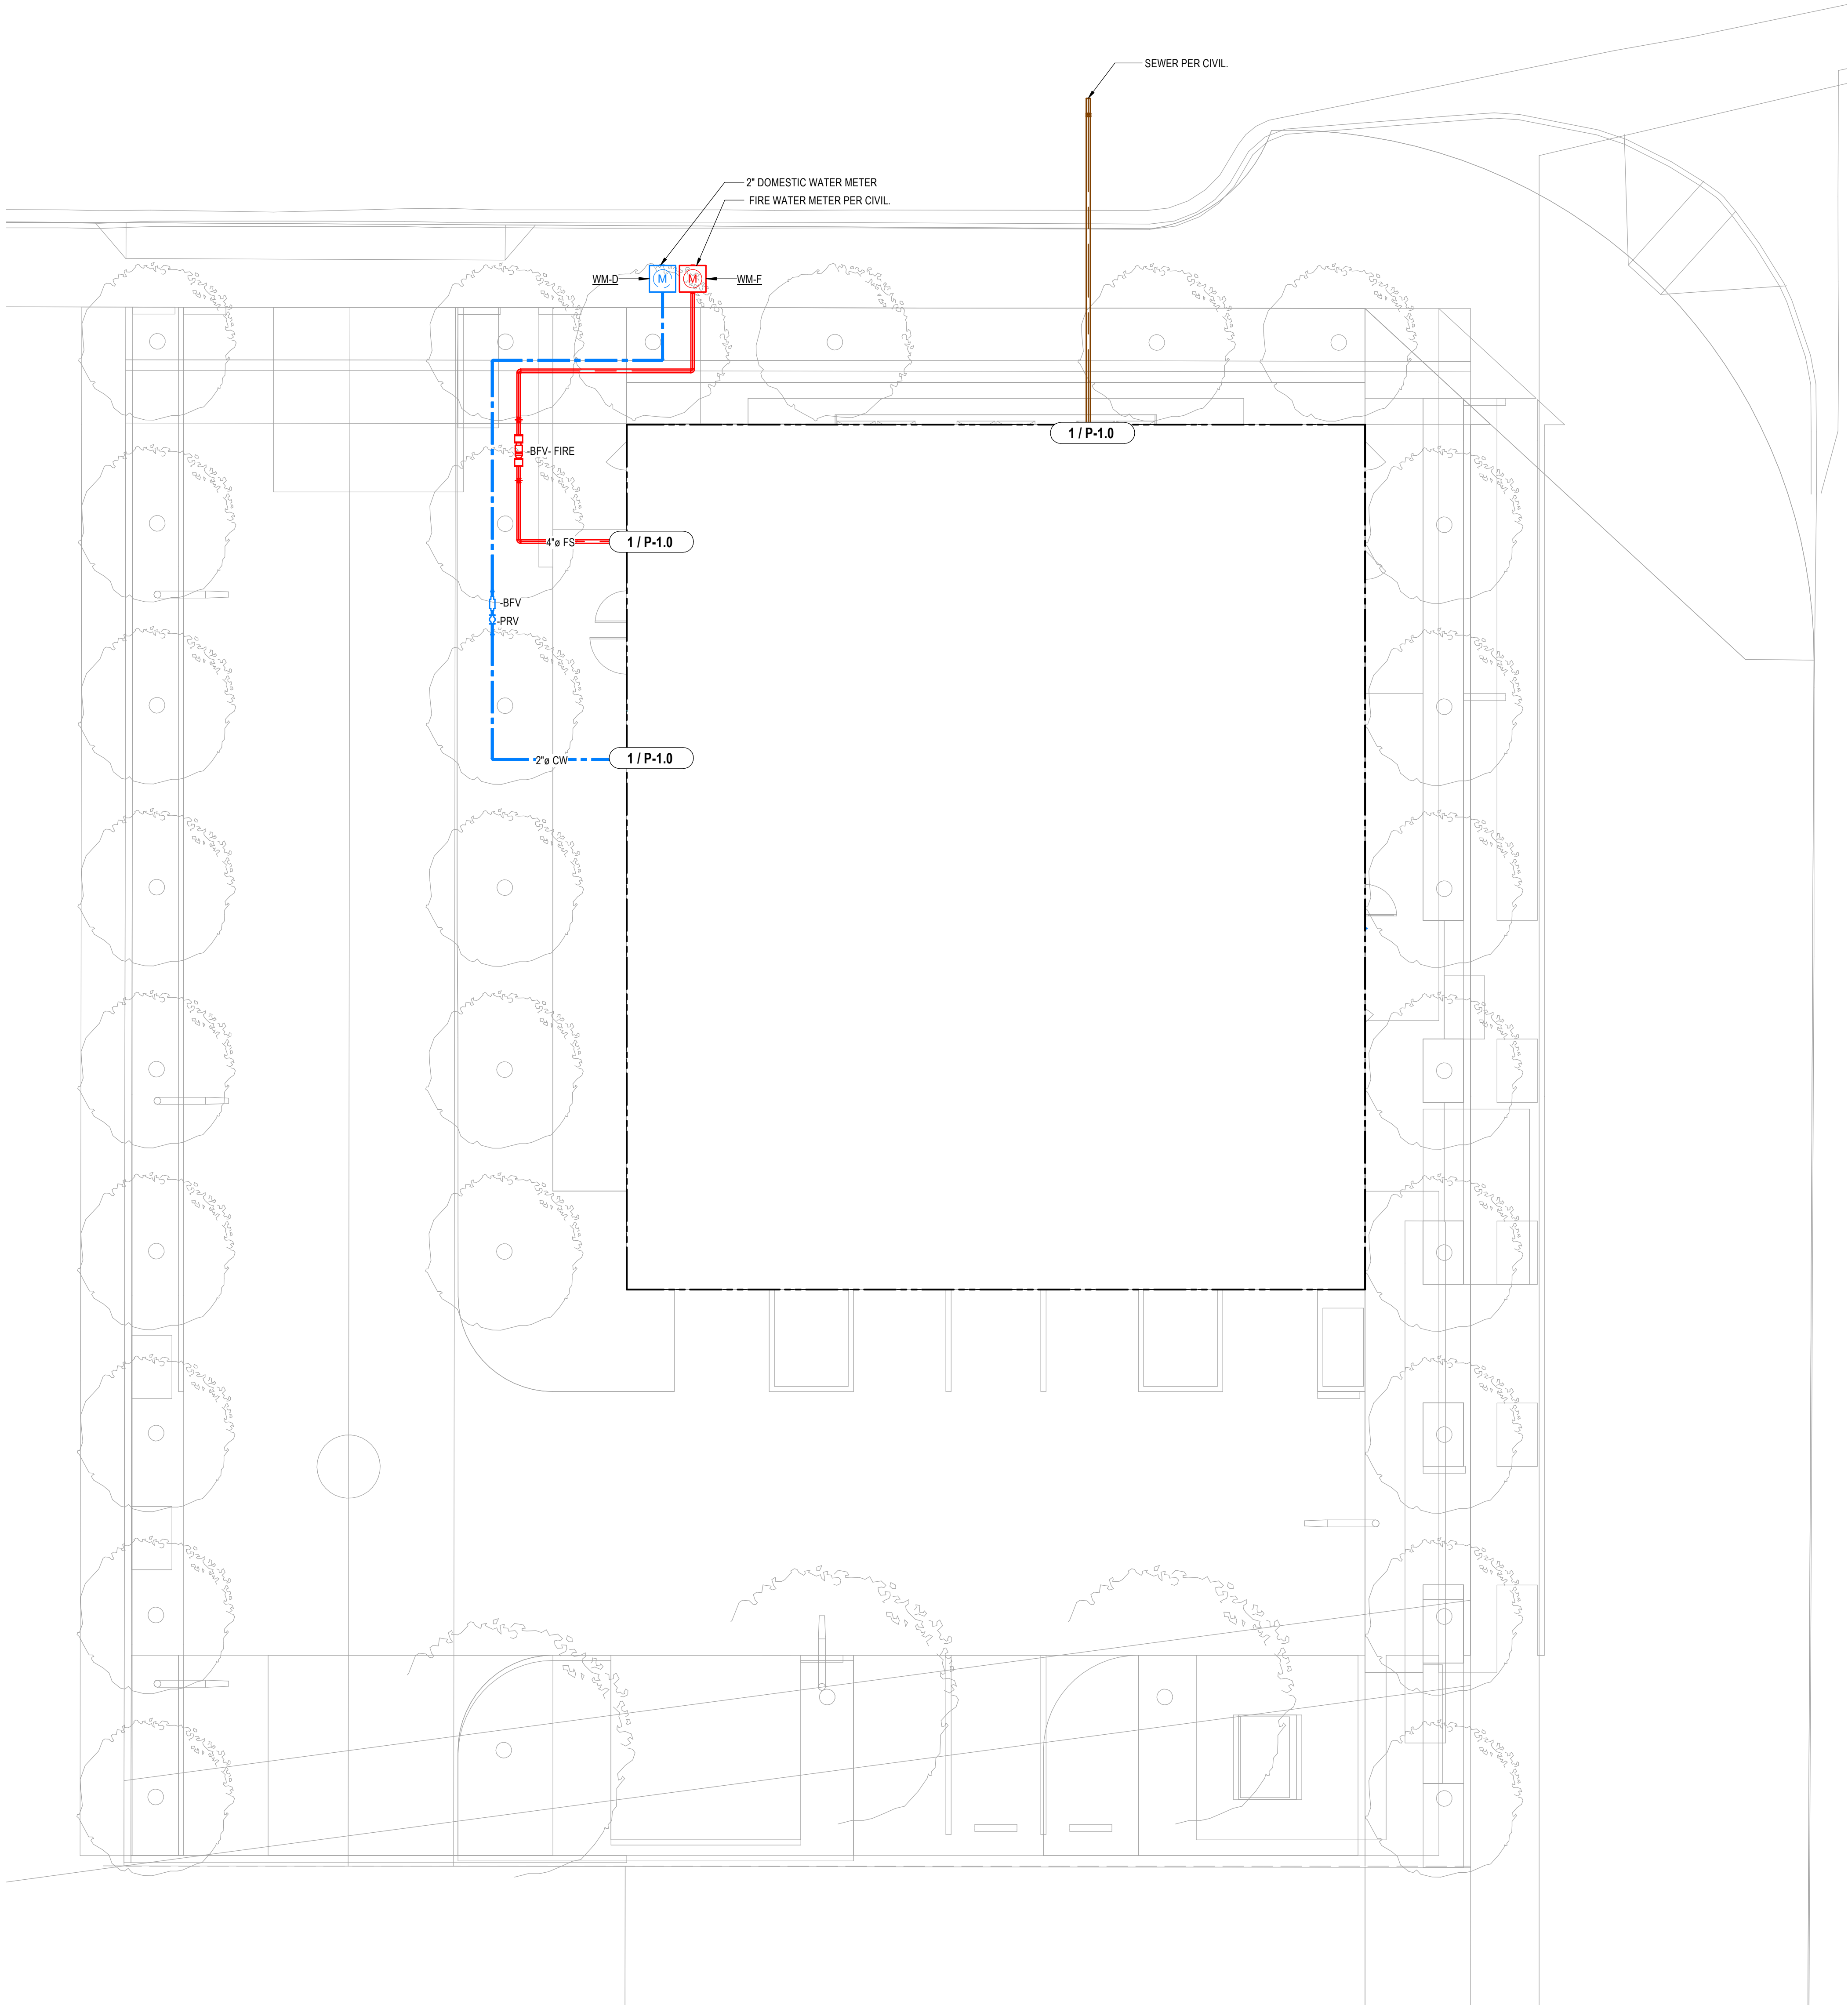DRAWING TITLE:

PLUMBING SITE PLAN

SCALE: AS SHOWN

DATE: 02/28/2024

DRAWN BY: UK CHECKED BY: TP

SHEET NO. P-0.2


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PROJECT NAME: 23-115

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PROJECT NAME: BCHD allcove
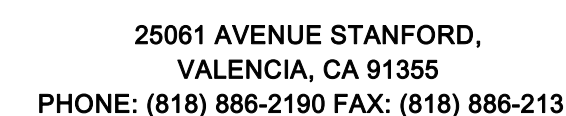
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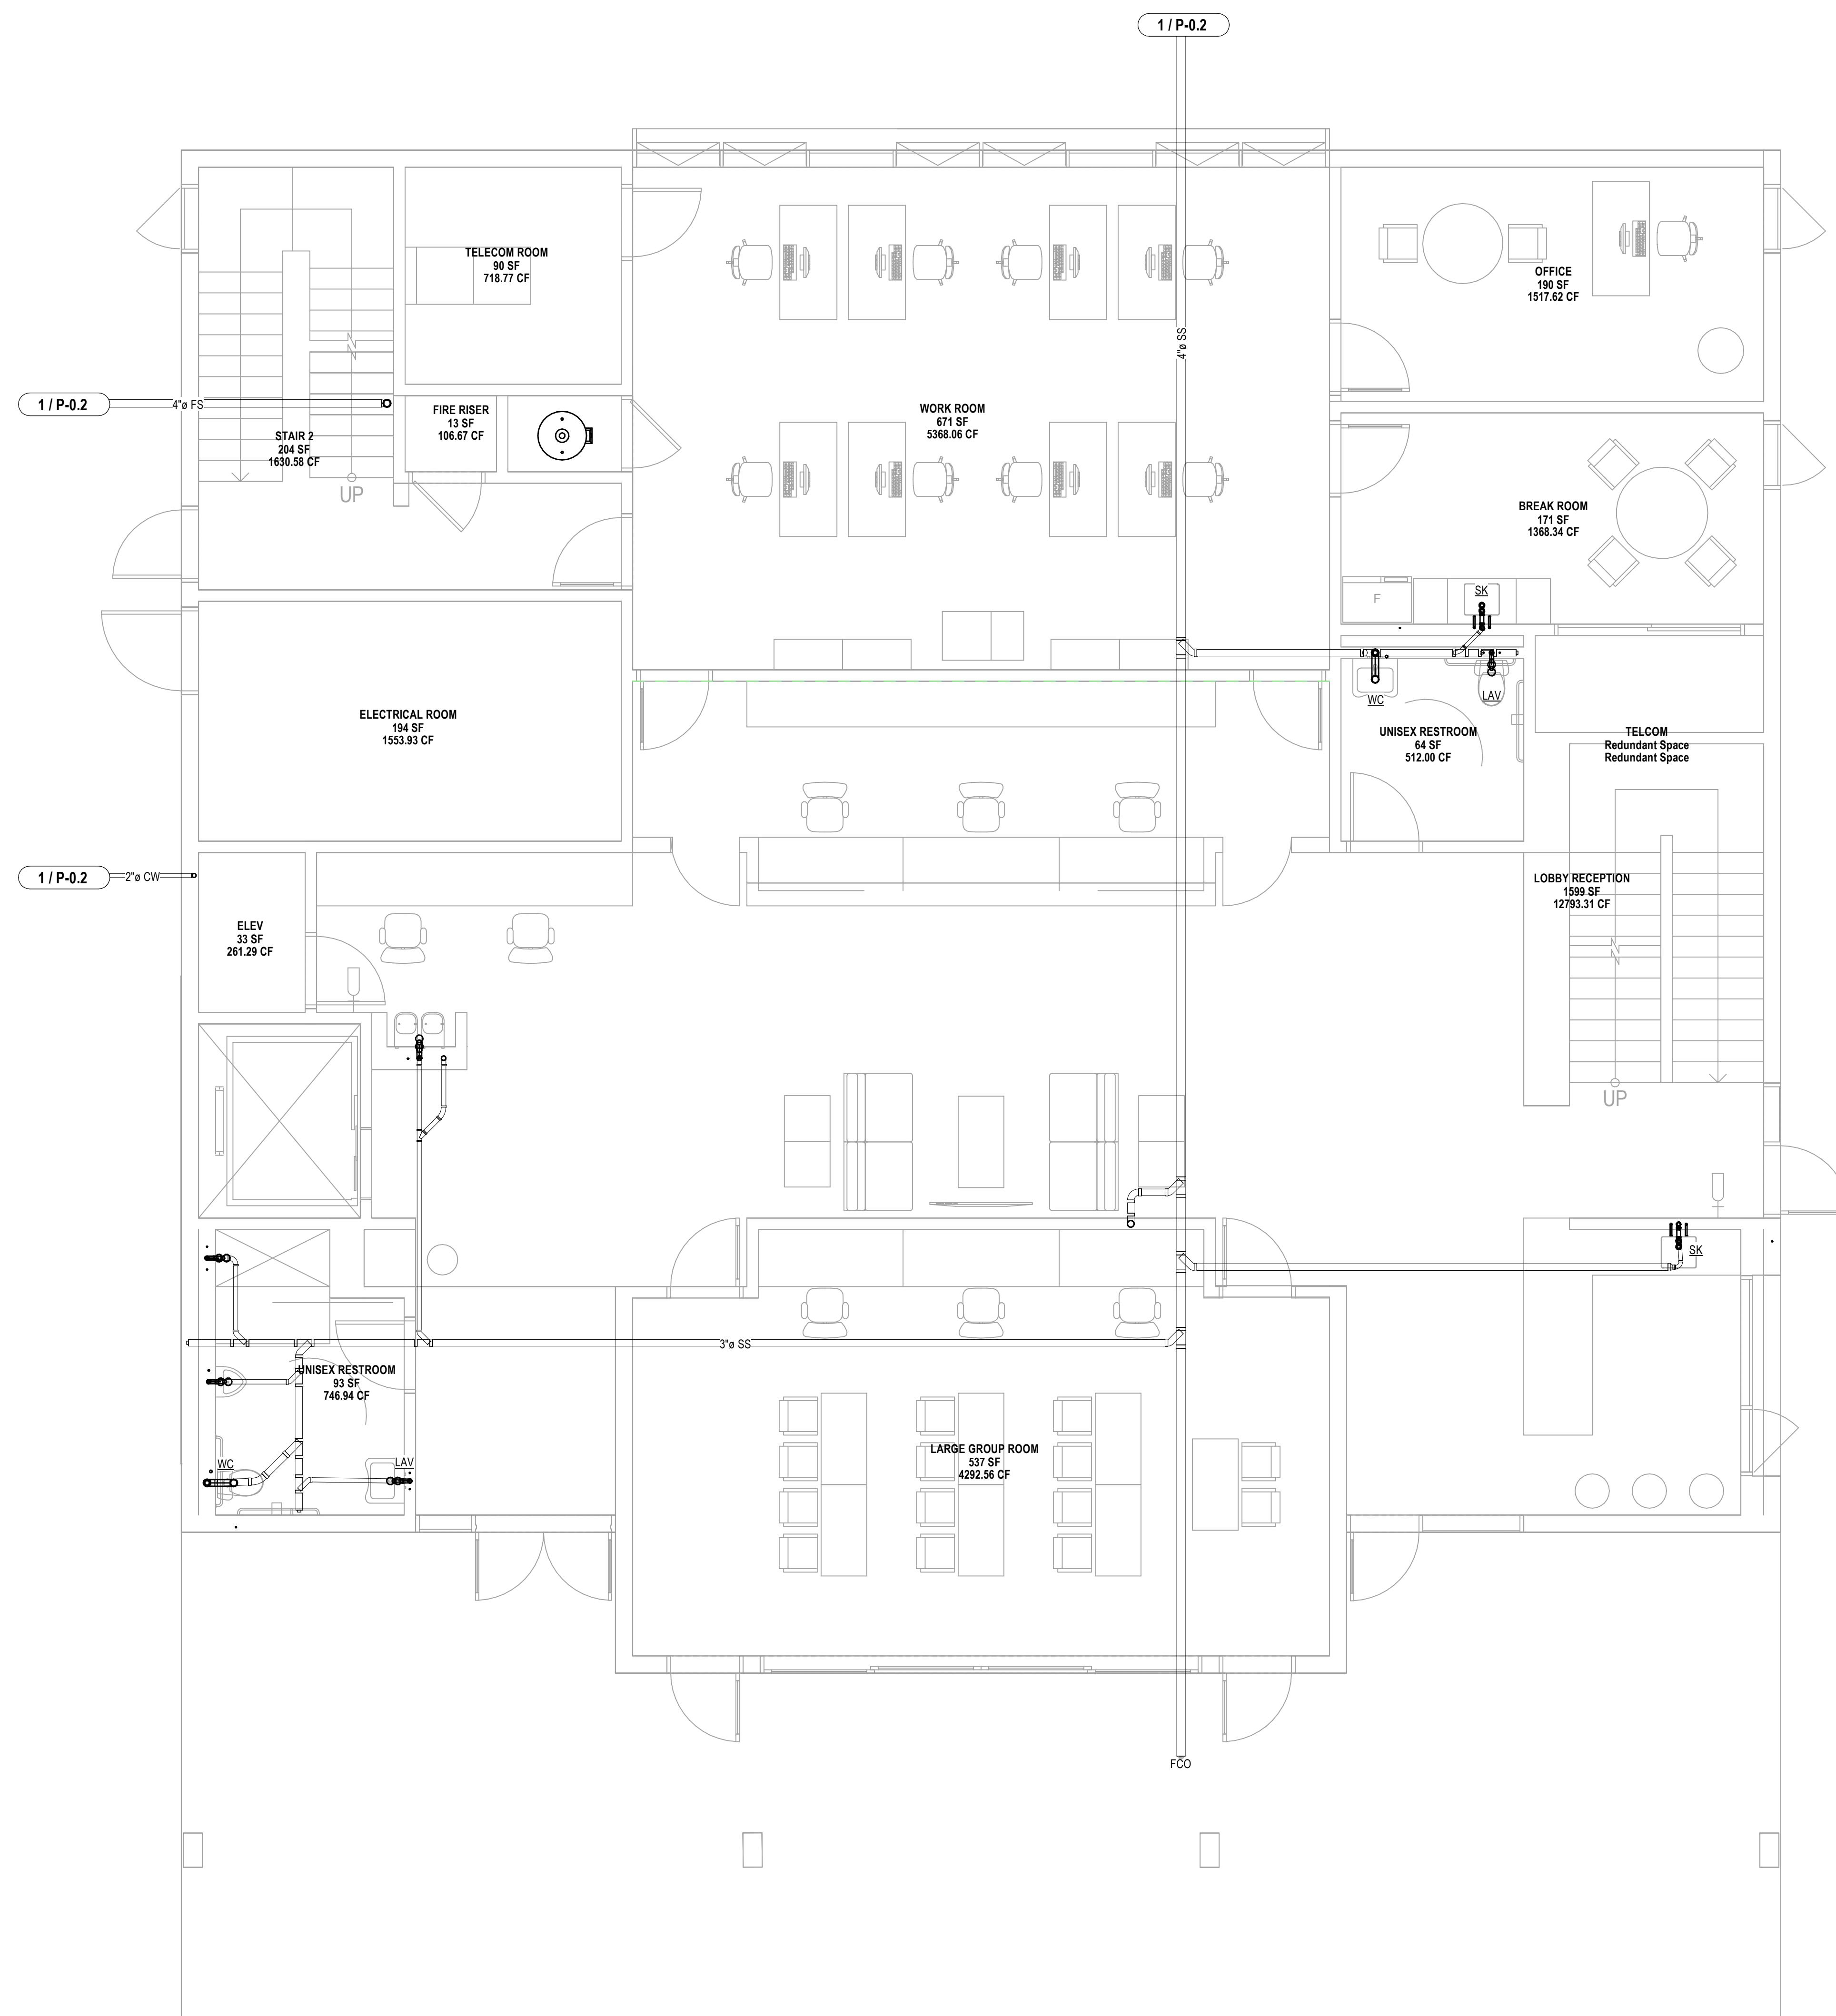
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[illegible]

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PMA PROJECT NO. 23007	
DRAWING TITLE:	
BELOW GROUND	
PLUMBING PLAN	
SCALE:	AS SHOWN
DATE: 02/28/2024	
DRAWN BY:	CHECKED BY:
UK	TP
SHEET NO. <b>D-10</b>	

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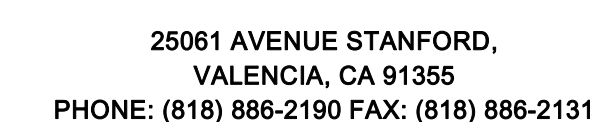
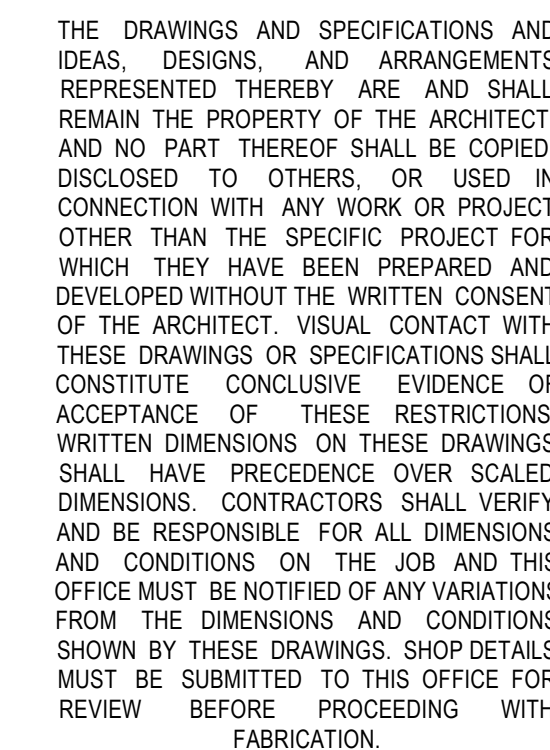


## 1 BELOW GROUND PLUMBING PLAN

$$1/4" = 1'-0"$$

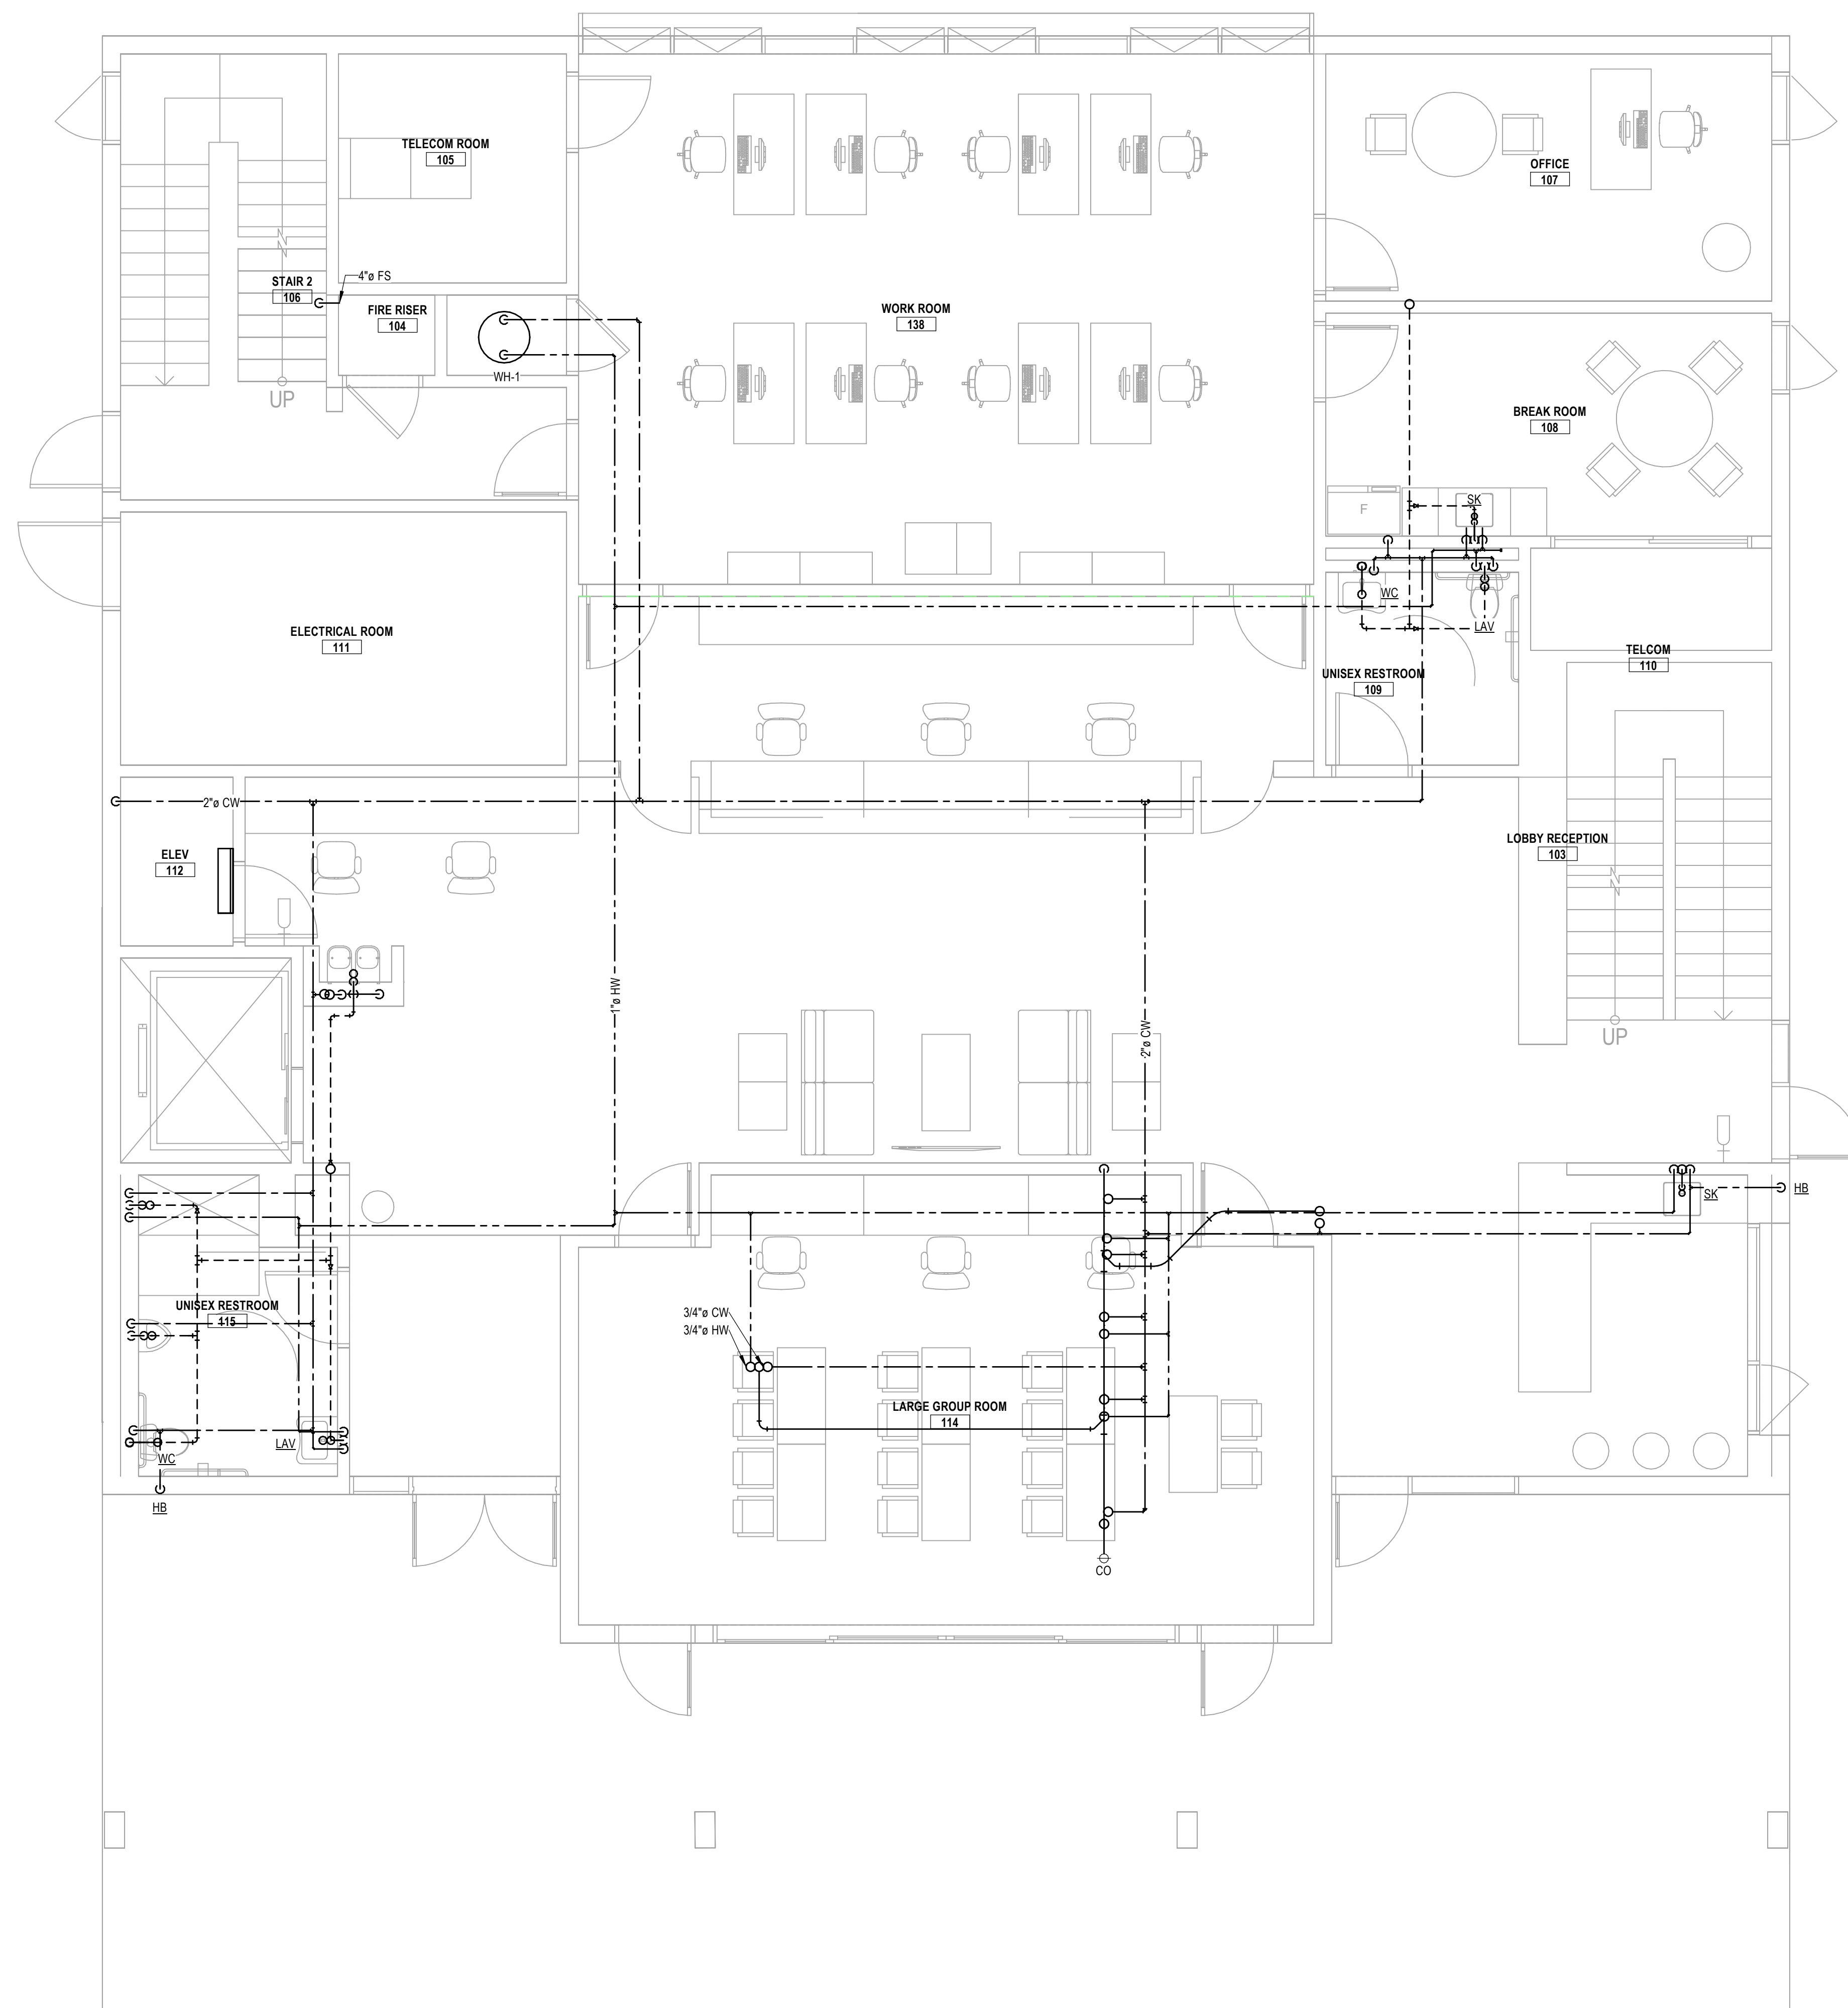


 **NOTE**

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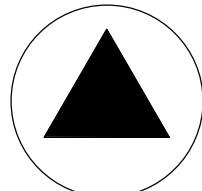
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## 1 1ST FLOOR PLUMBING PLAN







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1 2ND FLOOR PLUMBING PLAN

1/4" = 1'-0"

PROJECT NAME: 23-115		
PROJECT NAME: BCHD allcove		
PROJECT ADDRESS: -		
REV	DESCRIPTION	DATE
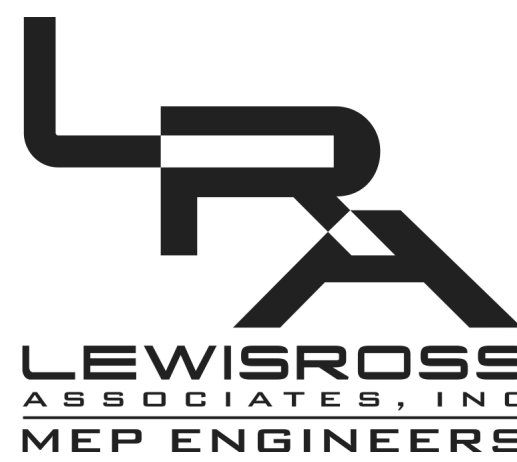
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DRAWING TITLE:

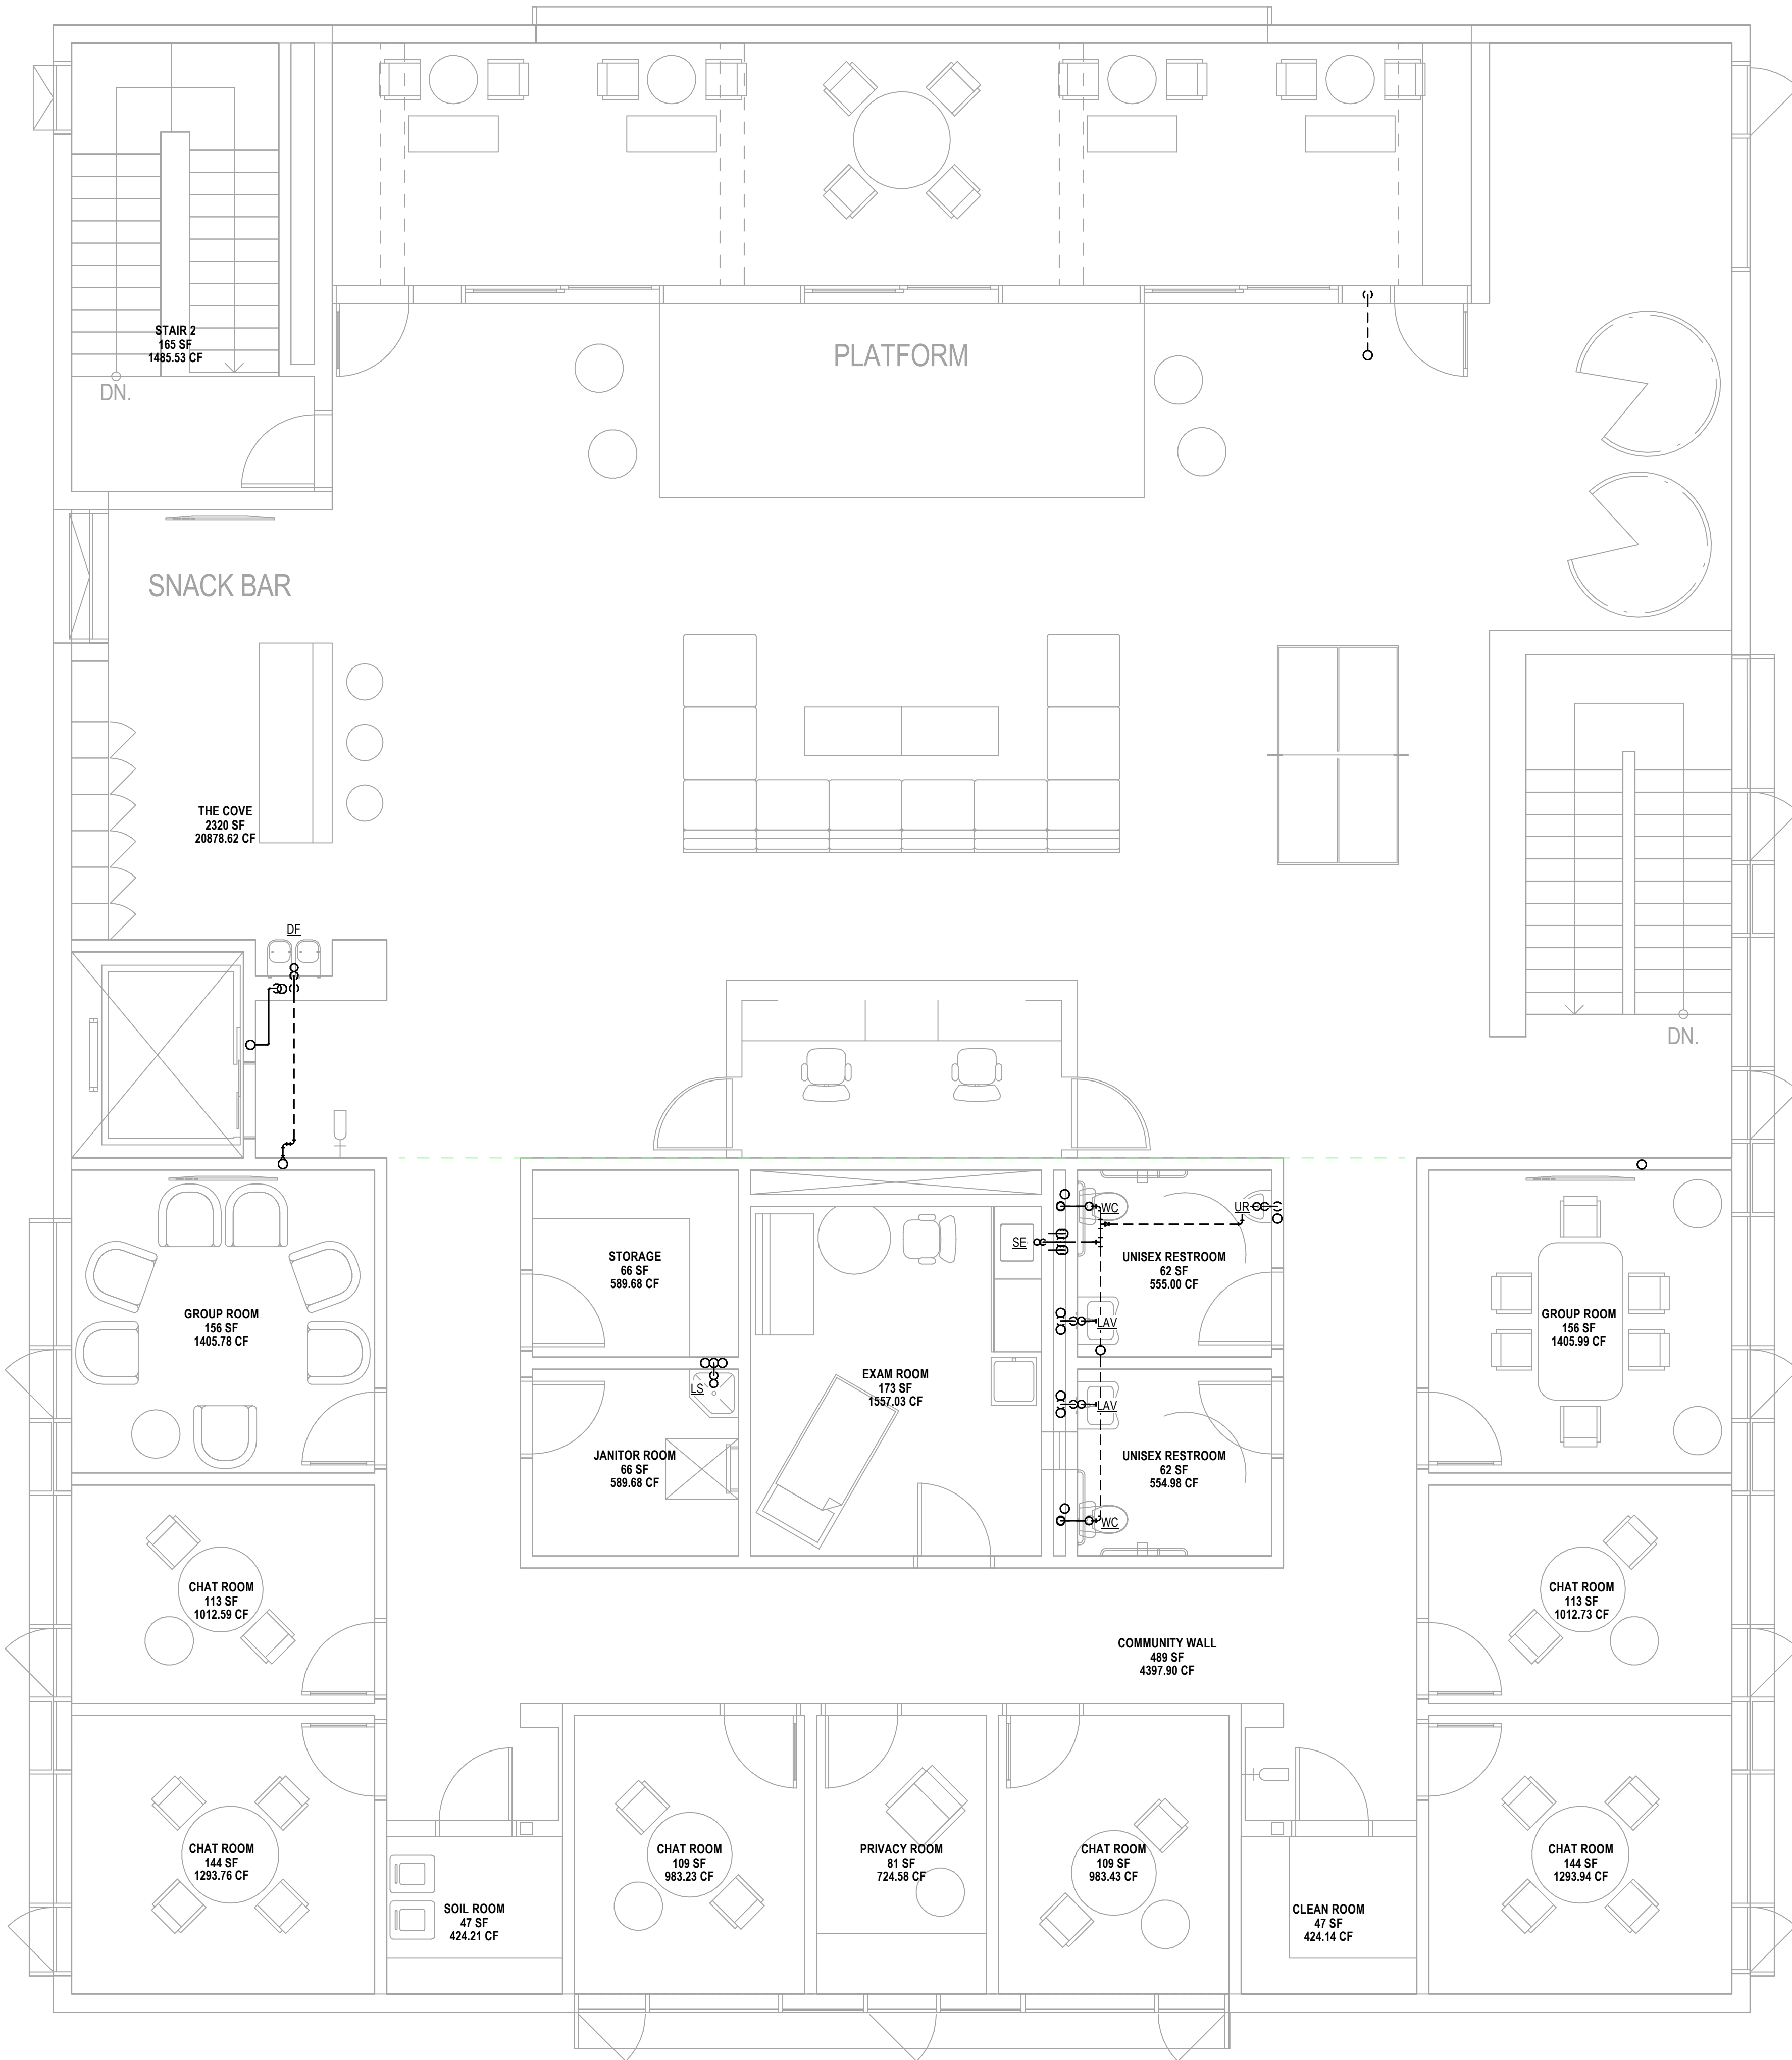SECOND FLOOR  
PLUMBING PLAN

SCALE: AS SHOWN

DATE: 02/28/2024

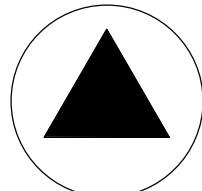
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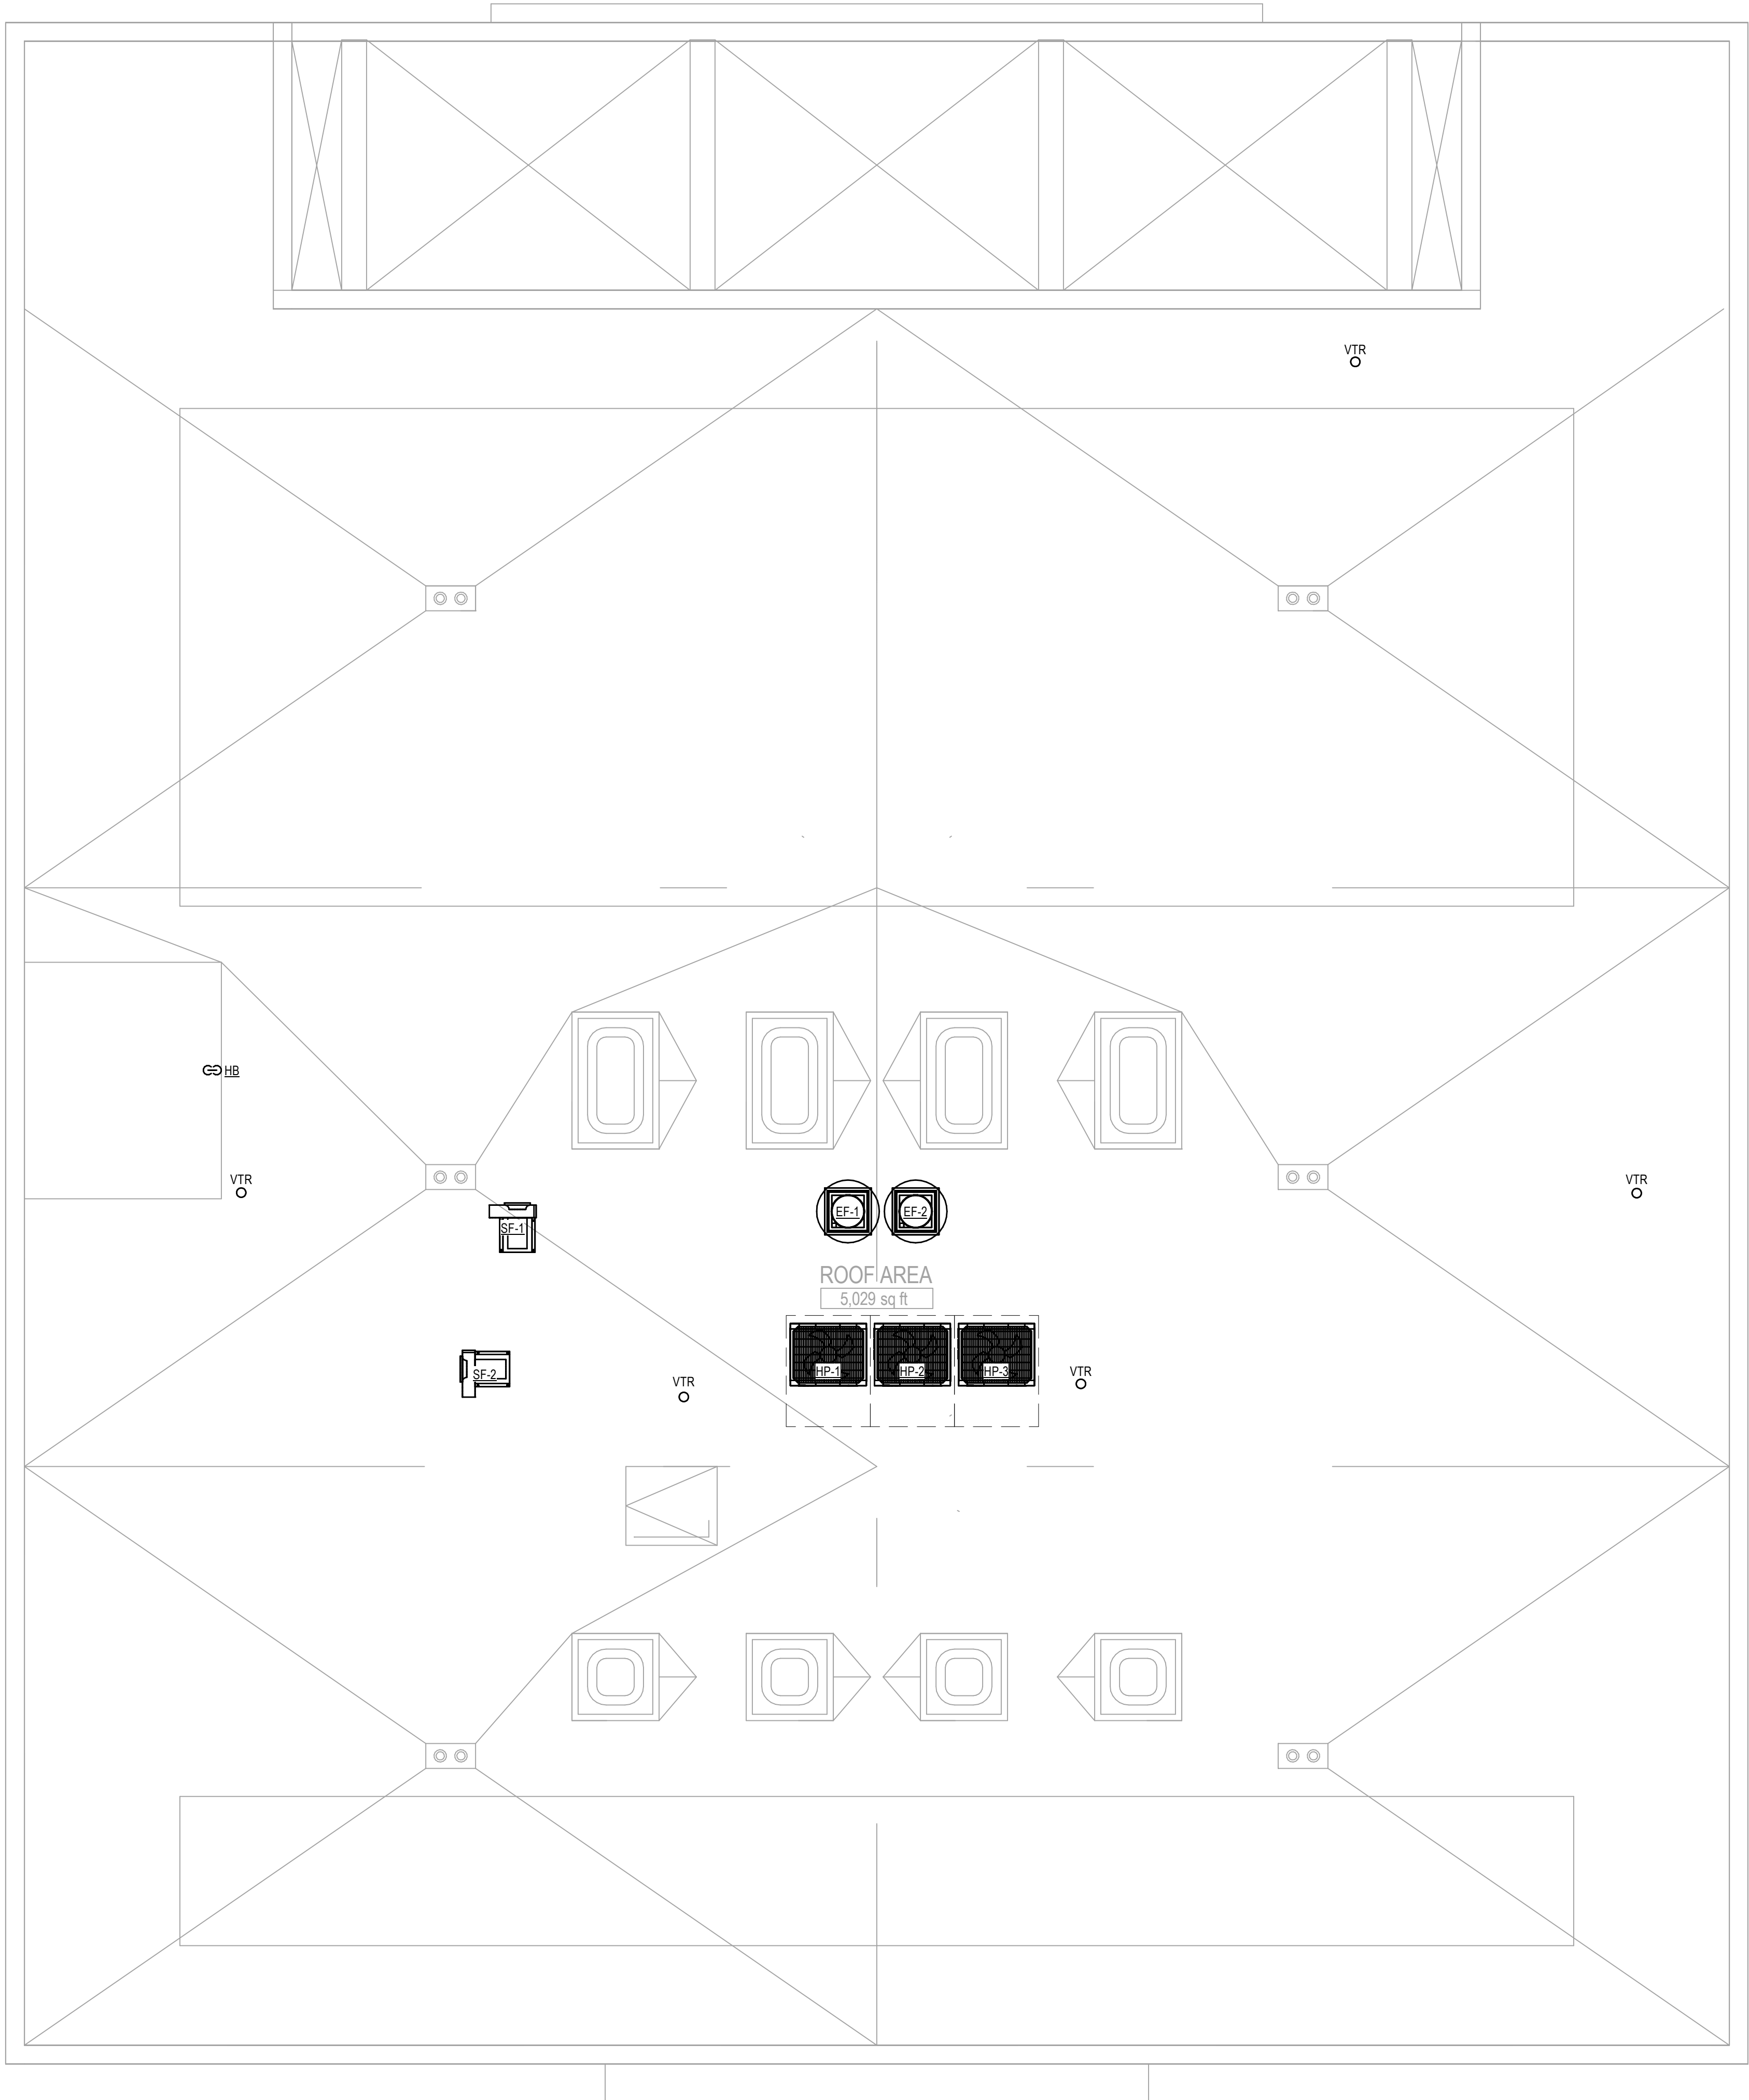
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1 ROOF PLUMBING PLAN

1/4" = 1'-0"

PROJECT NAME: 23-115

PROJECT NAME: BCHD allcove

PROJECT ADDRESS: -

REV	DESCRIPTION	DATE
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BEACH CITIES  
HEALTH DISTRICT

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PMA PROJECT NO. 23007

DRAWING TITLE:

ROOF PLUMBING PLAN

SCALE: AS SHOWN

DATE: 02/28/2024

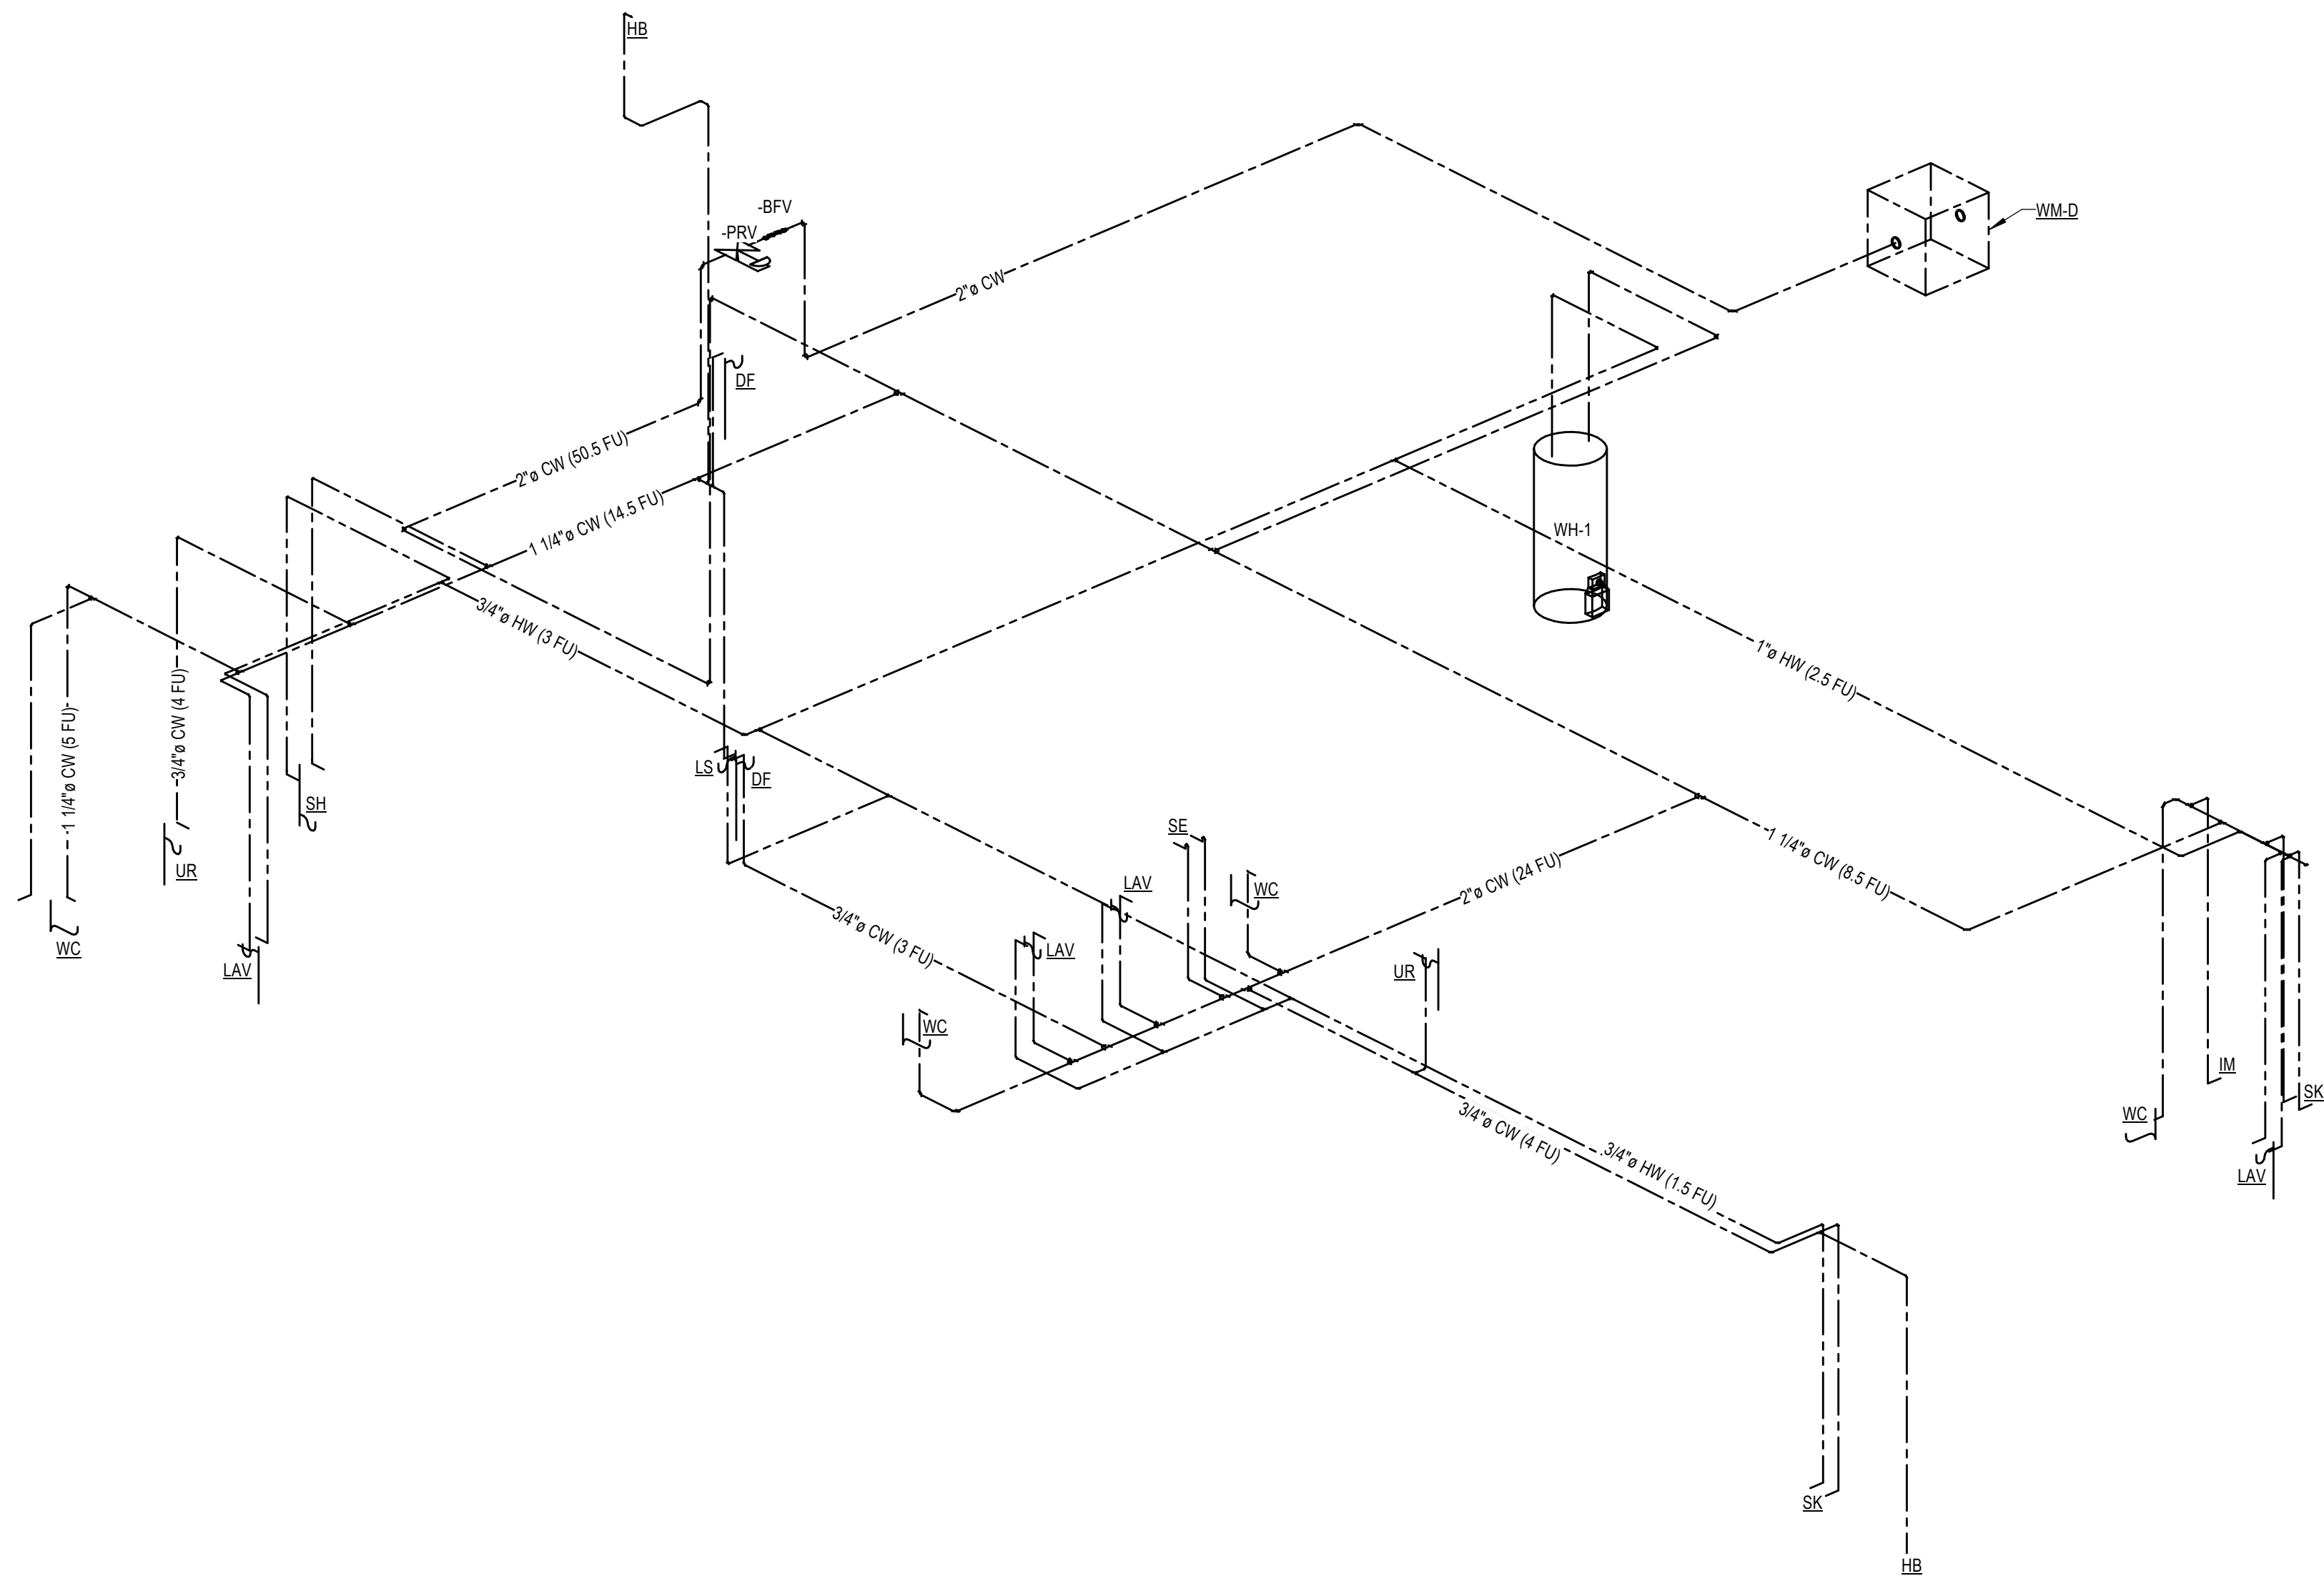
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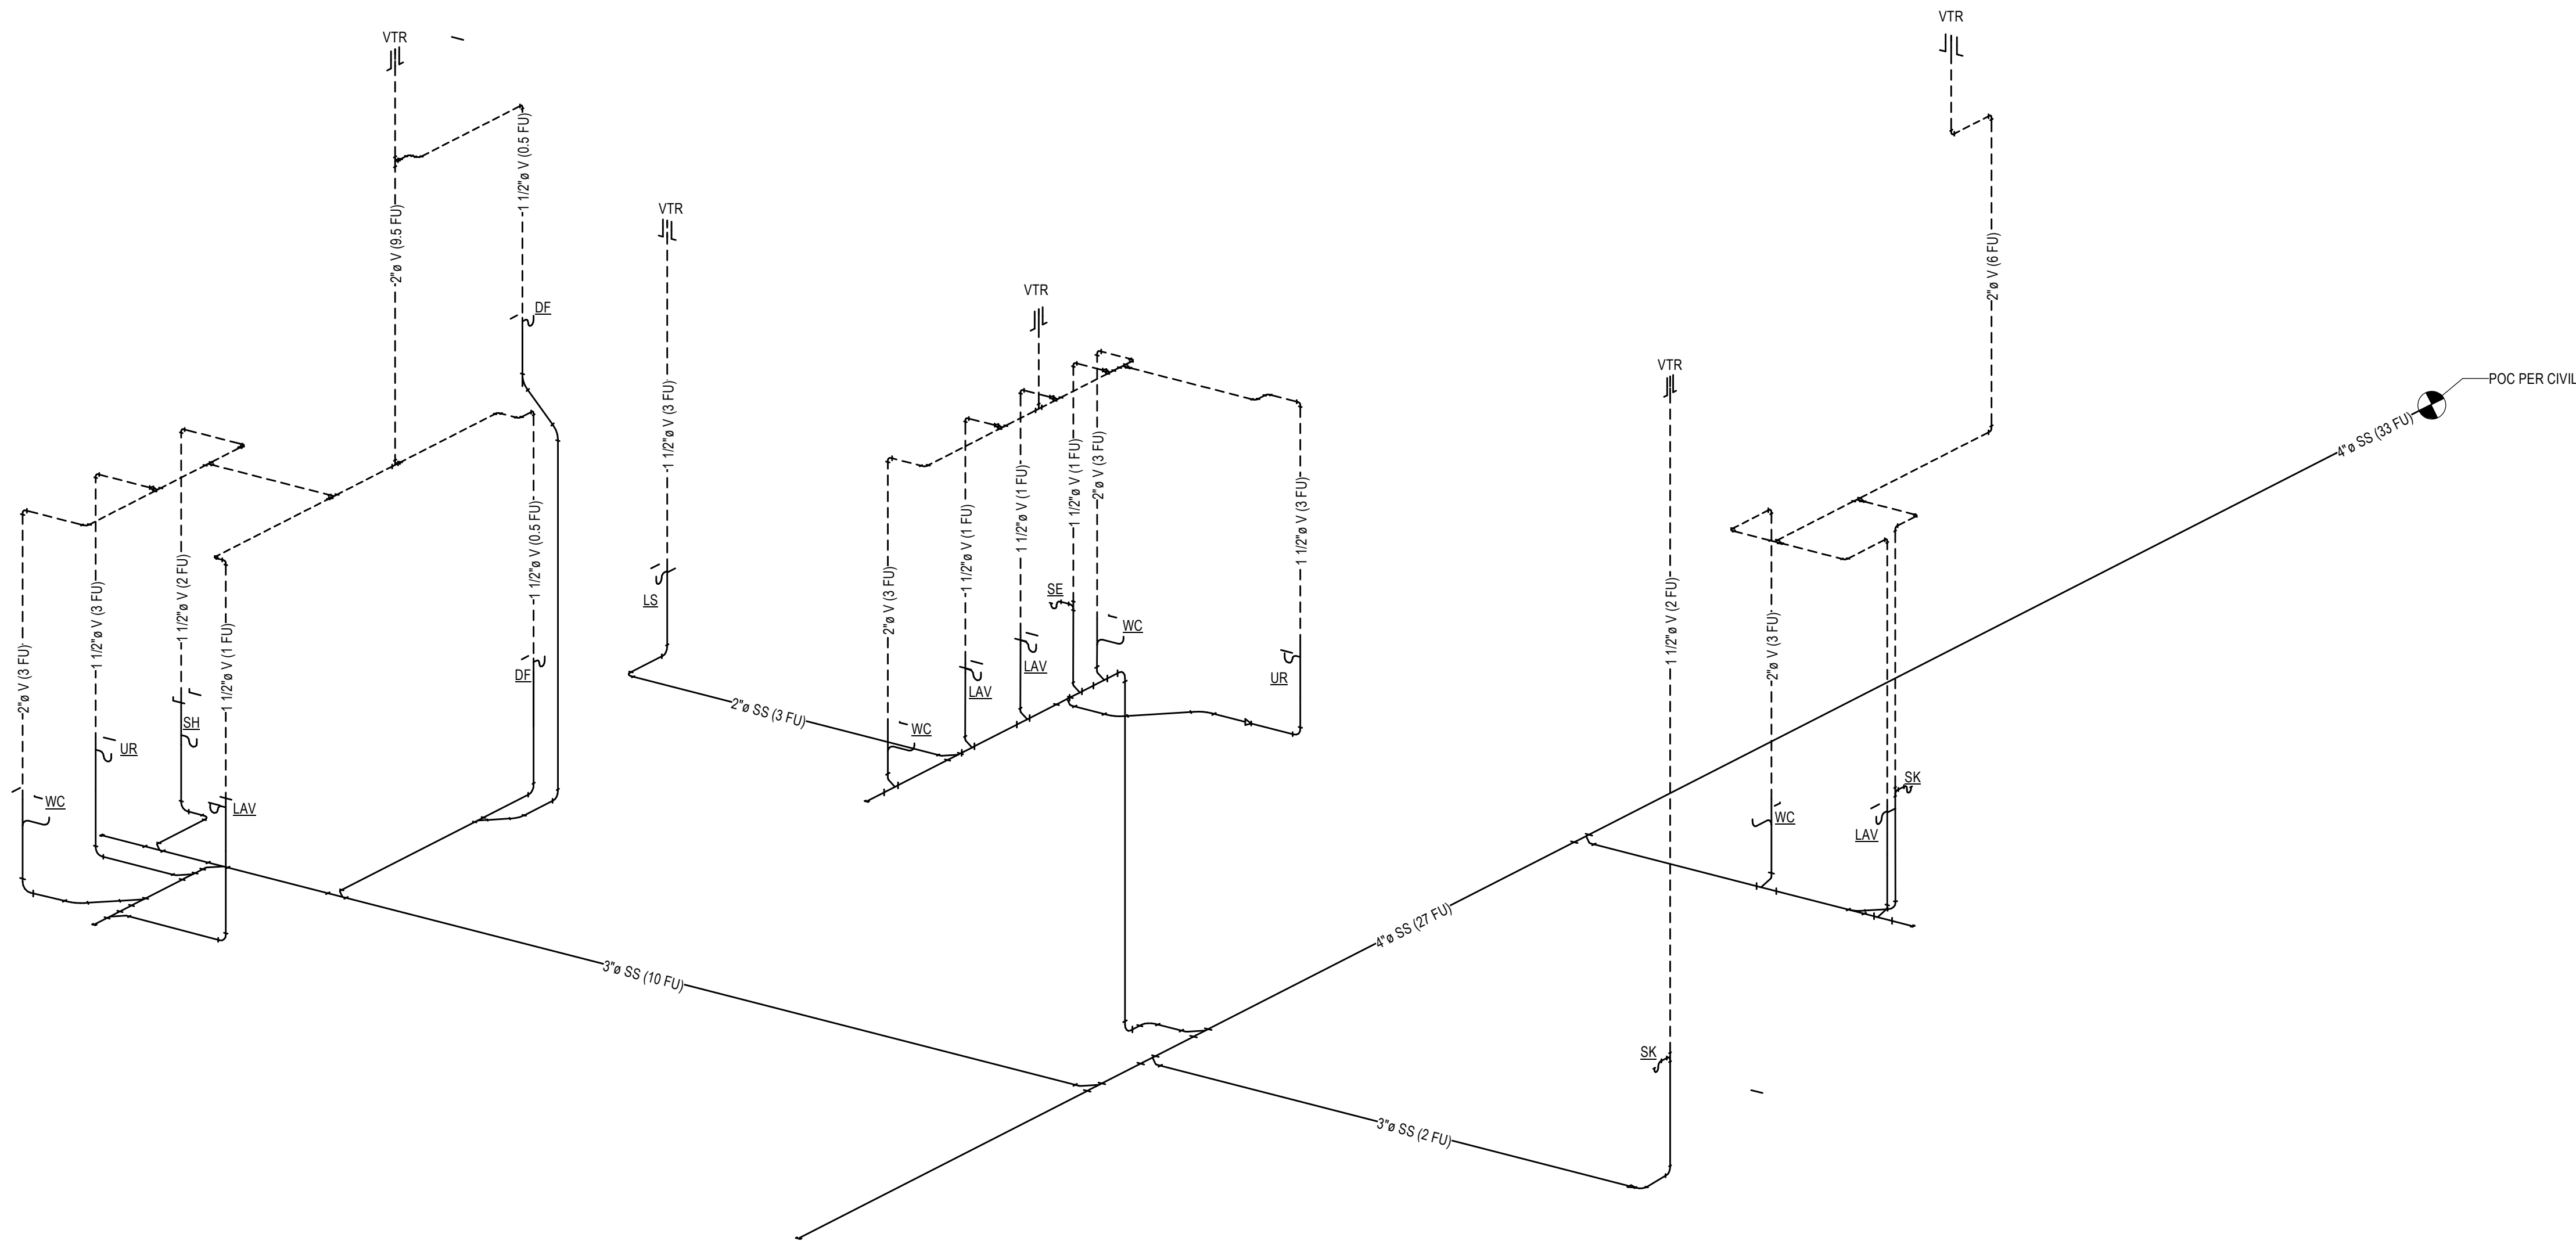
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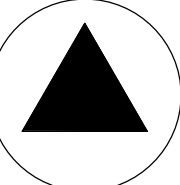




1 H&C WATER RISER DIAGRAM




2 DWV RISER DIAGRAM



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PROJECT NAME: 23-115		
PROJECT NAME: BCHD allcove		
PROJECT ADDRESS: -		
REV	DESCRIPTION	DATE

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BEACH CITIES  
HEALTH DISTRICT

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PMA PROJECT NO. 23007

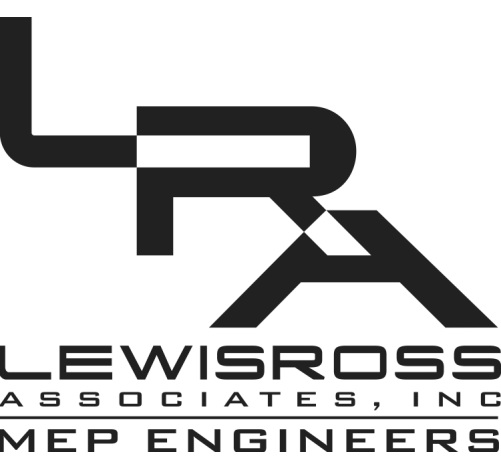DRAWING TITLE:

RISER DIAGRAMS

SCALE: AS SHOWN

DATE: 02/28/2024

DRAWN BY: CHECKED BY:

UK TP

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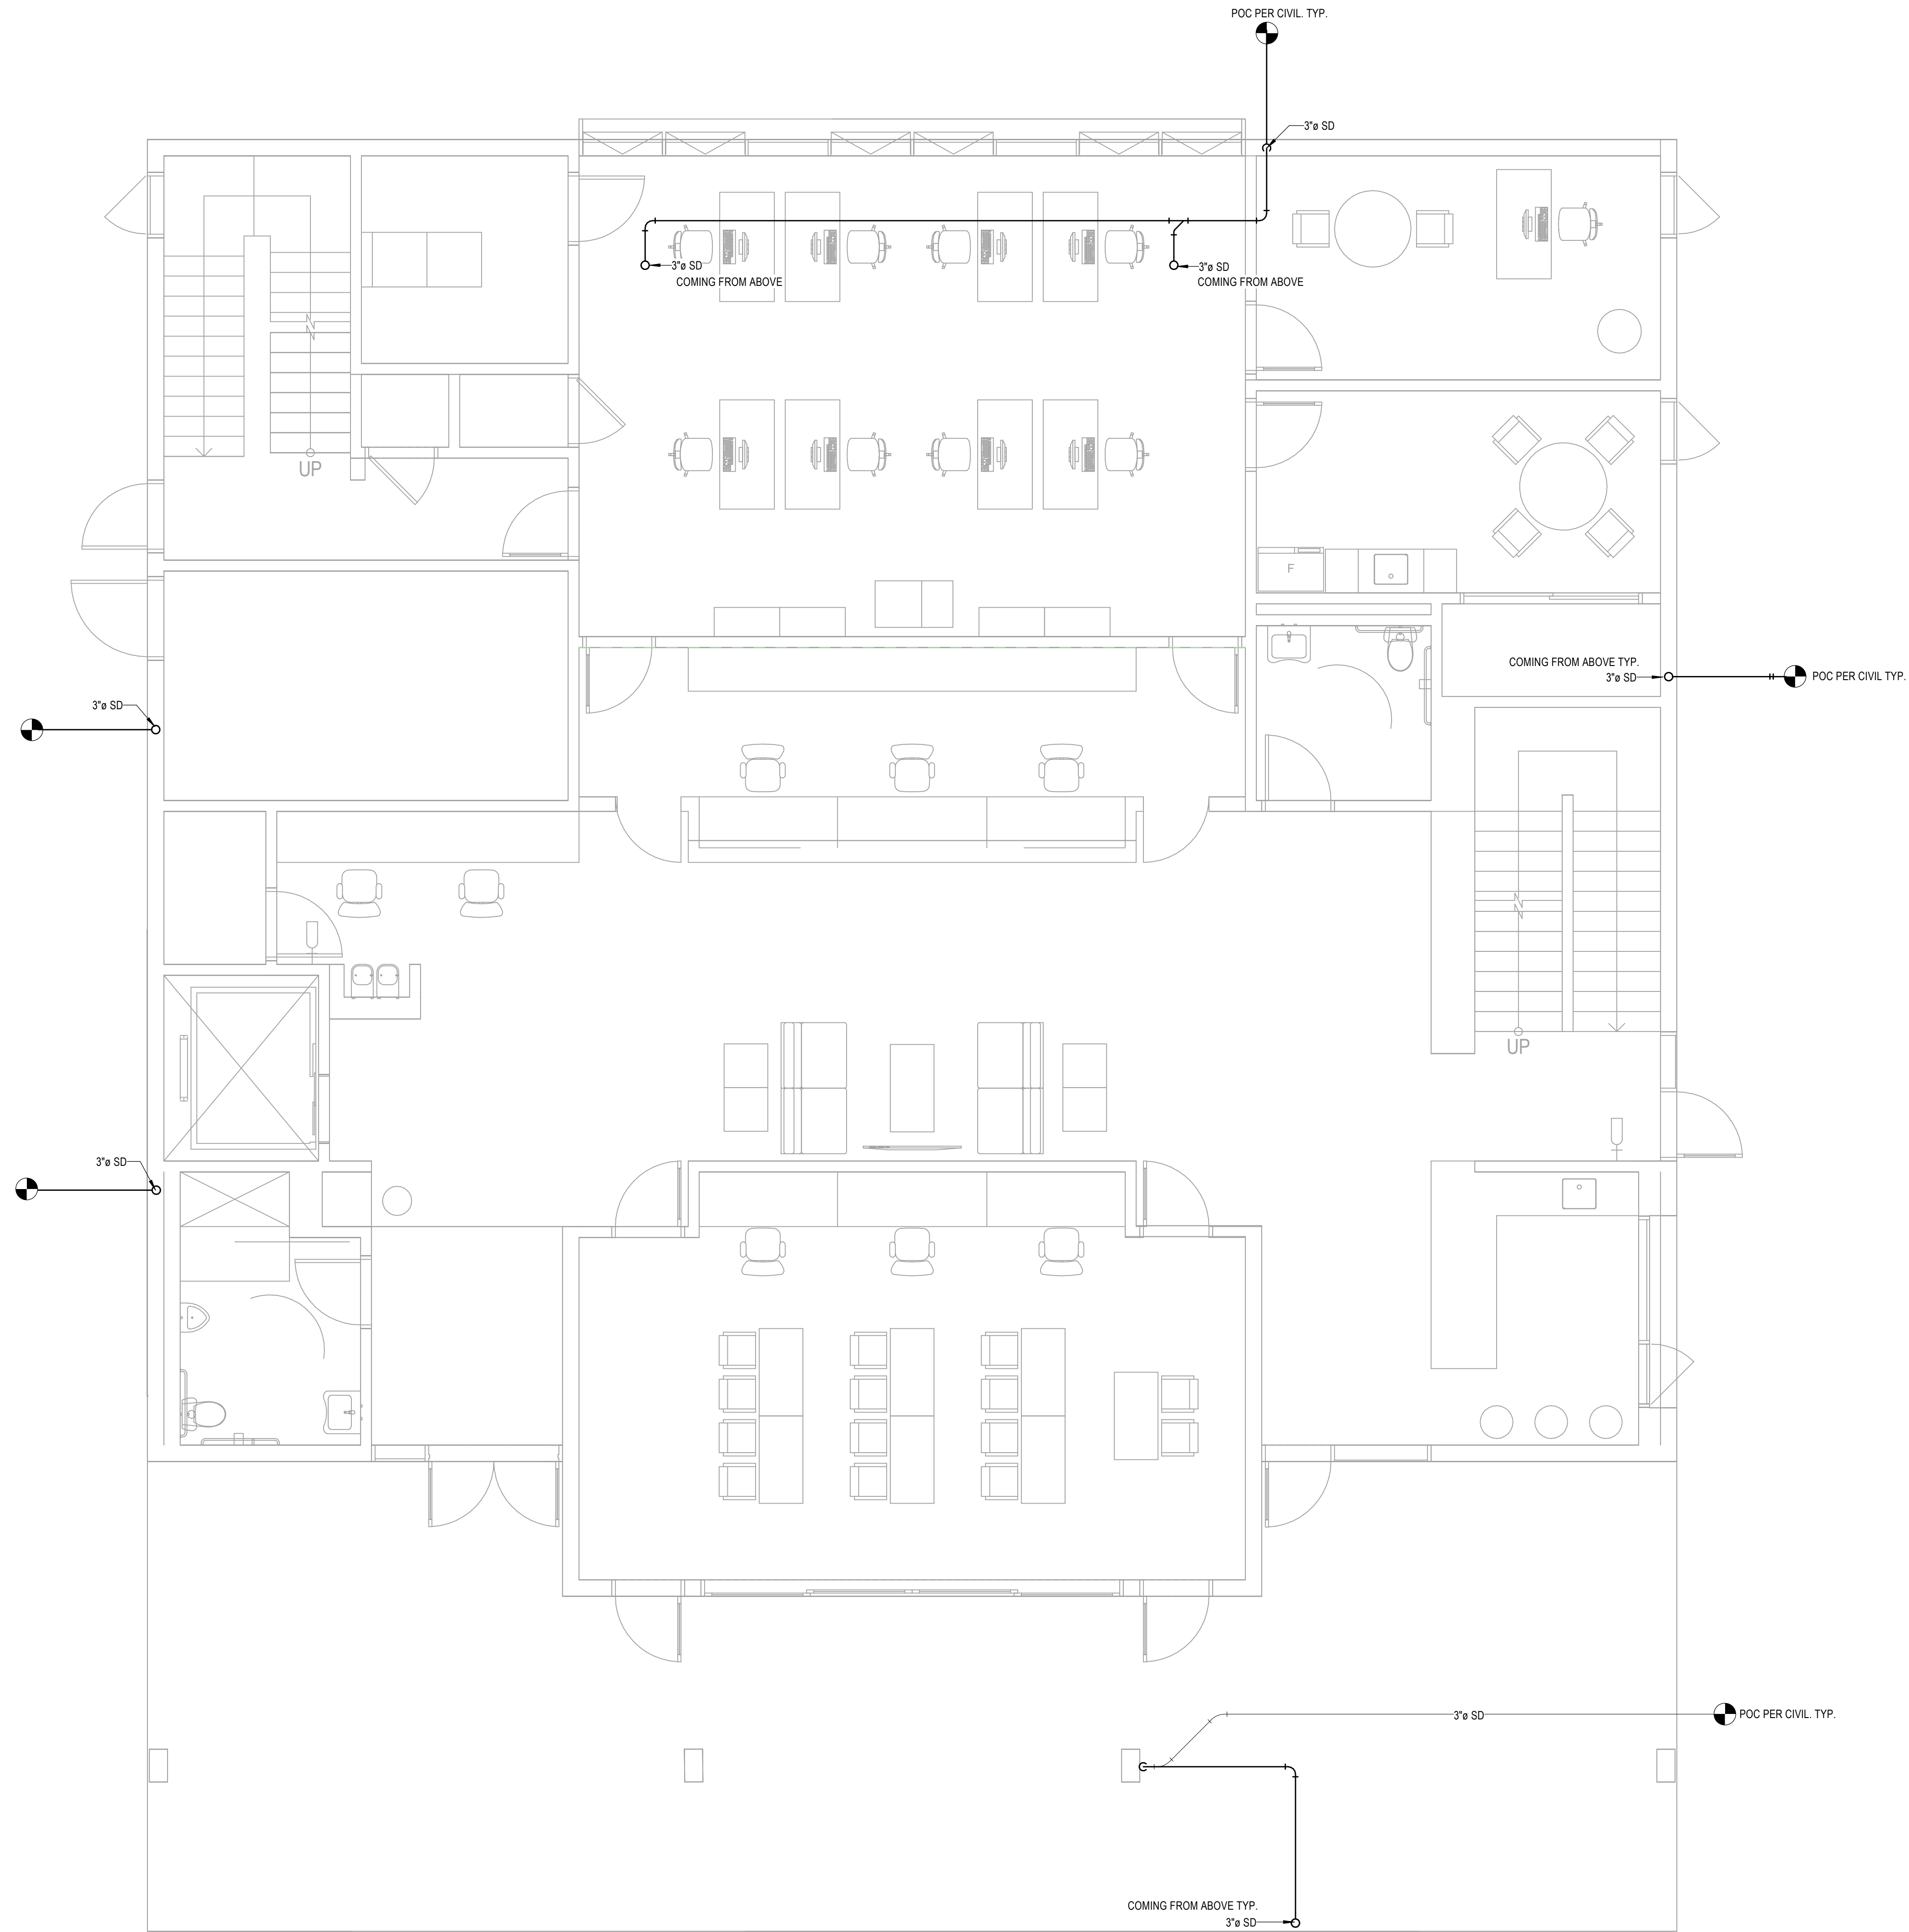


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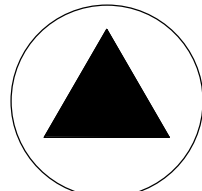
KEYNOTES PLUMBING

# NOTE



1 1ST FLOOR STORM WATER PLAN

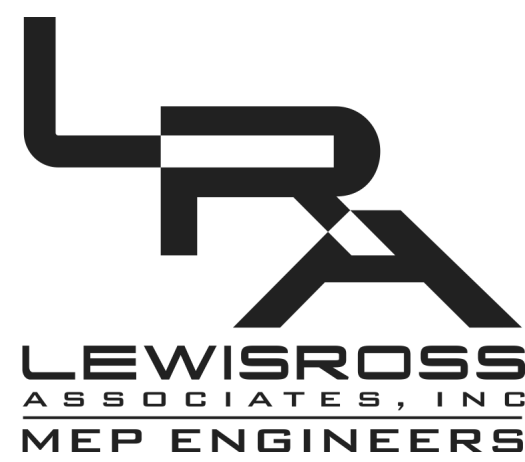
1/4" = 1'-0"



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PROJECT NAME: 23-115  
PROJECT NAME: BCHD allcove  
PROJECT ADDRESS: -

REV	DESCRIPTION	DATE

**allcove**  
BEACH CITIES  
HEALTH DISTRICT

100% PRELIMINARY DESIGN SUBMITTAL

PMA PROJECT NO. 23007

DRAWING TITLE:

FIRST FLOOR STORM  
WATER DRAINAGE PLAN

SCALE: AS SHOWN

DATE: 02/28/2024

DRAWN BY:

UK

CHECKED BY:

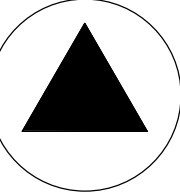
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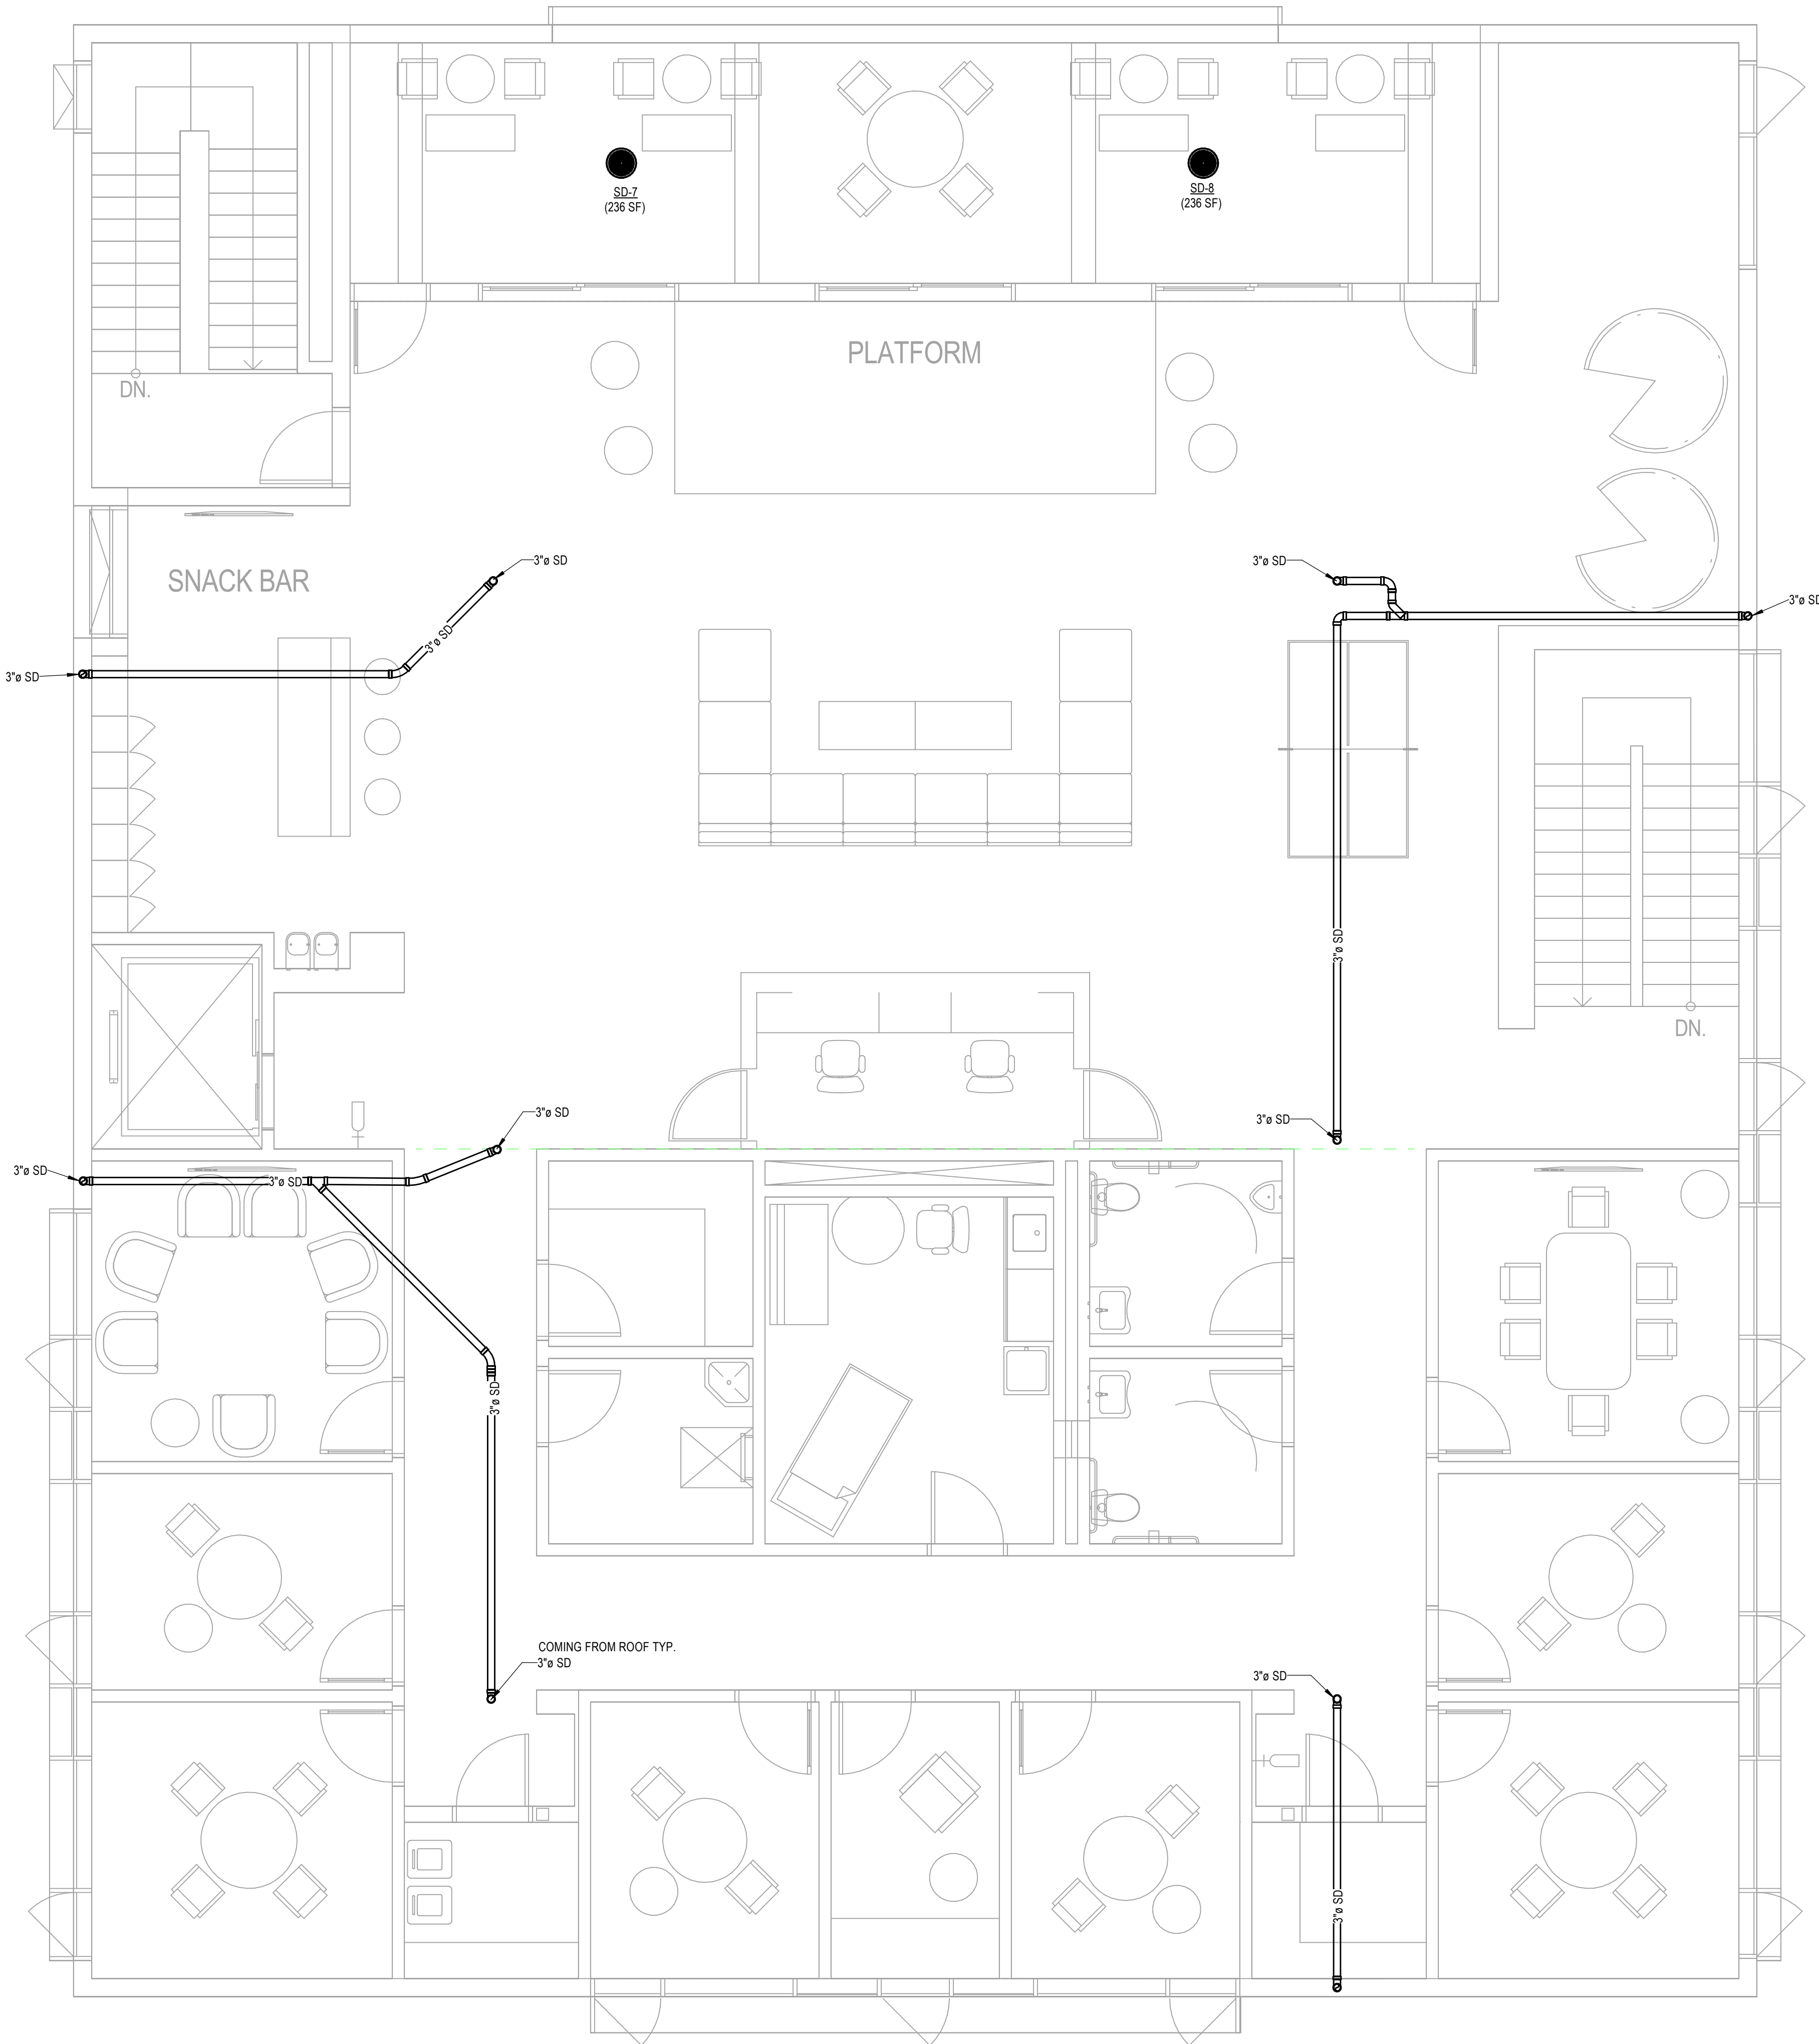
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1 2ND FLOOR STORM WATER PLAN

1/4" = 1'-0"

PROJECT NAME: 23-115

PROJECT NAME: BCHD allcove

PROJECT ADDRESS: -

REV	DESCRIPTION	DATE
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PMA PROJECT NO. 23007

DRAWING TITLE:

SECOND FLOOR STORM  
WATER DRAINAGE PLAN

SCALE: AS SHOWN

DATE: 02/28/2024

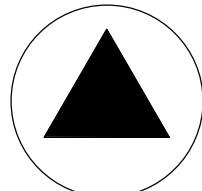
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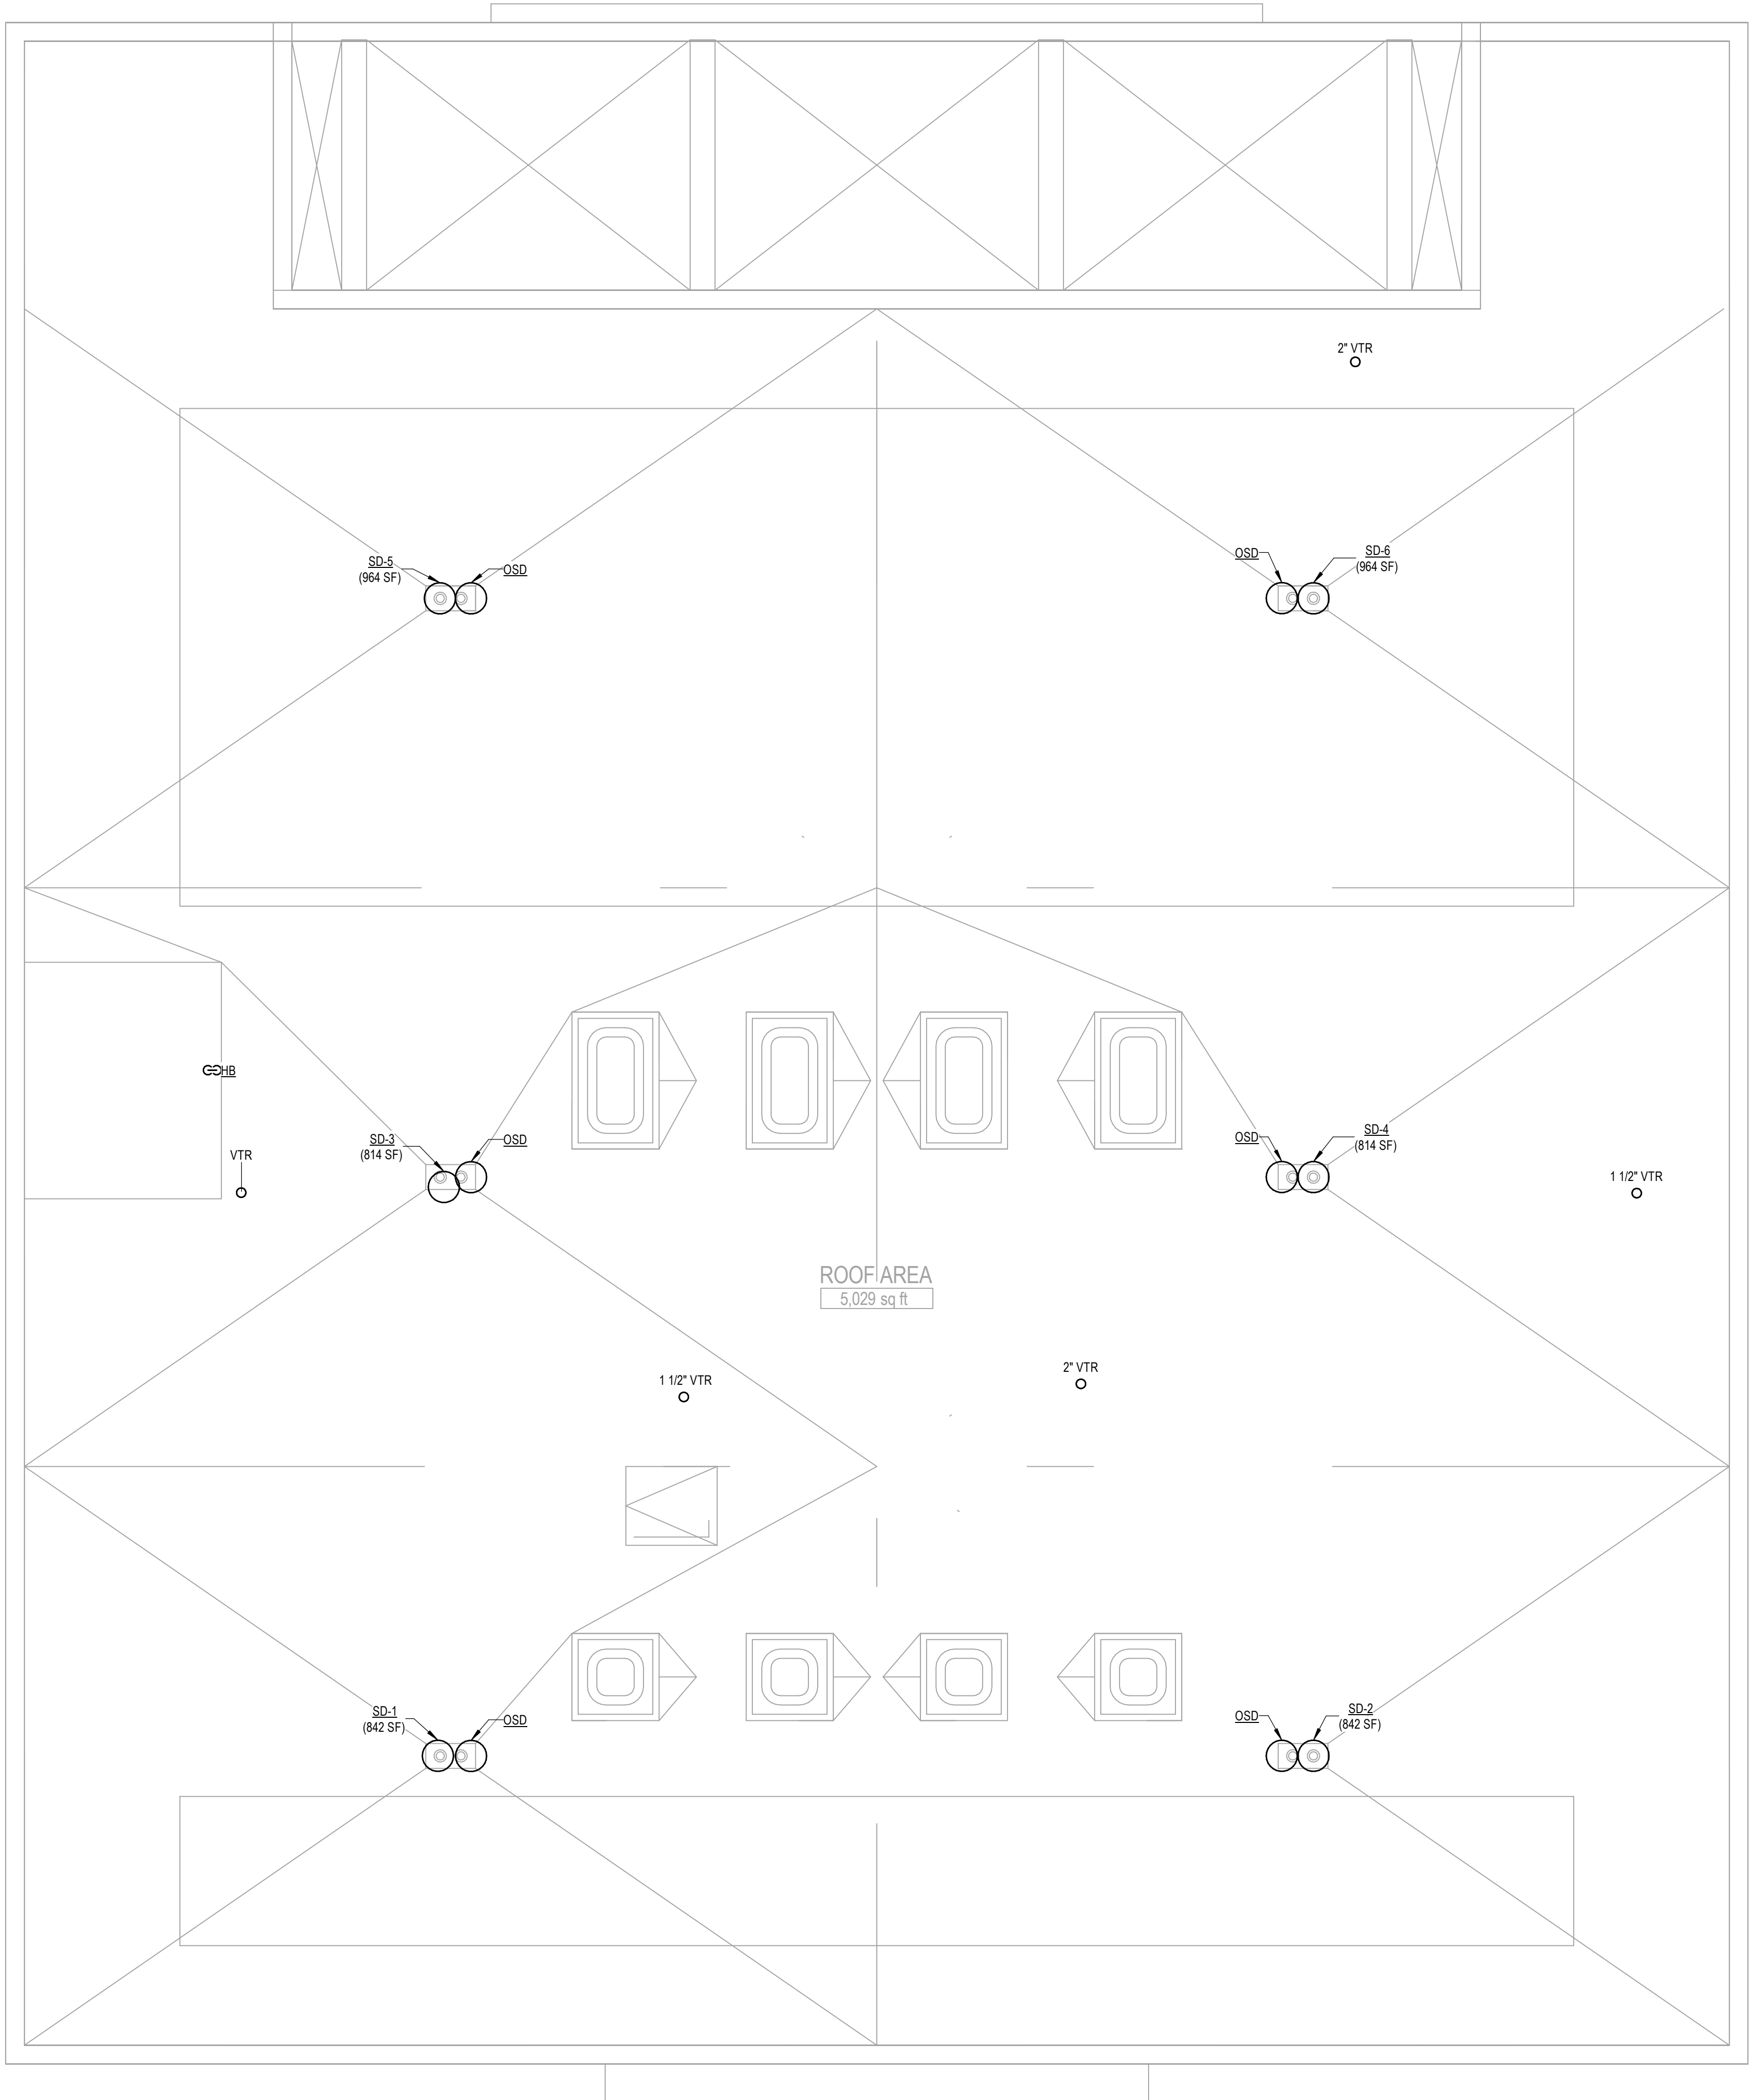
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1 ROOF STORM WATER PLAN  
1/4" = 1'-0"

PROJECT NAME: 23-115		
PROJECT NAME: BCHD allcove		
PROJECT ADDRESS: -		
REV	DESCRIPTION	DATE

allcove  
BEACH CITIES  
HEALTH DISTRICT

100% PRELIMINARY DESIGN SUBMITTAL

PMA PROJECT NO. 23007

DRAWING TITLE:

ROOF STORM WATER  
PLAN

SCALE: AS SHOWN

DATE: 02/28/2024

DRAWN BY: UK CHECKED BY: TP

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DATE: 27 February 2024  
DRAWING FILENAME: 23-727 E100  
DRAFTER: CW01  
PATHNAME: G:\23\727\EL\Sheets  
TIME: 3:34 pm

GENERAL NOTES

- A. GENERAL
1. SCOPE  
THE DRAWINGS AND THESE GENERAL NOTES DESCRIBE THE SCOPE OF WORK AND SYSTEMS. THE MATERIAL REQUIRED FOR THE WORK SHALL BE CONTRACTOR FURNISHED AND CONTRACTOR INSTALLED, UNLESS SPECIFICALLY NOTED OTHERWISE. THE WORK INCLUDES BUT IS NOT LIMITED TO THE FOLLOWING PRINCIPAL SYSTEMS AND EQUIPMENT. ALL ITEMS NOTED ON THE PLAN WHICH ARE NOT EXPLICITLY STATED AS EXISTING SHALL BE NEW.
2. PERMITS AND CHARGES  
OBTAIN AND PAY FOR ALL NECESSARY CONSTRUCTION PERMITS, INSPECTION FEES, AND OTHER CHARGES BY AGENCIES HAVING JURISDICTION.
3. REGULATIONS AND CODES  
PROVIDE AND INSTALL ALL MATERIALS IN CONFORMANCE WITH THE 2022 C.E.C., CALIFORNIA ADMINISTRATIVE CODE TITLE 8, AND OTHER CODES AND REGULATIONS HAVING JURISDICTION. INSTALL ALL EQUIPMENT IN ACCORDANCE WITH THE REQUIREMENTS OF THE INSPECTING AUTHORITY AND THE MANUFACTURERS RECOMMENDATIONS.
4. VERIFYING EXISTING CONDITIONS  
BEFORE SUBMITTING BID, BECOME THOROUGHLY FAMILIAR WITH ACTUAL EXISTING CONDITIONS AT THE BUILDING. THE INTENT OF THE WORK IS SHOWN ON THE DRAWINGS AND DESCRIBED HEREINAFTER. BY THE ACT OF SUBMITTING A BID PROPOSAL FOR THE WORK, THE CONTRACTOR SHALL BE DEEMED TO HAVE MADE SUCH STUDY AND EXAMINATION AND TO ACCEPT ALL CONDITIONS PRESENT AT THE SITE. NO REQUEST FOR ADDITIONAL PAYMENT WILL BE CONSIDERED AS VALID, DUE TO FAILURE TO ALLOW FOR CONDITIONS WHICH MAY EXIST.
5. COORDINATION  
COORDINATE ALL WORK WITH OTHER TRADES. OBTAIN ALL DRAWINGS THAT WILL REQUIRE COORDINATION AND PROVIDE ALL ELECTRICAL CONNECTION REQUIRED WHETHER SHOWN ON ELECTRICAL DRAWINGS OR NOT. ELECTRICAL EQUIPMENT LOCATIONS INDICATED ARE SHOWN DIAGRAMMATICALLY, EXACT LOCATION SHALL BE VERIFIED. SCALING OFF OF DRAWINGS SHALL BE DONE AT CONTRACTORS RISK. DO NOT SCALE DEVICES OR ANY EQUIPMENT FROM PLANS. LIGHTING FIXTURE QUANTITIES AND LENGTHS SHALL BE CONTRACTORS RESPONSIBILITY. FIXTURES ARE SHOWN FOR CIRCUITING ONLY. CONTRACTOR TO VERIFY SIZES & QUANTITIES PRIOR TO BID.
6. SERVICE CONTINUITY  
UNINTERRUPTED EXISTING ELECTRICAL POWER SHALL BE MAINTAINED TO OTHER TRADES FOR TEMPORARY POWER AREAS OF THE SITE DURING CONSTRUCTION. PROVIDE ANY TEMPORARY SERVICES AS MAY BE REQUIRED. IDENTIFY AT BID TIME, ALL WORK TO BE DONE ON PREMIUM TIME AND THE TOTAL OVERTIME MAN-HOURS REQUIRED FOR COMPLETION.
7. AS BUILT  
PROVIDE RECORD DRAWINGS IN ACAD TO THE OWNER WITH ALL CHANGES NOTED THEREON AT THE COMPLETION OF THE PROJECT. RECORD DRAWINGS SHALL BE SIGNED AND DATED BY CONTRACTOR PRIOR TO RELEASE OF FINAL RETENTION OF ALL MONIES.
8. GUARANTEE  
CONTRACTOR SHALL UNCONDITIONALLY GUARANTEE ALL LABOR AND MATERIALS ON ALL WORK AGAINST DEFECTS IN WORKMANSHIP AND MATERIALS FOR A PERIOD OF ONE YEAR.
9. SHOP DRAWINGS  
SUBMIT SHOP DRAWINGS AND MATERIAL LIST FOR REVIEW PRIOR TO COMMENCING ANY WORK. ALL EQUIPMENT TO BEAR U.L. LABEL OR THAT OF ANOTHER ACCEPTABLE TESTING LABORATORY. SHOP DRAWINGS MUST BE STAMPED BY THE CONTRACTOR FOR CONFORMANCE PRIOR TO SUBMITTAL. SUBMIT THREE HARD COPY SETS OF SHOP DRAWINGS FOR REVIEW PRIOR TO PURCHASING ALL BREAKER MOUNTING HARDWARE, DISCONNECT SWITCHES, FUSES, CONTROLLERS, LIGHTING FIXTURES, LIGHT SWITCHES, RECEPTACLES, ETC.
10. CONTRACTOR BID  
CONTRACTORS BID SHALL BE BASED ON ALL WORK SHOWN ON THE PLANS AND AS SPECIFIED. IF CONTRACTOR PROPOSES TO SUBSTITUTE FOR EQUIPMENT SPECIFIED, HE SHALL SUBMIT HIS REQUEST FOR CONSIDERATION OF THE OWNER AND ENGINEER PRIOR TO BID IN WRITING. ALL SUBSTITUTIONS MUST BE REVIEWED BY THE ENGINEER IN WRITING. SUCH REVIEW SHALL NOT RELIEVE THE CONTRACTOR COMPLYING WITH THE REQUIREMENTS OF THE DRAWINGS AND SPECIFICATIONS, AND THE CONTRACTOR SHALL BE RESPONSIBLE AT HIS OWN EXPENSE FOR ANY CHARGES RESULTING FROM HIS PROPOSED SUBSTITUTIONS WHICH AFFECT OTHER PARTS OF HIS OWN WORK, THE OWNER, ENGINEER OF RECORD OR THE WORK OF OTHER CONTRACTORS.
- B. MATERIAL AND INSTALLATION  
ALL WORK AND MATERIAL SHALL CONFORM TO THE LATEST RULES OF THE GOVERNING ELECTRICAL CODE AND INSTALLATION SHALL BE OF THE LATEST INDUSTRY STANDARDS OF WORKMANSHIP.
- ALL INSTALLED MATERIALS AND EQUIPMENT SHALL BE LISTED U.L., NRTL OR LISTED AND APPROVED BY AN APPROVED TESTING LABORATORY.
1. CONDUITS  
CONDUIT SHALL BE EMT, PVC, IMC, RIGID OR FLEXIBLE STEEL TYPE. CONDUIT SHALL BE MANUFACTURED IN ACCORDANCE WITH UL-1. A GROUND WIRE IS REQUIRED IN ALL FLEXIBLE CONDUIT AND UNDERGROUND CONDUIT. BUSHINGS SHALL BE INSTALLED ON ALL COMMUNICATION, TELEPHONE & SPEAKER CONDUITS. PROVIDE 3/16" NYLON PULL STRING IN ALL EMPTY CONDUITS. ALL EMT CONNECTIONS SHALL BE COMPRESSION & NOT SCREW TYPE.
2. SWITCHES AND RECEPTACLES  
PROVIDE 20AMP NEMA RATED SWITCHES AND RECEPTACLES OF SPECIFICATION GRADE. ALL SWITCHES SHALL BE RATED FOR 120 AND/OR 277 VOLT AND RECEPTACLES SHALL BE NEMA 5-20R. IN ALL OFFICES AND OFFICE AREAS DEVICES SHALL BE DECORA NOVA SERIES TYPE WITH COLOR SELECTION BY ARCHITECT/OWNERS REPRESENTATIVE.
3. FEEDERS AND BRANCH CIRCUITS IDENTIFICATION  
IDENTIFY FEEDERS WITH THE CORRESPONDING CIRCUIT DESIGNATION AT THE OVER-CURRENT DEVICE, LOAD END, AND IN PULL BOXES WITH E-Z CODE OR OTHER APPROVED WIRE MARKER. IDENTIFY BRANCH CIRCUITS WITH I.D. MARKERS, THE CORRESPONDING CIRCUIT DESIGNATION AT THE OVER-CURRENT DEVICE, AT ALL SPLICES, IN JUNCTION BOXES, AND IN OUTLETS. USE PLASTIC COATED SELF-STICKING MARKERS SUCH AS THOMAS & BETTS E-Z CODE FOR IDENTIFICATION OF CONDUCTORS. IDENTIFY SIGNAL & COMMUNICATION CABLES AT TERMINAL AND OUTLET UNIQUELY WITH PERMANENT LABELING.
4. CONDUCTORS  
DELIVER ALL CONDUCTORS TO THE JOB SITE IN ORIGINAL UNBROKEN CARTON OR REEL, PROPERLY TAGGED WITH U.L. LABEL, SIZE, TYPE, MANUFACTURER, TRADE NAME AND THE DATE OF MANUFACTURE. (MUST BE MANUFACTURED WITHIN 6 MONTHS) PROVIDE COPPER CONDUCTORS #12 AWG MINIMUM UNLESS SPECIFICALLY NOTED OTHERWISE ON THE DRAWINGS. PROVIDE STRANDED COPPER CONDUCTORS FOR ALL WIRING. USE CONDUCTORS WITH 90°C THINWALL 600 VOLTS INSULATION, UNLESS OTHERWISE NOTED. CONDUCTOR SIZE NO.1 AWG AND SMALLER WITH 90 DEGREE C INSULATION ARE TO USE THE 60 DEGREE COLUMN OF THE CODE, TABLE 310-16, TO DETERMINE AMPACITY. CONDUCTORS #1/0 AWG AND LARGER WITH 75 DEGREE AND 90 DEGREE INSULATION ARE TO USE THE 75 DEGREE COLUMN OF CODE, TABLE 310-16, TO DETERMINE AMPACITY. (110.14C) WHERE THE NUMBER OF CONDUCTORS IN A RACEWAY OR CABLE EXCEEDS THREE, THE ALLOWABLE AMPACITY OF EACH CONDUCTOR SHALL BE REDUCED PER TABLE 310.15(B)(3)(a).
5. LIGHTING FIXTURES  
PROVIDE LIGHTING FIXTURES WITH ELECTRONIC DRIVERS PER SCHEDULE. NO SUBSTITUTIONS OF FIXTURES SHALL BE PROVIDED WITHOUT THE APPROVAL OF THE ENGINEER -OF-RECORD.
6. PANELBOARDS/SWITCHBOARD (BID SQUARE D); PROVIDE ALTERNATE BID)  
DISTRIBUTION AND LIGHTING PANELBOARDS WITHIN PROJECT AREA SHALL BE OF THE COPPER BUS THREE PHASE, FOUR WIRE DISTRIBUTED PHASING TYPE. CIRCUITING SHALL BE ARRANGED TO PROVIDE, AS NEARLY AS POSSIBLE, AN EVENLY BALANCED LOAD ON ALL PHASES. PANELBOARDS SHALL BE BOLT-ON CIRCUIT BREAKER TYPE. AVAILABLE FAULT CURRENT IS STATED ON PANELBOARD SCHEDULE. PROVIDE PANEL IDENTIFICATION NAMEPLATE (ENGRAVED ON-ADHESIVE 1/2" MINIMUM LETTERS) AND TYPEWRITTEN LIST OF CIRCUITS IN THE DIRECTORY FRAME. PROVIDE HINGED PANEL COVERS.
7. STRUCTURAL SUPPORT  
EACH SECTION OF FLOOR MOUNTED SWITCHBOARD, DISTRIBUTION BOARD, ETC. SHALL BE BOLTED TO THE CONCRETE HOUSEKEEPING PAD USING (6) 3/4"-10 GRADE 2 BOLTS AND CONICAL WASHERS TORQUED TO 70LB-FT. PROVIDE MINIMUM 4000 PSI STRENGTH CONCRETE BELOW ALL FLOOR MOUNTED ELECTRICAL EQUIPMENT. TIE THE TOP OF ALL FLOOR MOUNTED ELECTRICAL EQUIPMENT TO THE BUILDING STRUCTURE IN A SEISMICALLY APPROVED MANNER.
8. ELECTRICAL CERTIFICATION  
"ELECTRICIANS" PERFORMING WORK ON THIS PROJECT SHALL BE CURRENTLY CERTIFIED IN ACCORDANCE WITH THE STATE OF CALIFORNIA AB931 AND THE DIVISION OF APPRENTICESHIP STANDARDS SECTION 3099.
- C. DEMOLITION  
1. NOTIFY THE OWNER IMMEDIATELY WHEREVER EXISTING EQUIPMENT IS ENCOUNTERED WHICH MUST BE RELOCATED DUE TO THE NEW CONSTRUCTION, AND WHICH IS NOT INDICATED ON THE PLANS.
2. BEGINNING OF DEMOLITION MEANS CONTRACTOR ACCEPTS EXISTING CONDITIONS.
- D. EXECUTION  
1. ALL CONDUIT RUNS SHALL BE CONCEALED, UNLESS SHOWN OTHERWISE. PROVIDE A PULL WIRE IN ALL EMPTY CONDUITS.
2. EXISTING CONDITION SHOWN IS FROM AVAILABLE RECORD DRAWINGS AND VISUAL FIELD SURVEY AND SHOWN FOR REFERENCE ONLY. CONTRACTOR SHALL VERIFY ACTUAL EXISTING CONDITION AT SITE.
3. ALL WORK SHOWN IS NEW UNLESS SPECIFICALLY INDICATED AS EXISTING (X). ALL ELECTRICAL EQUIPMENT MOUNTING AND ANCHORAGE MUST CONFORM WITH LOCAL AND STATE SEISMIC CODES.
- E. NOT USED
- F. GROUNDING & BONDING  
FURNISH AND INSTALL COMPLETE BONDING AND GROUNDING SYSTEM AS REQUIRED BY CODES. CONTINUITY OF GROUNDING SHALL BE MAINTAINED MECHANICALLY AND ELECTRICALLY THROUGHOUT THE SYSTEM. A GREEN GROUNDING CODE SIZED CONDUCTOR SHALL BE CARRIED IN ALL CONDUITS.

SYMBOLS

RELAY CONTROLLED RECEPTACLE AT 18" AFF TO BOTTOM OF DEVICE, PROVIDE WITHIN 6'-0" OF NON CONTROLLED RECEPTACLE. PROVIDE COVER PLATE WITH ENGRAVED "CONTROLLED".

DUPLEX RECEPTACLE, WALL MOUNTED @ +18" AFF TO BOTTOM OF DEVICE, NEMA 5-20R U.O.N.

DOUBLE DUPLEX RECEPTACLE, NEMA 5-20R, WALL MOUNTED @ +18" AFF AT BOTTOM OF DEVICE

DUPLEX RECEPTACLE, FLOOR MOUNTED, NEMA 5-20R

CILING MOUNTED DUPLEX RECEPTACLE, 5-20R

JUNCTION BOX (CEILING MTD.) SIZE PER TABLE AND NEC ARTICLE 314

JUNCTION BOX (WALL MTD.) SIZE PER TABLE AND NEC ARTICLE 314

THERMOSTAT - 36" TO 48" AFF, BOTTOM & TOP OF BOX RESPECTIVELY

TRANSFORMER

BRANCH CIRCUIT PANELBOARD - 120/208VAC, 3Ø, 4W.

CONDUIT RUN CONCEALED ABOVE CEILING OR IN WALLS.

CONDUIT RUN CONCEALED BELOW FLOOR OR UNDERGROUND

LIGHTING CONTROL 0-10V (PURPLE GRAY)

LOW VOLTAGE CABLE & CONDUIT 3/4"C-1#CAT5 U.O.N. (PER R/LIGHT REQUIREMENTS)

EMERGENCY CIRCUIT

POWER CONDUIT & CONDUCTORS

FLEXIBLE CONDUIT (WITH GROUND CONDUCTOR, PROVIDE LIQUID TIGHT CONDUIT IN ALL EXPOSED AREAS)

HASH MARKS INDICATE QUANTITY OF #12 CONDUCTORS. NO HASH MARKS INDICATE (2)#12AWG. (PROVIDE GROUND CONDUCTOR IN ALL CONDUITS.)

WHERE NO NUMBER IS INDICATED, THE CONDUCTORS ARE #12AWG(MIN) CONDUIT SIZE IS AS REQUIRED BY ELECTRICAL CODE. (3/4" CONDUIT MINIMUM).

INDICATES A HOMERUN TO PNL 2LA, CKTS 1-3-5 WITH SHARED NEUTRAL & CKT 7 WITH DEDICATED NEUTRAL.

DO NOT RUN ANY CONDUIT IN SLAB IF ITS OUTSIDE DIAMETER EXCEEDS 1/3 THE THICKNESS OF THE SLAB. LOCATE CONDUITS WITHIN THE MIDDLE OF THE SLAB. WHERE CONDUITS ARE GROUPED IN PARALLEL RUNS, SPACE THEM 3" OR MORE APART. WHERE CONDUITS CROSS EACH OTHER, THICKEN SLAB PROPORTIONATELY OVER A HORIZONTAL AREA EQUAL TO TEN TIMES THE DIAMETER OF THE LARGEST CONDUIT. REFER ALSO TO DETAILS SHOWN.

SIZE OUTLET BOXES IN CONFORMITY WITH CODE FOR NUMBER AND GAUGE OF CONDUCTORS THEREIN, EXCEPT WHERE NOTED TO BE LARGER. MINIMUM BOX SIZE SHALL BE 4" SQUARE BY 1-1/2" DEEP.

ALL ELECTRICAL WORK SHALL BE INSTALLED SO AS TO BE READILY ACCESSIBLE FOR OPERATING, SERVICING, MAINTAINING AND REPAIRING. ALL CONDUIT SHALL BE CONCEALED WHERE POSSIBLE. EXPOSED CONDUIT SHALL BE IN STRAIGHT LINES PARALLEL WITH, OR AT RIGHT ANGLES TO, COLUMN LINES OR BEAMS AND SEPARATED BY AT LEAST THREE (3) INCHES FROM WATER LINES WHENEVER THEY RUN LONG SIDE OR ACROSS SUCH LINES. CONDUIT SHALL NOT BE RUN BELOW CABLE TRAYS OR LIGHT FIXTURES WITHOUT SPECIFIC APPROVAL OF THE OWNERS REPRESENTATIVE. HANGERS SHALL BE FASTENED TO STEEL, CONCRETE OR MASONRY, BUT NOT TO PIPING. HANGERS AND SUPPORT SYSTEMS ARE AN INTEGRAL PART OF THE VISUAL ENVIRONMENT. ALL HANGERS AND SUPPORTS EXPOSED TO PUBLIC VIEW MUST BE SHOWN IN DETAIL ON PLANS SUBMITTED TO ENGINEER FOR APPROVAL OF APPEARANCE. ALL HANGERS MUST BE UNIFORMLY SPACED AND NEATLY INSTALLED WITH NO EXCESS MATERIAL BEYOND WHAT IS REQUIRED FOR THE SUPPORT FUNCTION. CONTRACTOR SHALL SELECT ACCESSORIES AND HARDWARE WITH A SMOOTH, NEAT FINISHED APPEARANCE AND PAINT ALL EXPOSED CONDUIT HANGERS TO MATCH THE ADJACENT FINISHES.

ALL RECEPTACLES SHALL BE MOUNTED AT 18" PER ADA REQUIREMENTS UNLESS NOTED OTHERWISE, MEASURED FROM BOTTOM OF BOX.

ALL DISTRIBUTION BOARDS, SWITCHBOARDS AND TRANSFORMERS THAT ARE FLOOR MOUNTED SHALL BE MOUNTED ON 2" THICK HOUSEKEEPING PAD. TRANSFORMER SHALL BE ON VIBRATION ISOLATION PADS AND CONNECTED WITH FLEXIBLE CONDUIT.

CONTRACTOR SHALL EXAMINE PLANS AND VERIFY IN FIELD LOCATIONS OF ALL FIRE RATED WALLS, CEILINGS AND FLOORS. CONTRACTOR SHALL SEAL ALL ELECTRICAL SYSTEM PENETRATIONS THROUGH FIRE RATED WALLS, CEILINGS AND FLOORS WITH U.L. LISTED MATERIAL APPROVED BY THE AUTHORITY HAVING JURISDICTION.

ALL SWITCHES SHALL BE MOUNTED 36" TO 48" MEASURED FROM BOTTOM & TOP OF BOX RESPECTIVELY.

PANEL CIRCUIT DIRECTORY SHALL COMPLY WITH CEC 408.4.

PROVIDE 90% COMPACTION OR SAND SLURRY OVER ALL UNDERGROUND CONDUITS, USE ONLY CLEAN FILL.

100A UTILITY METER (OR AS NOTED)

FUSED DISCONNECT SWITCH 100AMP SWITCH RATING WITH 60 AMP FUSES, 3 POLE

MOLDED CASE CIRCUIT BREAKER 200 AMP FRAME, 150 AMP TRIP RATING, 3 POLE

CCTV-VERIFY MOUNTING LOCATION AND REQUIREMENTS WITH CLIENT/OWNER.

DISCONNECT SWITCH, 60AMP SWITCH, 35 AMP FUSE, 3 POLE W/ OVERCURRENT PROTECTION U.O.N.

60AS 35AF 3P

100AS 60AF 3P

200AF 150AT 3P

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200AF 150AT 3P

CCTV-VERIFY MOUNTING LOCATION AND REQUIREMENTS WITH CLIENT/OWNER.

DISCONNECT SWITCH, 60AMP SWITCH, 35 AMP FUSE, 3 POLE W/ OVERCURRENT PROTECTION U.O.N.

60AS 35AF 3P

100AS 60AF 3P

200AF 150AT 3P

100AS 60AF 3P

200AF 150AT 3P

CCTV-VERIFY MOUNTING LOCATION AND REQUIREMENTS WITH CLIENT/OWNER.

DISCONNECT SWITCH, 60AMP SWITCH, 35 AMP FUSE, 3 POLE W/ OVERCURRENT PROTECTION U.O.N.

60AS 35AF 3P

100AS 60AF 3P

200AF 150AT 3P

100AS 60AF 3P

200AF 150AT 3P

CCTV-VERIFY MOUNTING LOCATION AND REQUIREMENTS WITH CLIENT/OWNER.

DISCONNECT SWITCH, 60AMP SWITCH, 35 AMP FUSE, 3 POLE W/ OVERCURRENT PROTECTION U.O.N.

60AS 35AF 3P

100AS 60AF 3P

200AF 150AT 3P

100AS 60AF 3P

200AF 150AT 3P

CCTV-VERIFY MOUNTING LOCATION AND REQUIREMENTS WITH CLIENT/OWNER.

DISCONNECT SWITCH, 60AMP SWITCH, 35 AMP FUSE, 3 POLE W/ OVERCURRENT PROTECTION U.O.N.

60AS 35AF 3P

100AS 60AF 3P

200AF 150AT 3P

100AS 60AF 3P

200AF 150AT 3P

CCTV-VERIFY MOUNTING LOCATION AND REQUIREMENTS WITH CLIENT/OWNER.

DISCONNECT SWITCH, 60AMP SWITCH, 35 AMP FUSE, 3 POLE W/ OVERCURRENT PROTECTION U.O.N.

60AS 35AF 3P

100AS 60AF 3P

200AF 150AT 3P

100AS 60AF 3P

200AF 150AT 3P

CCTV-VERIFY MOUNTING LOCATION AND REQUIREMENTS WITH CLIENT/OWNER.

DISCONNECT SWITCH, 60AMP SWITCH, 35 AMP FUSE, 3 POLE W/ OVERCURRENT PROTECTION U.O.N.

60AS 35AF 3P

100AS 60AF 3P

200AF 150AT 3P

100AS 60AF 3P

200AF 150AT 3P

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DISCONNECT SWITCH, 60AMP SWITCH, 35 AMP FUSE, 3 POLE W/ OVERCURRENT PROTECTION U.O.N.

60AS 35AF 3P

100AS 60AF 3P

200AF 150AT 3P

100AS 60AF 3P

200AF 150AT 3P

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DISCONNECT SWITCH, 60AMP SWITCH, 35 AMP FUSE, 3 POLE W/ OVERCURRENT PROTECTION U.O.N.

60AS 35AF 3P

100AS 60AF 3P

200AF 150AT 3P

100AS 60AF 3P

200AF 150AT 3P

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DISCONNECT SWITCH, 60AMP SWITCH, 35 AMP FUSE, 3 POLE W/ OVERCURRENT PROTECTION U.O.N.

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100AS 60AF 3P

200AF 150AT 3P

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200AF 150AT 3P

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200AF 150AT 3P

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200AF 150AT 3P

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100AS 60AF 3P

200AF 150AT 3P

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100AS 60AF 3P

200AF 150AT 3P

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100AS 60AF 3P

200AF 150AT 3P

100AS 60AF 3P

200AF 150AT 3P

CCTV-VERIFY MOUNTING LOCATION AND REQUIREMENTS WITH CLIENT/OWNER.

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100AS 60AF 3P

200AF 150AT 3P

100AS 60AF 3P

200AF 150AT 3P

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DISCONNECT SWITCH, 60AMP SWITCH, 35 AMP FUSE, 3 POLE W/ OVERCURRENT PROTECTION U.O.N.

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100AS 60AF 3P

200AF 150AT 3P

100AS 60AF 3P

200AF 150AT 3P

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60AS 35AF 3P

100AS 60AF 3P

200AF 150AT 3P

100AS 60AF 3P

200AF 150AT 3P

CCTV-VERIFY MOUNTING LOCATION AND REQUIREMENTS WITH CLIENT/OWNER.

DISCONNECT SWITCH, 60AMP SWITCH, 35 AMP FUSE, 3 POLE W/ OVERCURRENT PROTECTION U.O.N.

60AS 35AF 3P

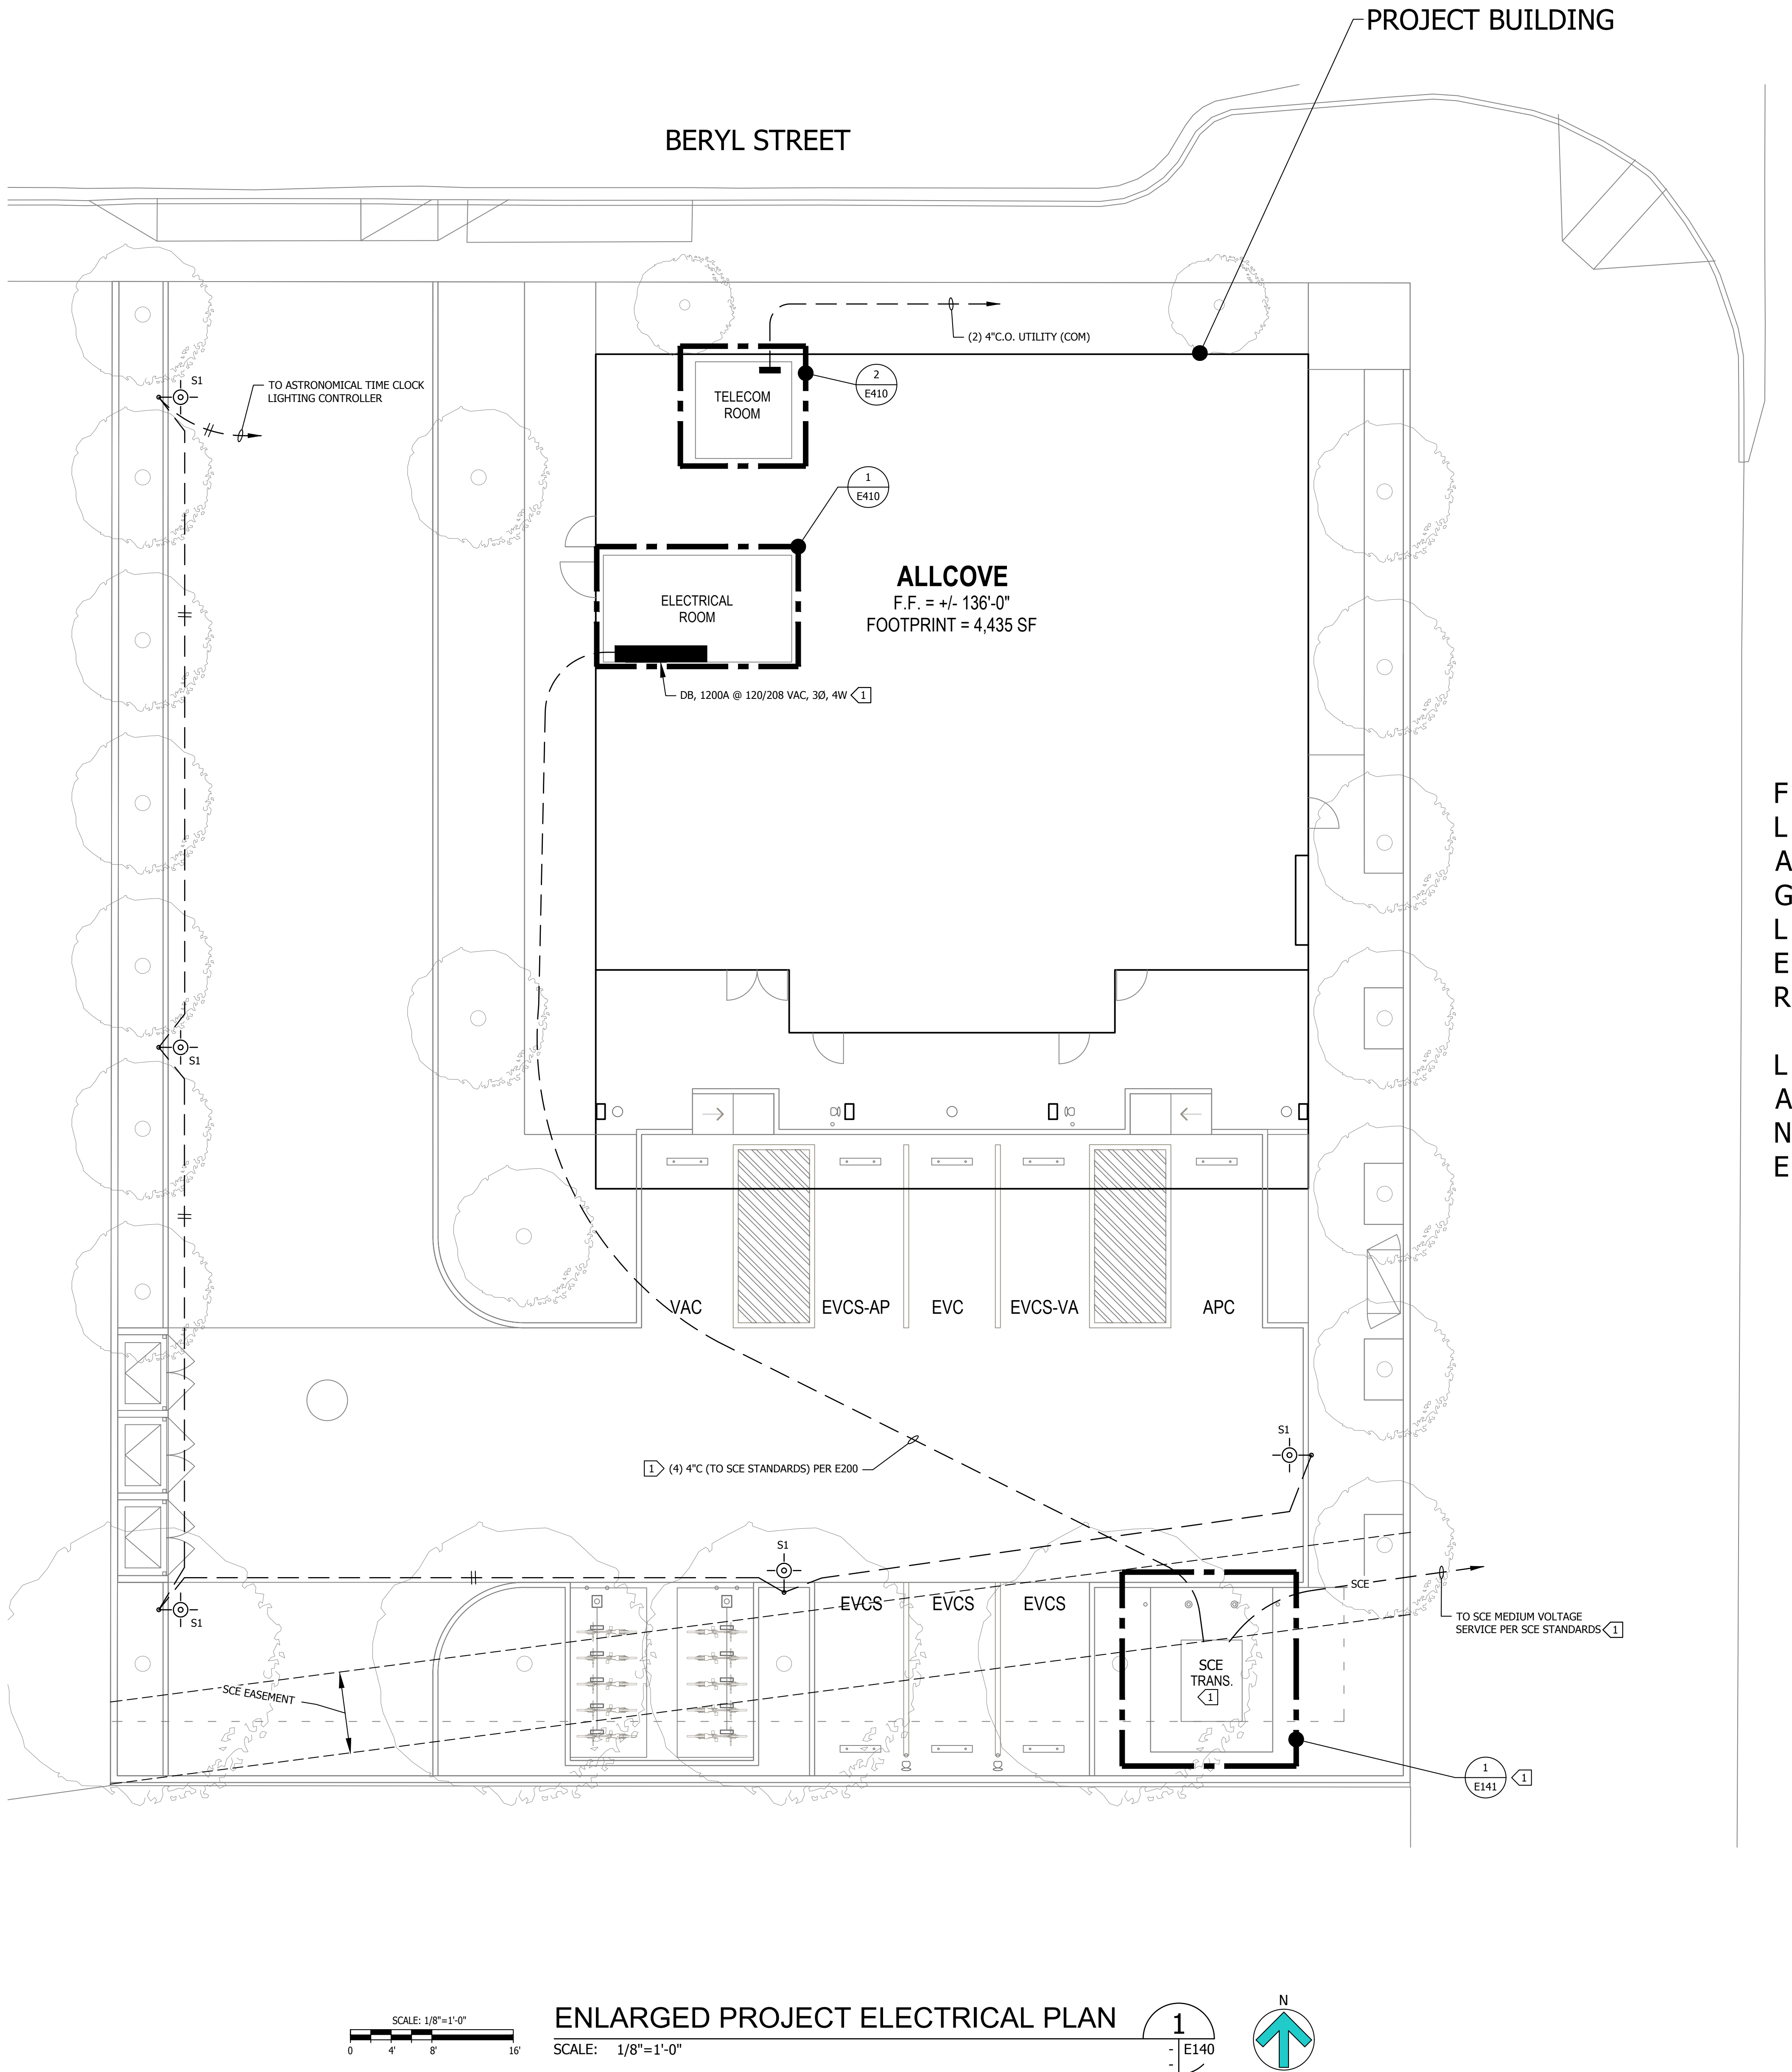
100AS 60AF 3P

200AF 15










SCALE: 1/8"=1'-0"

ENLARGED PROJECT ELECTRICAL PLAN

SCALE: 1/8"=1'-0"

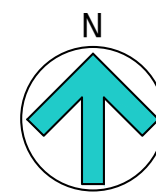1  
E140



SHEET NOTES:

1. VERIFY LOCATION OF ALL BUILDINGS AND APPENDICES ON ARCHITECTURAL AND CIVIL PLANS.
2. CONTRACTOR SHALL VERIFY LOCATION AND REQUIREMENTS OF ALL ELECTRICAL DEVICES PRIOR TO BID, ROUGH-IN AND INSTALLATION.
3. CONTRACTOR SHALL FIELD VERIFY LOCATION OF ALL UNDERGROUND UTILITIES PRIOR TO ANY TRENCHING. CONTRACTOR SHALL PROTECT ALL EXISTING/REMAINING UNDERGROUND UTILITY SYSTEMS IN PLACE. CONTRACTOR SHALL REPAIR ANY UTILITY SYSTEM DAMAGED DURING CONSTRUCTION.
4. CONTRACTOR SHALL COORDINATE AND PROVIDE ALL SITE ELECTRICAL SERVICE REQUIREMENTS WITH SERVING UTILITY.
5. ALL SERVICE ENTRANCE EQUIPMENT SHOP DRAWINGS SHALL BE SUBMITTED TO THE LOCAL UTILITY COMPANY FOR APPROVAL, WITH WRITTEN APPROVAL RECEIVED PRIOR TO SUBMISSION TO ELECTRICAL ENGINEER FOR APPROVAL.
6. MINIMUM CONDUIT BURIAL DEPTH IS 24" MINIMUM.
7. 1" CONDUIT MINIMUM UNDERGROUND.
8. COORDINATE WORK WITH OTHER TRADES. OBTAIN ALL DRAWINGS THAT WILL REQUIRE COORDINATION AND PROVIDE ALL ELECTRICAL CONNECTIONS, DEVICES, AND WIRING REQUIRED WHETHER SHOWN ON ELECTRICAL DRAWINGS OR NOT.
9. CONTRACTOR SHALL FURNISH AND INSTALL PULL BOXES AS REQUIRED TO INSTALL CONDUCTORS PER CONDUCTOR MANUFACTURERS RECOMMENDATIONS, PER THE NATIONAL ELECTRICAL CODE AND PER LOCAL AUTHORITIES HAVING JURISDICTION.

KEY NOTES:

- 1 PER SCE STANDARDS (SEE E200 & E141).



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PMA PROJECT NO.  
23-727

DRAWING TITLE  
ENLARGED PROJECT  
ELECTRICAL PLAN

SCALE  
AS NOTED

DATE  
02-28-2024

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D.S./L.K. K.L.

SHEET NO.

E140











	L5	L2
EV	L4	L1
MP	L3	L0





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**PMA PROJECT NO.**  
**23-727**

**DRAWING TITLE**  
**LIGHTING AND  
CONTROL SCHEDULE**

**SCALE**  
**AS NOTED**


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**02-28-2024**

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**D.S./L.K.**

**SHEET NO.**  
**E300**

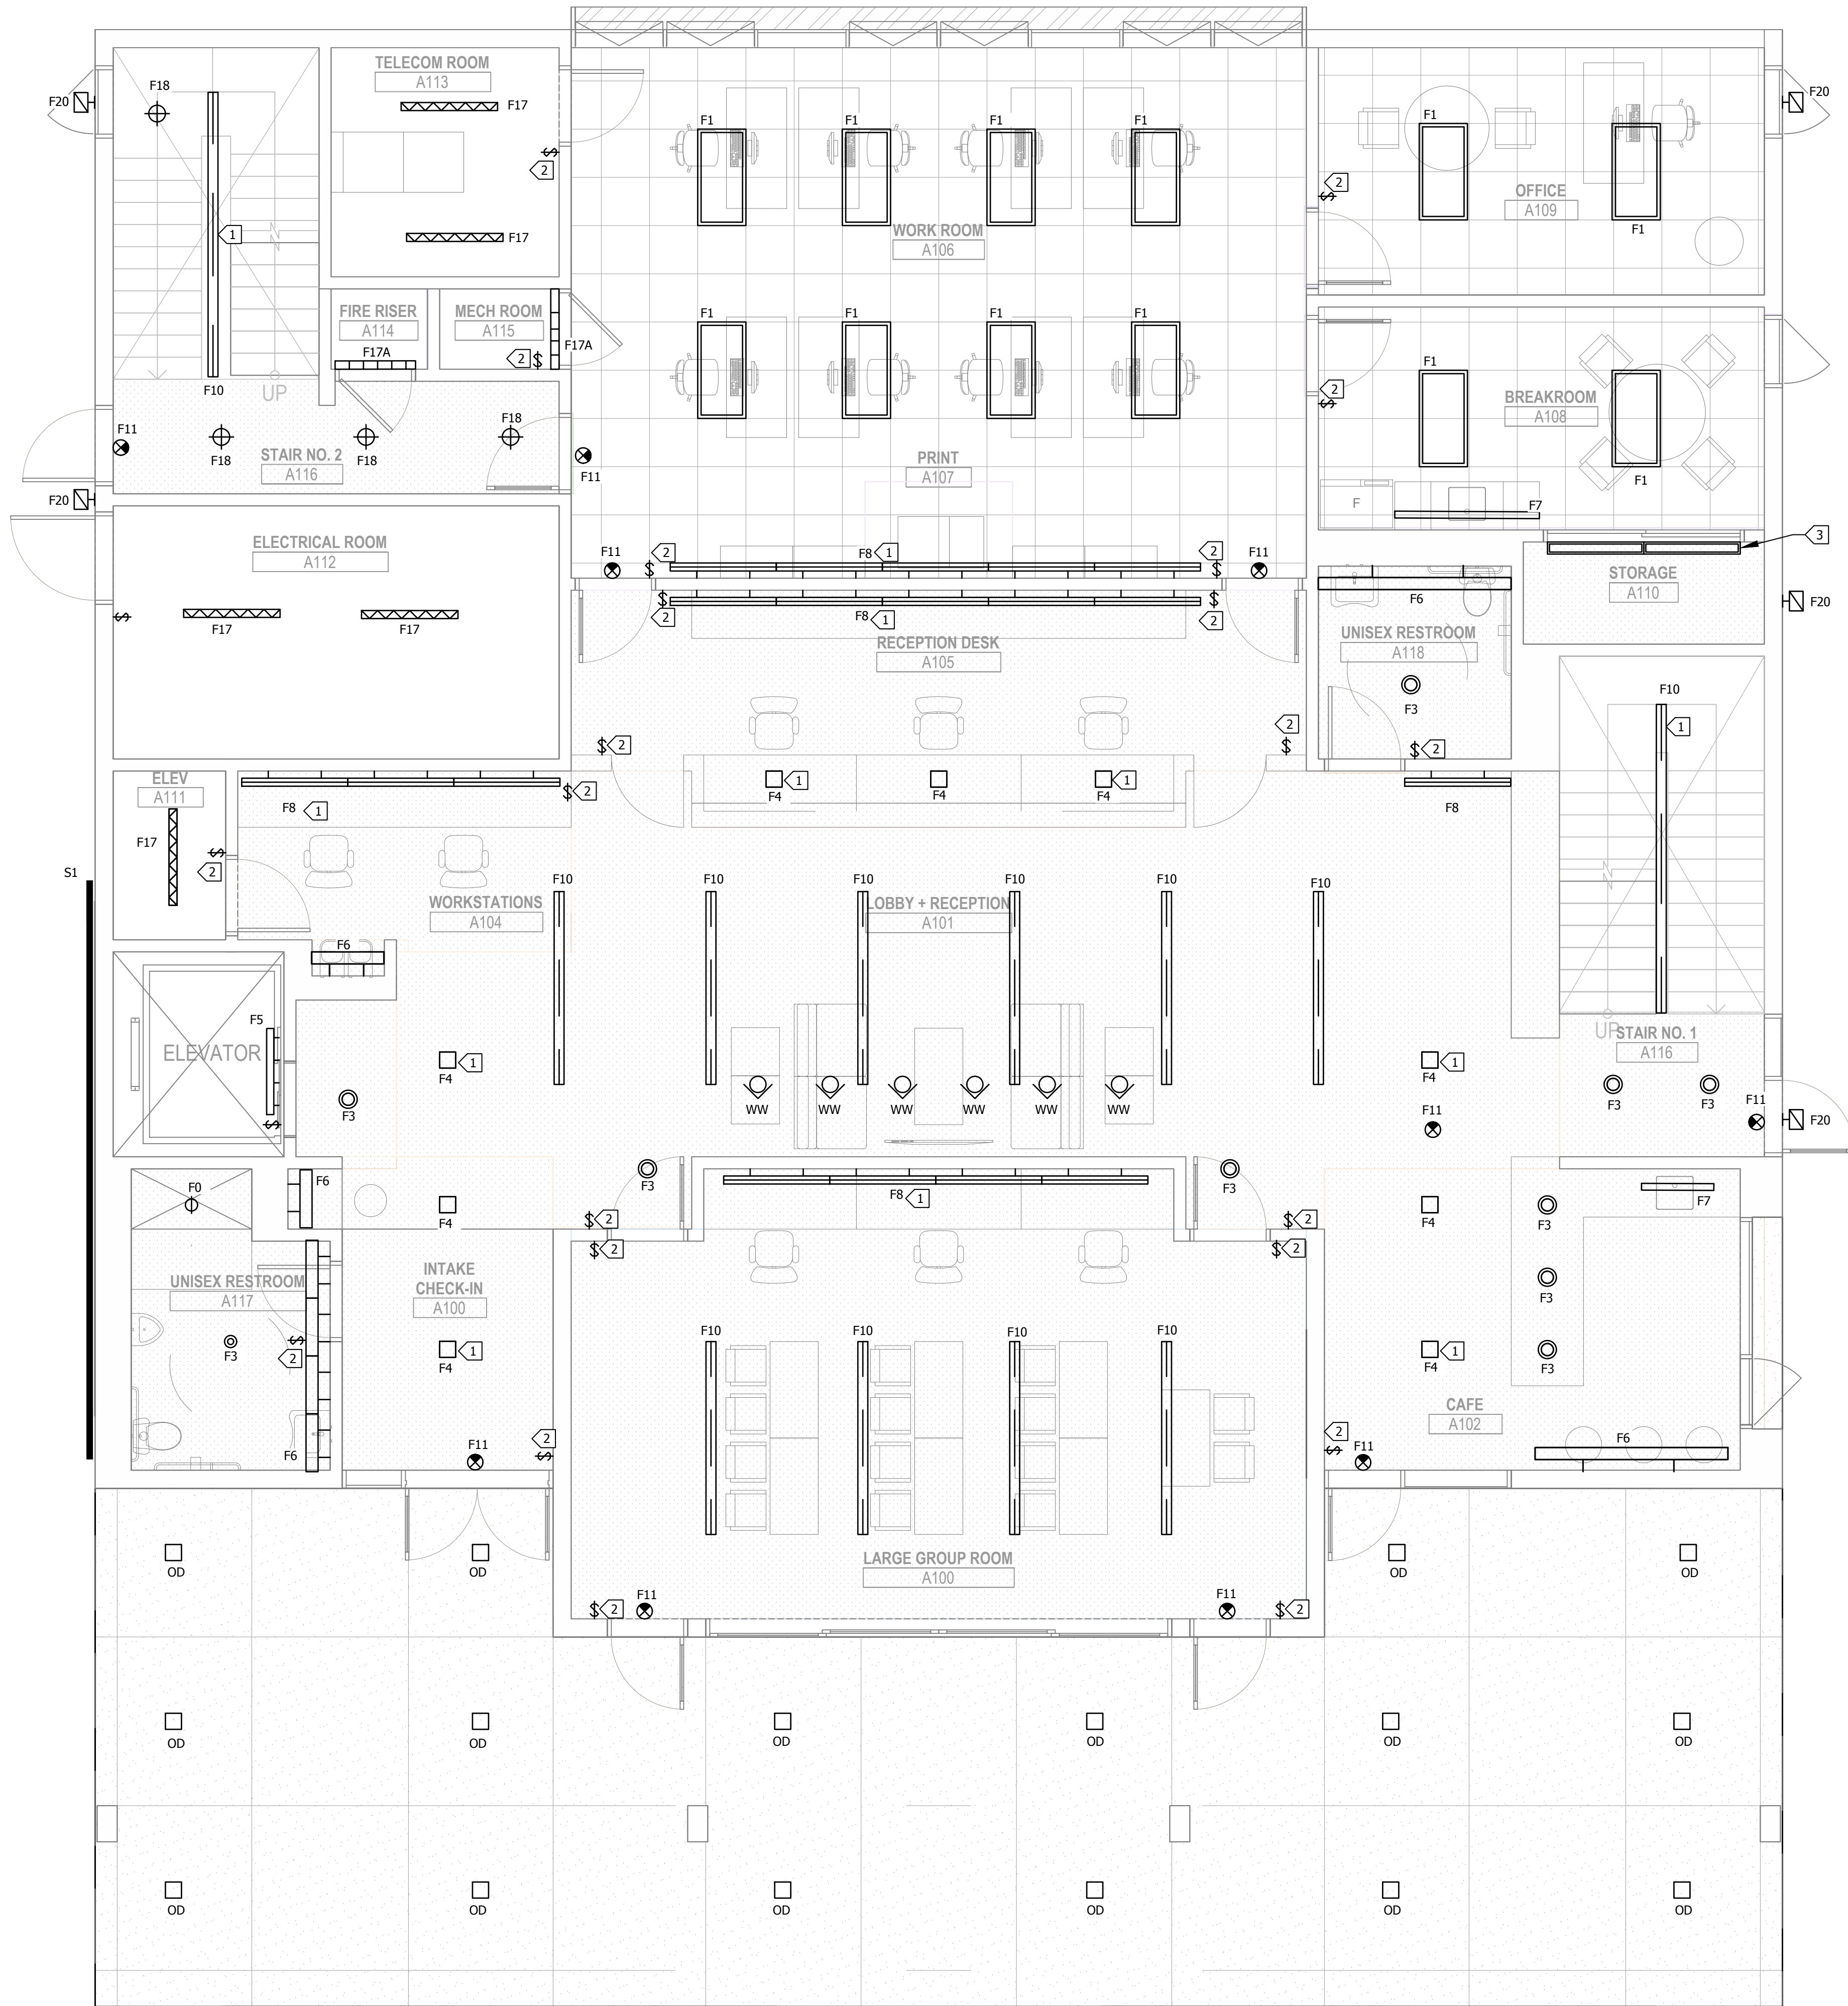**CHECKED**  
**K.L.**





FIRST LEVEL LIGHTING PLAN 1  
SCALE: 1/4"=1'-0" - E301

SHEET NOTES:

1. CONTRACTOR SHALL VERIFY LOCATION, CEILING TYPE, TRIM, AND REQUIREMENTS OF ALL LIGHT FIXTURES AND CONTROL PRIOR TO BID PROPOSAL, ROUGH-IN, AND FINISH INSTALLATION.
2. CONTRACTOR SHALL FURNISH AND INSTALL PULL BOXES AS REQUIRED TO INSTALL CONDUCTORS PER CONDUCTOR MANUFACTURERS RECOMMENDATIONS, PER THE NATIONAL ELECTRICAL CODE AND PER LOCAL AUTHORITIES HAVING JURISDICTION.
3. 3/4" CONDUIT MINIMUM UNLESS OTHERWISE NOTED.
4. VERIFY LOCATION OF ALL DEVICES ON ARCHITECTURAL PLANS.
5. MAINTAIN A MAXIMUM 2% VOLTAGE DROP ON ALL LIGHTING HOMERUNS.
6. ALL EXT SIGNS ARE +12" TO CENTER LINE OF FIXTURE ABOVE DOOR FRAME UNLESS OTHERWISE NOTED.
7. CONTRACTOR SHALL PROVIDE ALL BACKING, BRACKETS, SUPPORTS, AND MOUNTING HARDWARE NECESSARY TO PROPERLY INSTALL LIGHTING FIXTURES.
8. VERIFY THE EXACT ROUTING OF ALL EXPOSED CONDUIT WITH OWNER PRIOR TO INSTALLATION.
9. COORDINATE WORK WITH OTHER TRADES. OBTAIN ALL DRAWINGS THAT WILL REQUIRE COORDINATION AND PROVIDE ALL ELECTRICAL CONNECTIONS, DEVICES, AND WIRING REQUIRED WHETHER SHOWN ON ELECTRICAL DRAWINGS OR NOT.

KEY NOTES:

- 1 ON LIGHTING CONTROL FOR NIGHT LIGHT.
- 2 RECOMMENDED LIGHTING CONTROL STATIONS, ALL AREAS SHALL HAVE DIMMING CONTROL TO 1%.
- 3 PROVIDE MICRO-SWITCH FOR P9 ON DOOR

PROVIDE CA TITLE 24 LIGHTING CONTROLS, US nLIGHT FOR EOR APPROVED CONTROL SYSTEM.

PROVIDE PHOTOMETRICS FOR NORMAL & EMERGENCY LIGHTING (1 FOOT CANDLE MINIMUM) AT FINISHED FLOOR ON PATH OF EGRESS PER CBC & LIFE SAFETY CODE.

CONTRACTOR SHALL CONNECT EM LIGHTING TO LIGHTING FIXTURES PER PHOTOMETRIC STUDY & PER CBC, NEC & PREVAILING CODES.

CONTRACTOR SHALL PROVIDE OCCUPANCY SENSORS, DAYLIGHT HARVESTING, CONTROL, DIMMING, ECT PER 2022 CA TITLE 24 & OBTAIN COMMISSION FOR LIGHTING PER CA TITLE 24



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PMA PROJECT NO.  
23-727

DRAWING TITLE  
FIRST LEVEL  
LIGHTING PLAN

SCALE  
AS NOTED


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SHEET NO.

E301






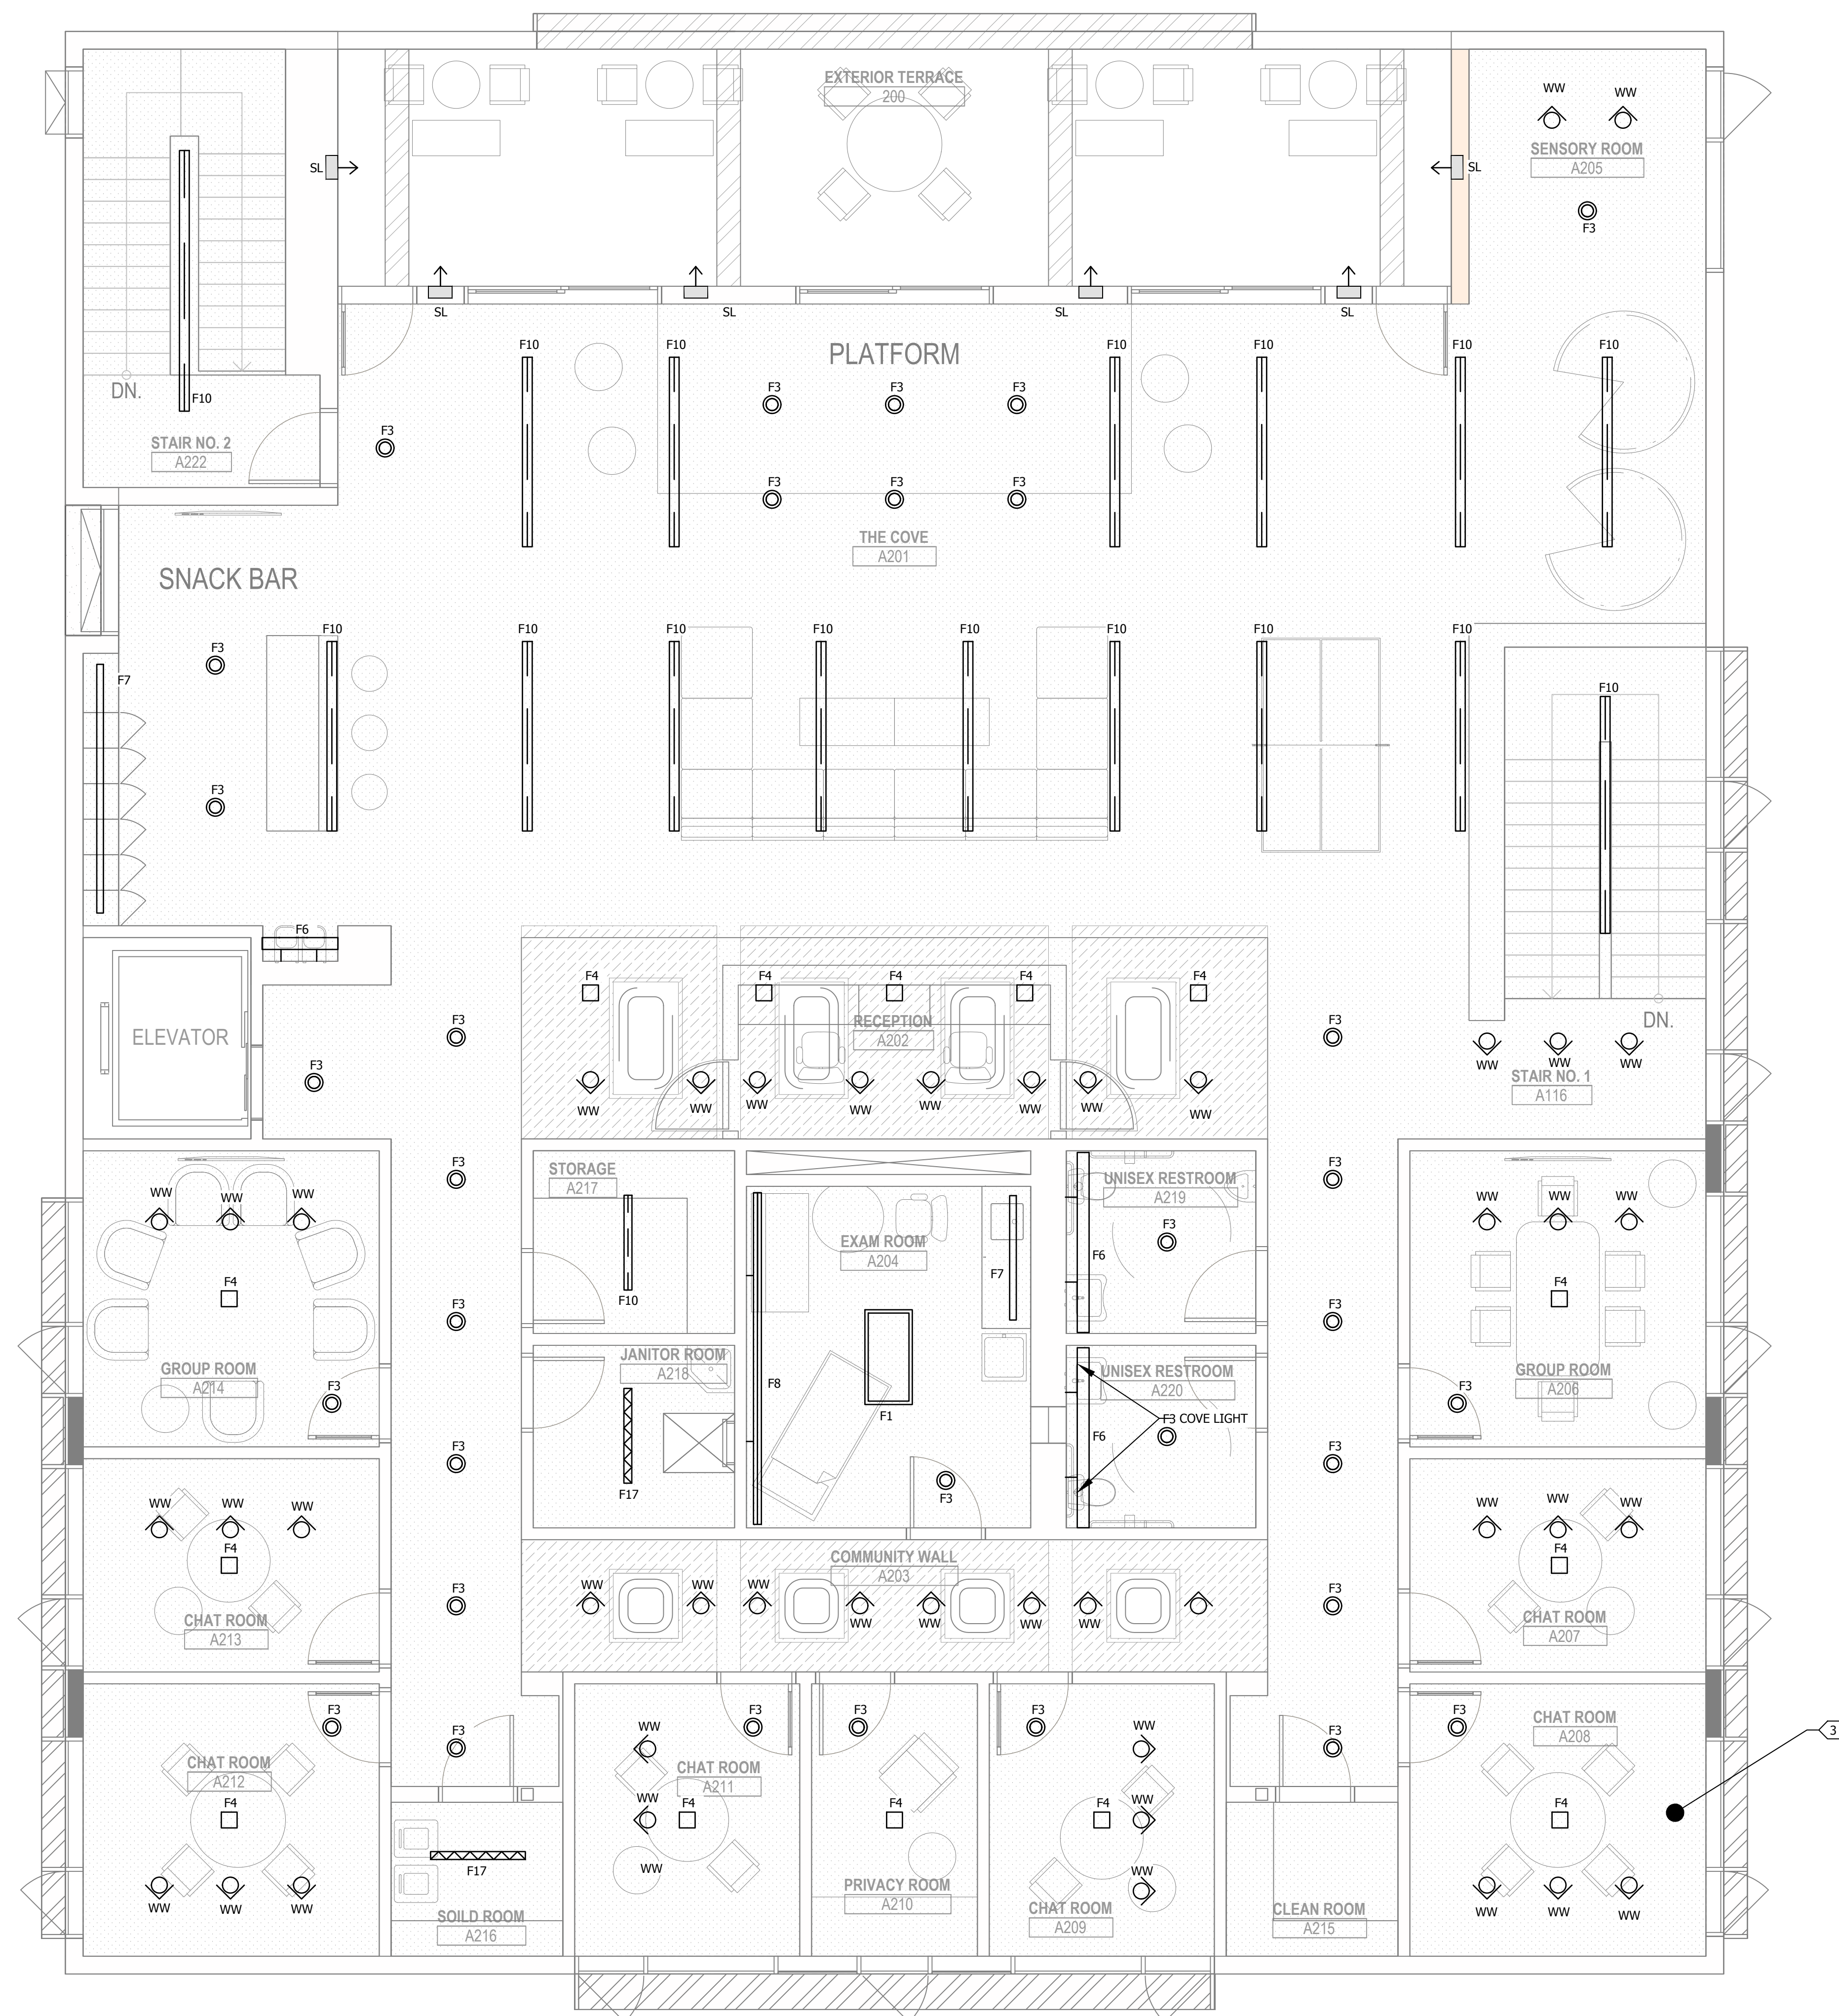SCALE:  $\frac{1}{4}'' = 1'-0''$

## SECOND LEVEL LIGHTING PLAN

SCALE: 1/4"=1'-0"

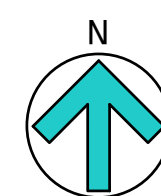1  
- E302



SHEET NOTES:

1. CONTRACTOR SHALL VERIFY LOCATION, CEILING TYPE, TRIM, AND REQUIREMENTS OF ALL LIGHT FIXTURES AND CONTROL PRIOR TO BID PROPOSAL, ROUGH-IN, AND FINISH INSTALLATION.
2. CONTRACTOR SHALL FURNISH AND INSTALL PULL BOXES AS REQUIRED TO INSTALL CONDUCTORS PER CONDUCTOR MANUFACTURERS RECOMMENDATIONS, PER THE NATIONAL ELECTRICAL CODE AND PER LOCAL AUTHORITIES HAVING JURISDICTION.
3. 3/4" CONDUIT MINIMUM UNLESS OTHERWISE NOTED.
4. VERIFY LOCATION OF ALL DEVICES ON ARCHITECTURAL PLANS.
5. MAINTAIN A MAXIMUM 2% VOLTAGE DROP ON ALL LIGHTING HOMERUNS.
6. ALL EXIT SIGNS ARE +12" TO CENTER LINE OF FIXTURE ABOVE DOOR FRAME UNLESS OTHERWISE NOTED.
7. CONTRACTOR SHALL PROVIDE ALL BACKING, BRACKETS, SUPPORTS, AND MOUNTING HARDWARE NECESSARY TO PROPERLY INSTALL LIGHTING FIXTURES.
8. VERIFY THE EXACT ROUTING OF ALL EXPOSED CONDUIT WITH OWNER PRIOR TO INSTALLATION.
9. COORDINATE WORK WITH OTHER TRADES. OBTAIN ALL DRAWINGS THAT WILL REQUIRE COORDINATION AND PROVIDE ALL ELECTRICAL CONNECTIONS, DEVICES, AND WIRING REQUIRED WHETHER SHOWN ON ELECTRICAL DRAWINGS OR NOT.

KEY NOTES:

- 1 ON LIGHTING CONTROL FOR NIGHT LIGHT.
- 2 RECOMMENDED LIGHTING CONTROL STATIONS, ALL AREAS SHALL HAVE DIMMING CONTROL TO 1%.
- 3 TYPICAL LIGHTING CONTROL ON BOTH FLOORS FOR ALL SIMILAR WOULD HAVE 3 DIMMER CONTROL WITH WW, F4 & F3 CONTROLLED INDEPENDENTLY.

PROVIDE CA TITLE 24 LIGHTING CONTROLS, US nLIGHT FOR EOR APPROVED CONTROL SYSTEM.

PROVIDE PHOTOMETRICS FOR NORMAL & EMERGENCY LIGHTING (1 FOOT CANDLE MINIMUM) AT FINISHED FLOOR ON PATH OF EGRESS PER CBC & LIFE SAFETY CODE.

CONTRACTOR SHALL CONNECT EM LIGHTING TO LIGHTING FIXTURES PER PHOTOMETRIC STUDY & PER CBC, NEC & PREVAILING CODES.

CONTRACTOR SHALL PROVIDE OCCUPANCY SENSORS,  
DAYLIGHT HARVESTING, CONTROL, DIMMING, ECT PER  
2022 CA TITLE 24 & OBTAIN COMMISSION FOR LIGHTING  
PER CA TITLE 24



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23-727

DRAWING TITLE

## SECOND LEVEL LIGHTING PLAN

SCALE  
AS NOTED

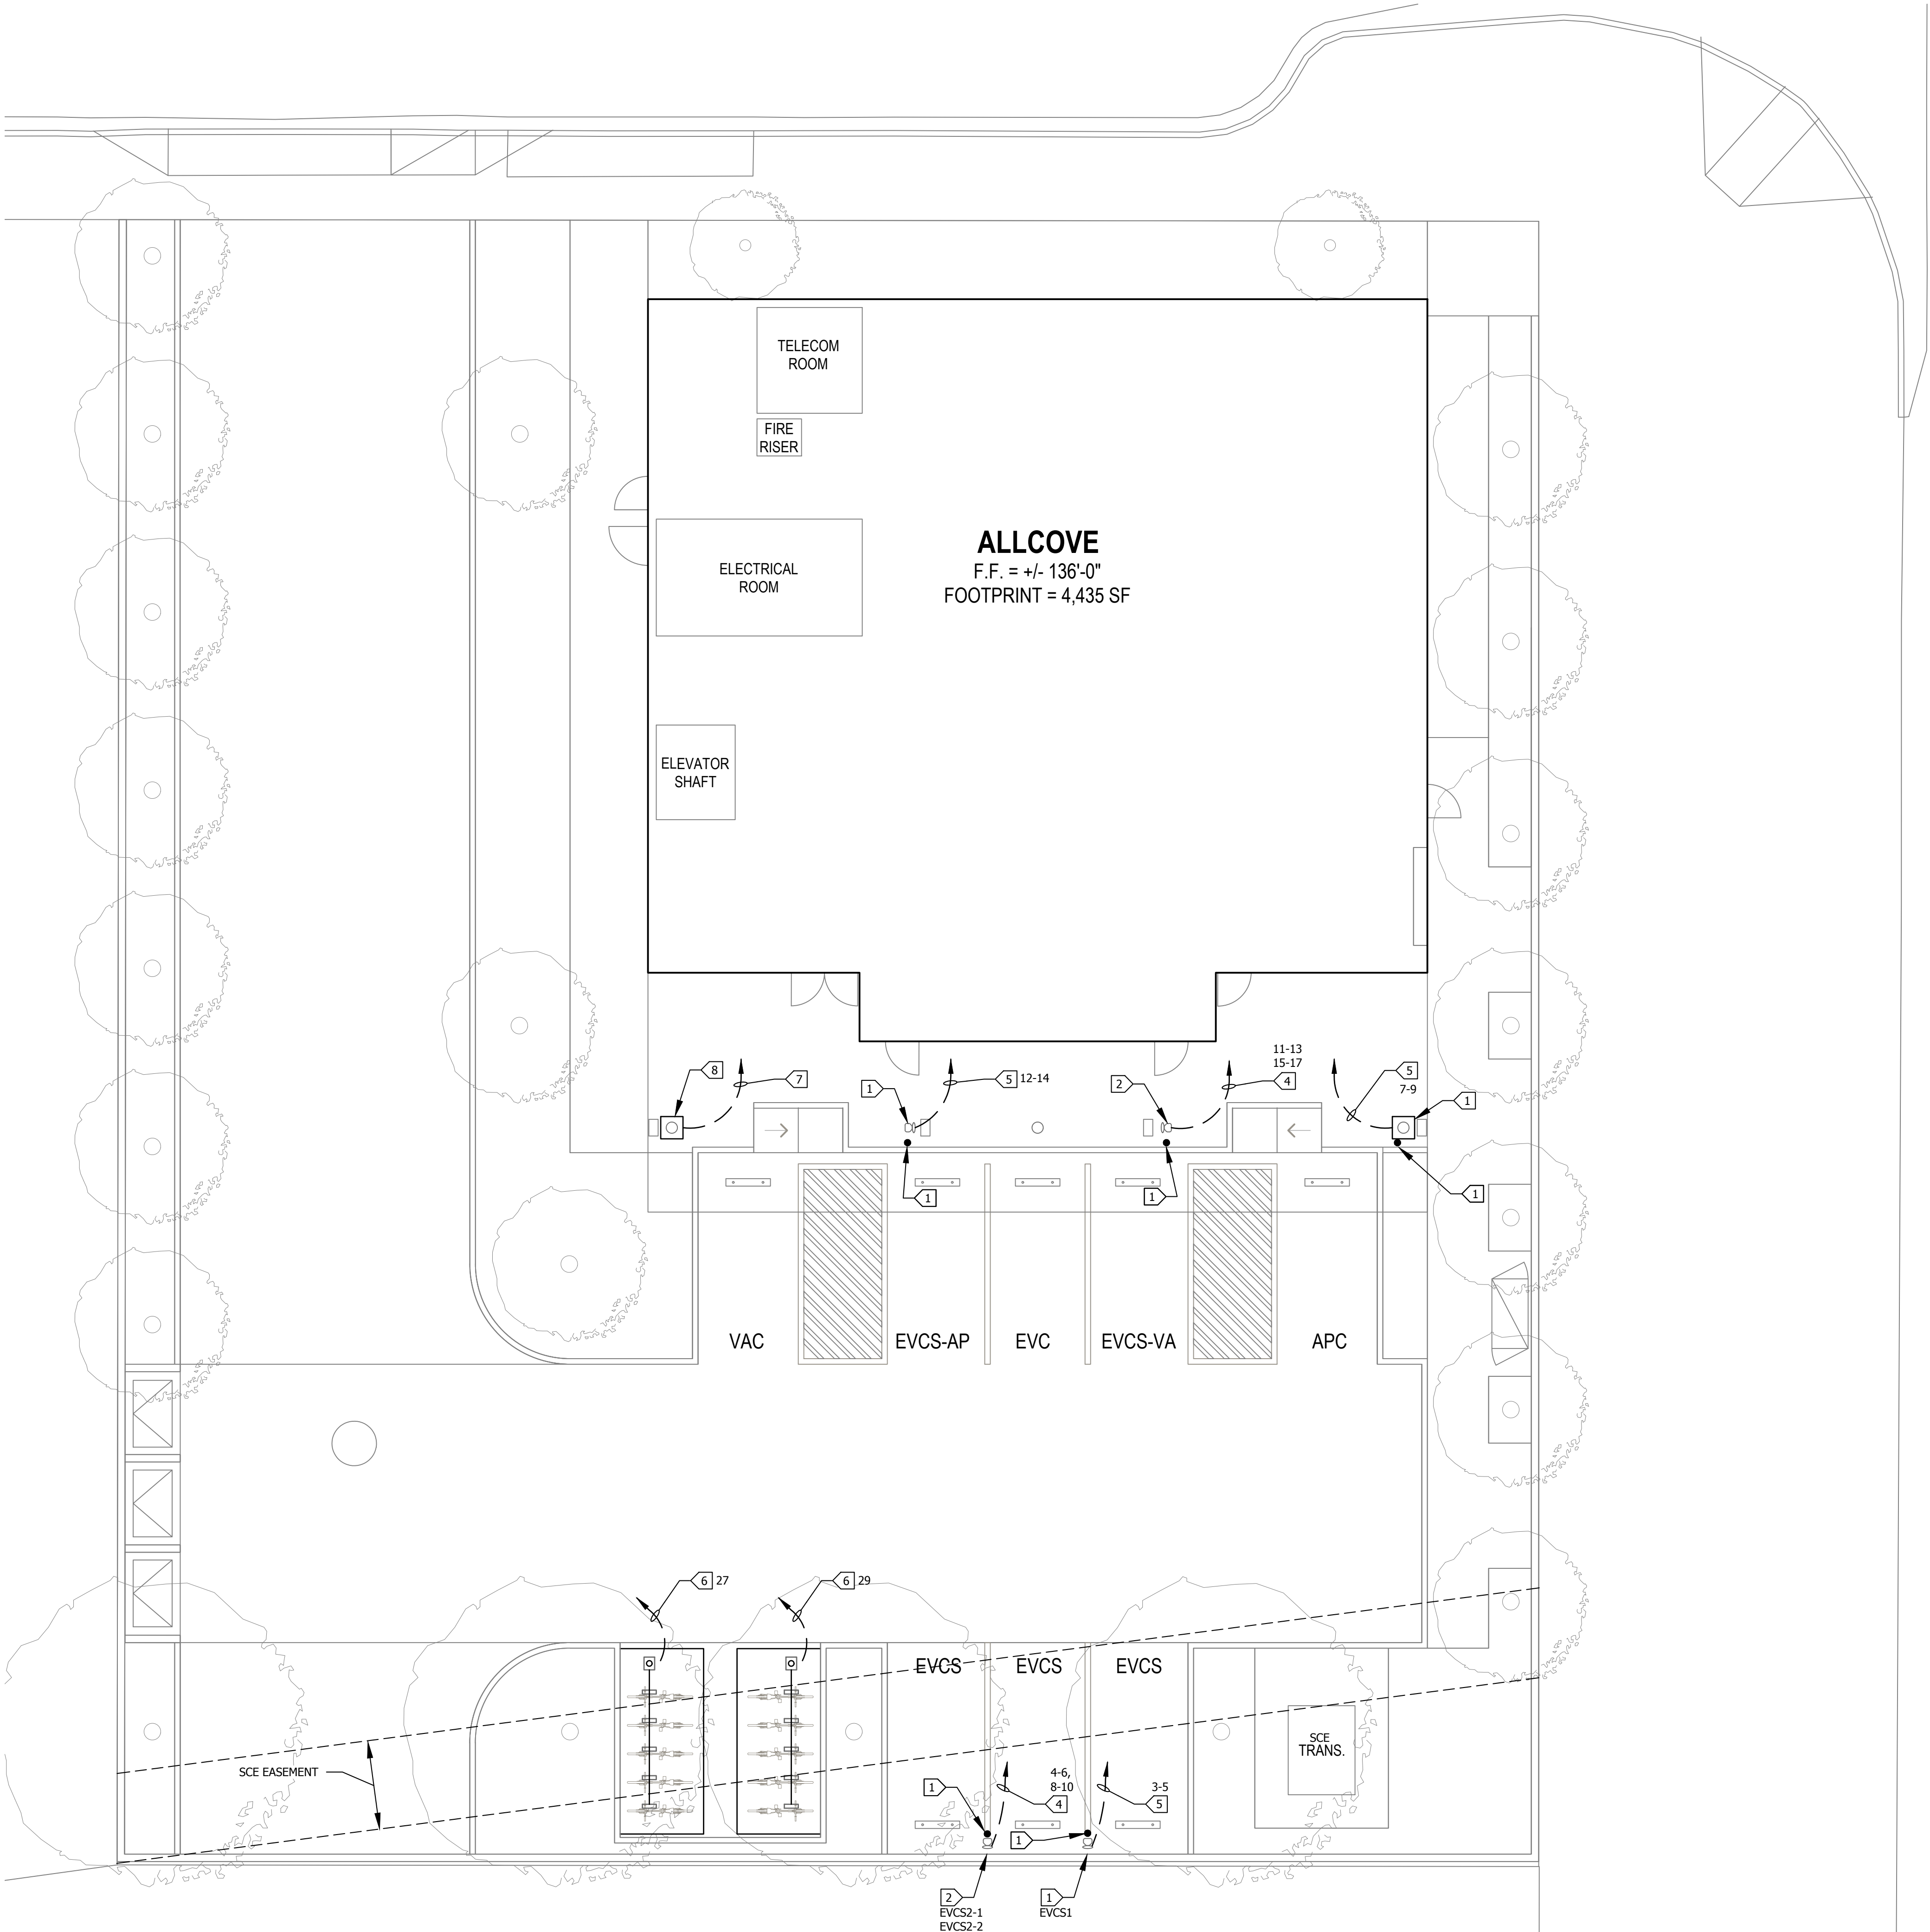
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E302






SITE ELECTRIC VEHICLE EV CHARGER PLAN

SCALE: 1/8"=1'-0"

1  
- E400

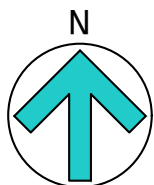

SHEET NOTES:

- CONTRACTOR SHALL FIELD VERIFY LOCATION & REQUIREMENTS OF ALL DEVICES REQUIRING ELECTRICAL CONNECTION PRIOR TO BID PROPOSAL, ROUGH-IN AND FINISH.
- COORDINATE WORK WITH OTHER TRADES. OBTAIN ALL DRAWINGS THAT WILL REQUIRE COORDINATION AND PROVIDE ALL ELECTRICAL CONNECTIONS, DEVICES, AND WIRING REQUIRED WHETHER SHOWN ON ELECTRICAL DRAWINGS OR NOT.
- CONTRACTOR SHALL FURNISH AND INSTALL PULL BOXES AS REQUIRED TO INSTALL CONDUCTORS PER CONDUCTOR MANUFACTURERS RECOMMENDATIONS, PER THE NATIONAL ELECTRICAL CODE AND PER LOCAL AUTHORITIES HAVING JURISDICTION.
- 1" CONDUIT MINIMUM UNDERGROUND.
- VERIFY LOCATION OF ALL DEVICES ON ARCHITECTURAL PLANS.
- VERIFY THE EXACT ROUTING OF ALL EXPOSED CONDUIT WITH OWNER PRIOR TO INSTALLATION.

KEY NOTES:

- EV CHARGER, SINGLE, LEVEL 2, CHARGE POINT 'CT40' BOLLARD MOUNT PROVIDE 12" x 18" x 24" DEEP CONCRETE BASE.
- EV CHARGER, DUAL, CHARGE POINT 'CT40' LEVEL 2, BOLLARD MOUNT PROVIDE 12" x 18" x 24" DEEP CONCRETE BASE.
- BIKE CHARGER - ELECTRIC (VERIFY POC CONNECTION WITH MANUFACTURERS)
- 1"C - 4#8 & 1#10 GND TO PANEL EV CIRCUITS AS NOTED.
- 1"C - 2#8 1#10 GND TO PANEL EV CIRCUITS AS NOTED.
- 1"C - 2#10 & 1#10 GROUND TO PANEL EV CIRCUITS AS NOTED.
- 1"C.O. FOR FUTURE EV CHARGE, HOME RUN TO PANEL EV
- CRISTY 12"x18" PULL BOX, TRAFFIC RATED WITH CONCRETE COVER, FLUSH WITH GRADE FOR FUTURE EV CONNECTION.  
PROVIDE 4" CONCRETE FILLED PIPE BOLLARD (PAINT YELLOW) IN FRONT OF EV CHARGER TO PROTECT EV CHARGER.



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DESIGN SUBMITTAL

PMA PROJECT NO.  
23-727

DRAWING TITLE  
SITE ELECTRIC  
VEHICLE EV CHARGER  
PLAN


SCALE  
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DATE  
02-28-2024

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D.S./L.K. K.L.

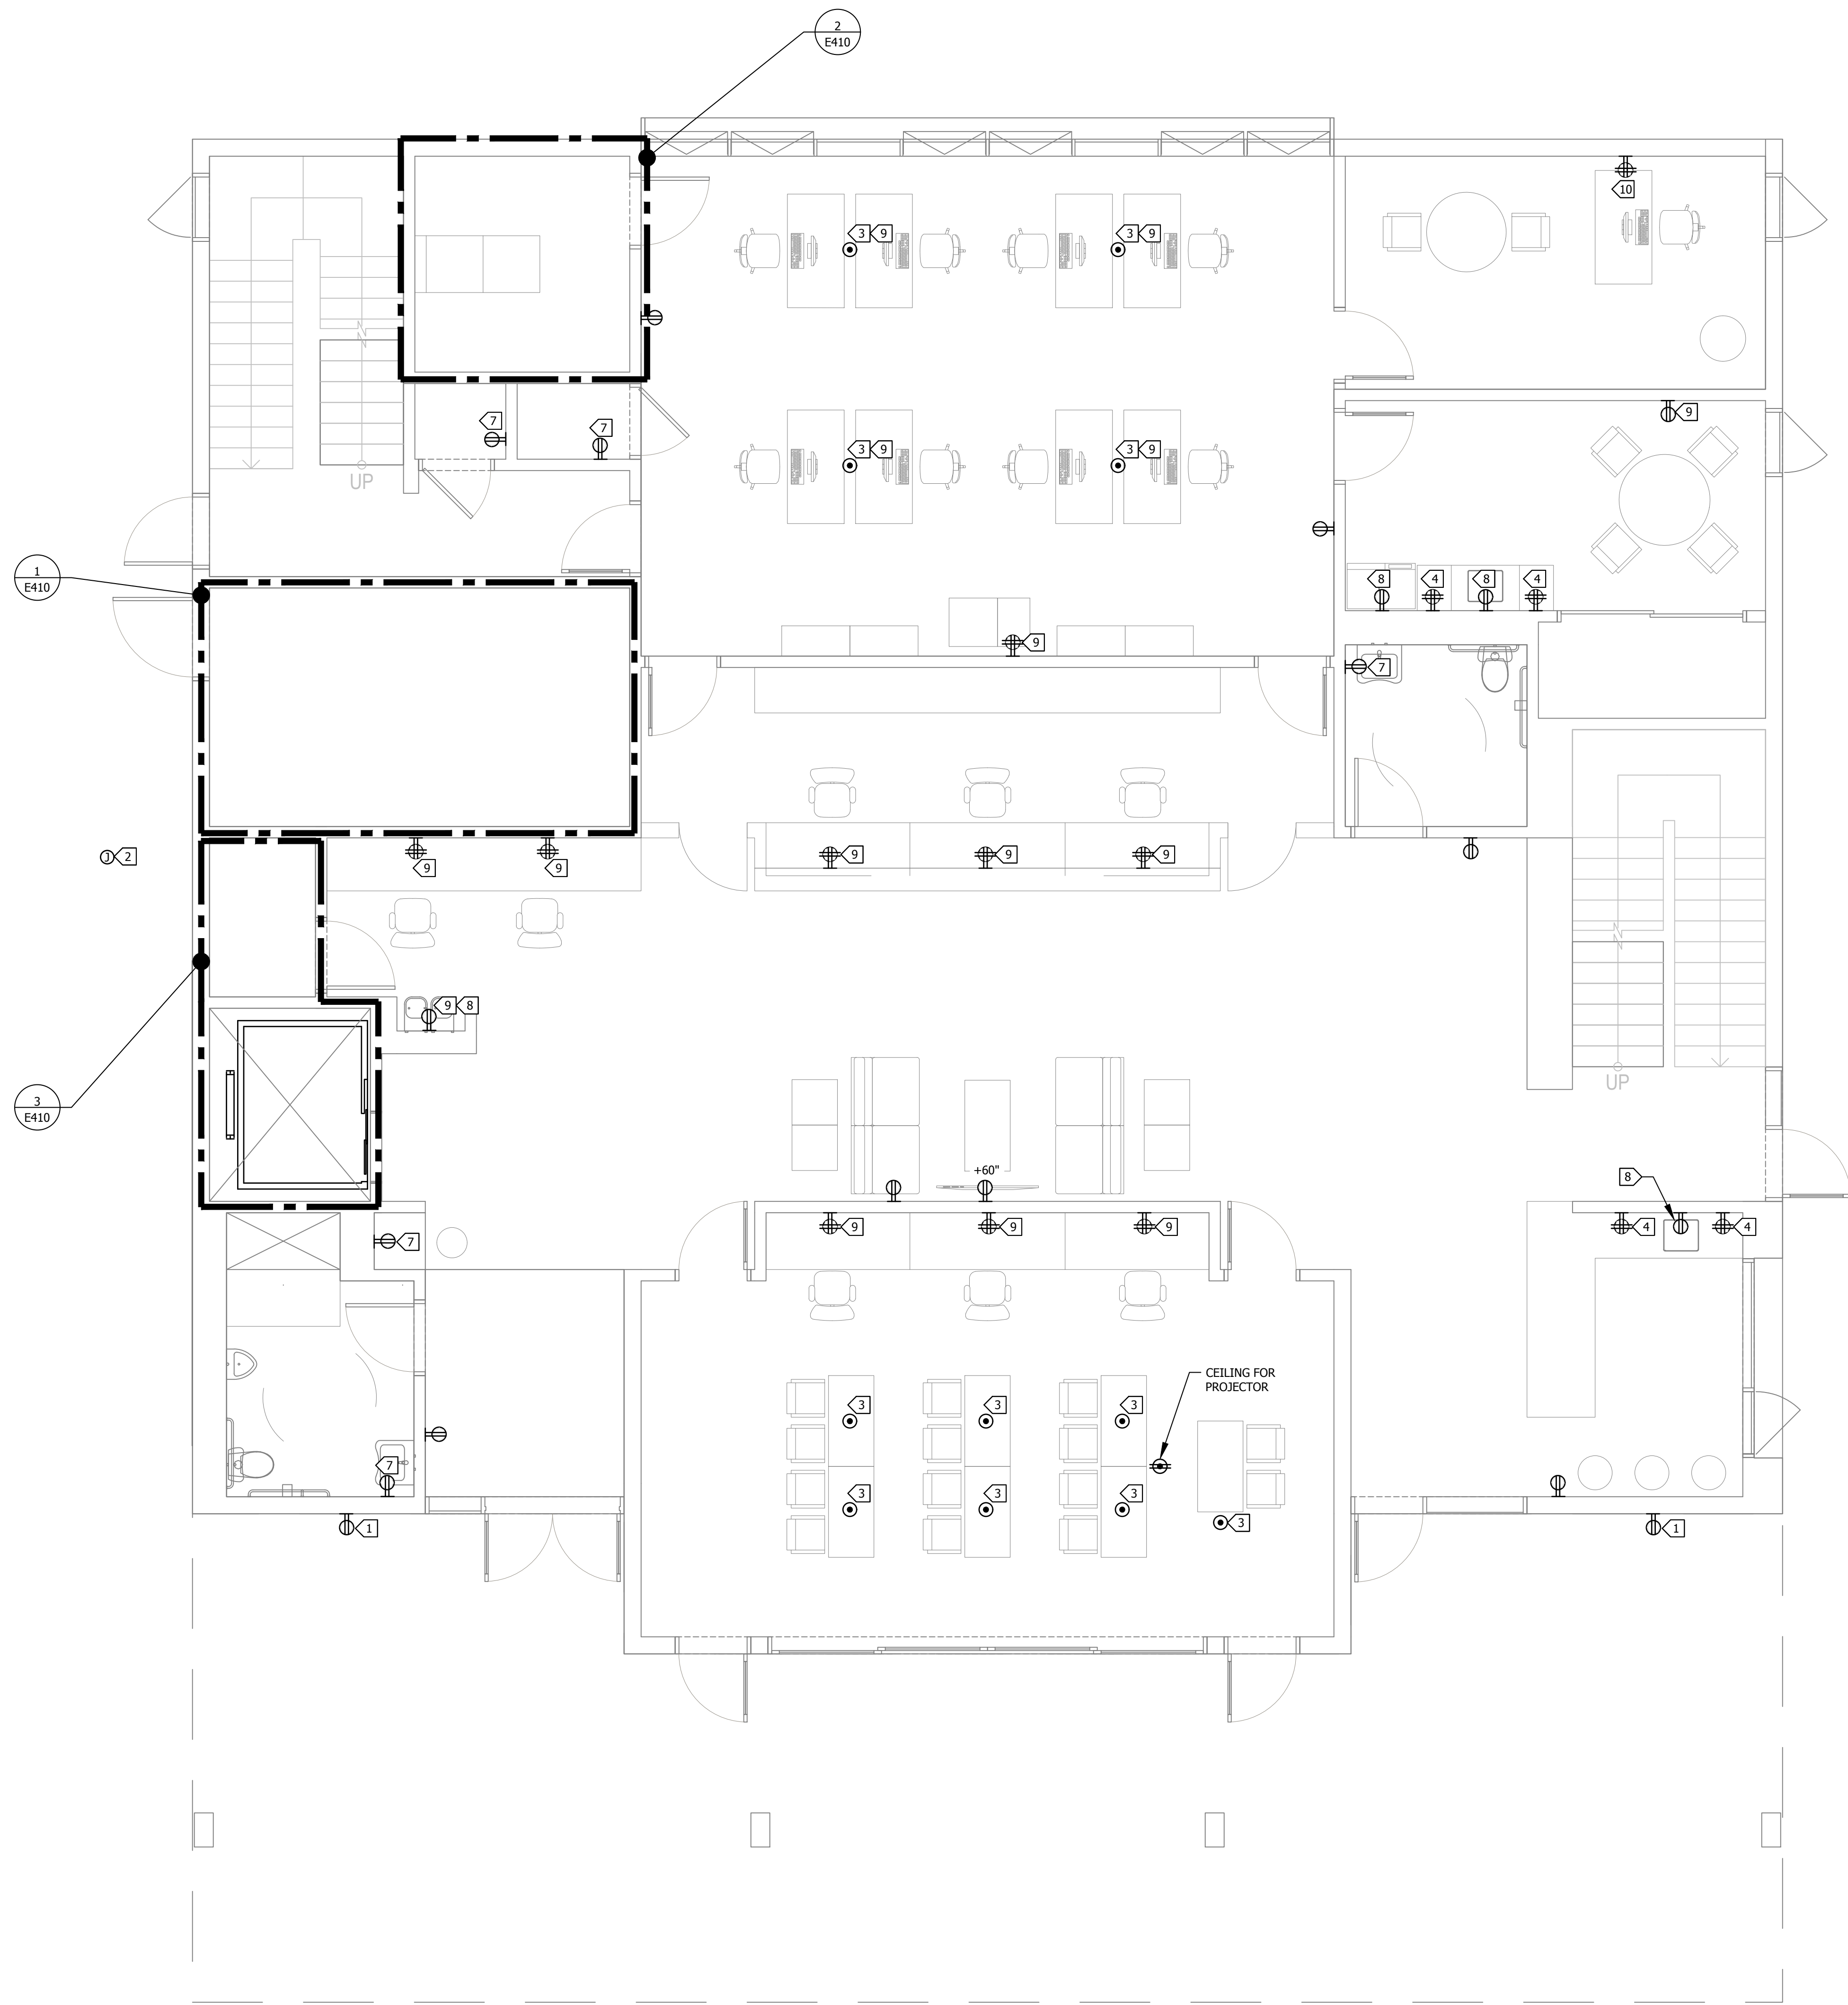SHEET NO.  
E400






SCALE: 1/4"=1'-0"

FIRST LEVEL POWER PLAN  
SCALE: 1/4"=1'-0"

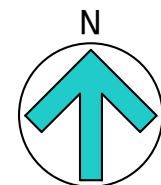1  
- E401



SHEET NOTES:

- CONTRACTOR SHALL FIELD VERIFY LOCATION & REQUIREMENTS OF ALL DEVICES REQUIRING ELECTRICAL CONNECTION PRIOR TO BID PROPOSAL, ROUGH-IN AND FINISH.
- COORDINATE WORK WITH OTHER TRADES. OBTAIN ALL DRAWINGS THAT WILL REQUIRE COORDINATION AND PROVIDE ALL ELECTRICAL CONNECTIONS, DEVICES, AND WIRING REQUIRED WHETHER SHOWN ON ELECTRICAL DRAWINGS OR NOT.
- CONTRACTOR SHALL FURNISH AND INSTALL PULL BOXES AS REQUIRED TO INSTALL CONDUCTORS PER CONDUCTOR MANUFACTURERS RECOMMENDATIONS, PER THE NATIONAL ELECTRICAL CODE AND PER LOCAL AUTHORITIES HAVING JURISDICTION.
- 3/4" CONDUIT MINIMUM U.O.N.
- PROVIDE CODE SIZE EQUIPMENT GROUNDING CONDUCTORS IN ALL OCCUPIED CONDUITS.
- PROVIDE CONTROLS FOR MECHANICAL EQUIPMENT PER MECHANICAL DOCUMENTS. VERIFY LOCATION AND REQUIREMENTS OF MECHANICAL EQUIPMENT ON MECHANICAL DOCUMENTS.
- VERIFY LOCATION OF ALL DEVICES ON ARCHITECTURAL PLANS.
- VERIFY THE EXACT ROUTING OF ALL EXPOSED CONDUIT WITH OWNER PRIOR TO INSTALLATION.
- DO NOT INSTALL RECEPTACLES BACK TO BACK IN WALLS, PROVIDE 18" SEPARATION BETWEEN BOXES & INSTALL PUTTY AROUND BOXES FOR SOUNDPROOFING.

KEY NOTES:

- WP GFCI RECEPTACLE NEMA 5-20R AT 18" AFF WITH LOCKABLE COVER.
- POWER FOR LANDSCAPE CONTROLLER, VERIFY LOCATION WITH LANDSCAPE PLANS.
- FLOOR BOX, HUBBELL SERIES ONE WITH POWER AND COM, DOUBLE DUPLEX.
- GFCI DOUBLE DUPLEX RECEPTACLE NEMA 5-20R @ +42" AFF, 2 CIRCUITS.
- GFCI RECEPTACLE NEMA 5-20R.
- +42" AFF.
- +42" AFF GFCI RECEPTACLE NEMA 5-20R.
- GFCI RECEPTACLE AT 18" AFF.
- DEDICATED 20A 120 VAC CIRCUIT.
- TWO 20A, 120 VAC, DEDICATED CIRCUITS.

PAUL MURDOCH  
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PMA PROJECT NO.  
23-727

DRAWING TITLE  
FIRST LEVEL  
POWER PLAN

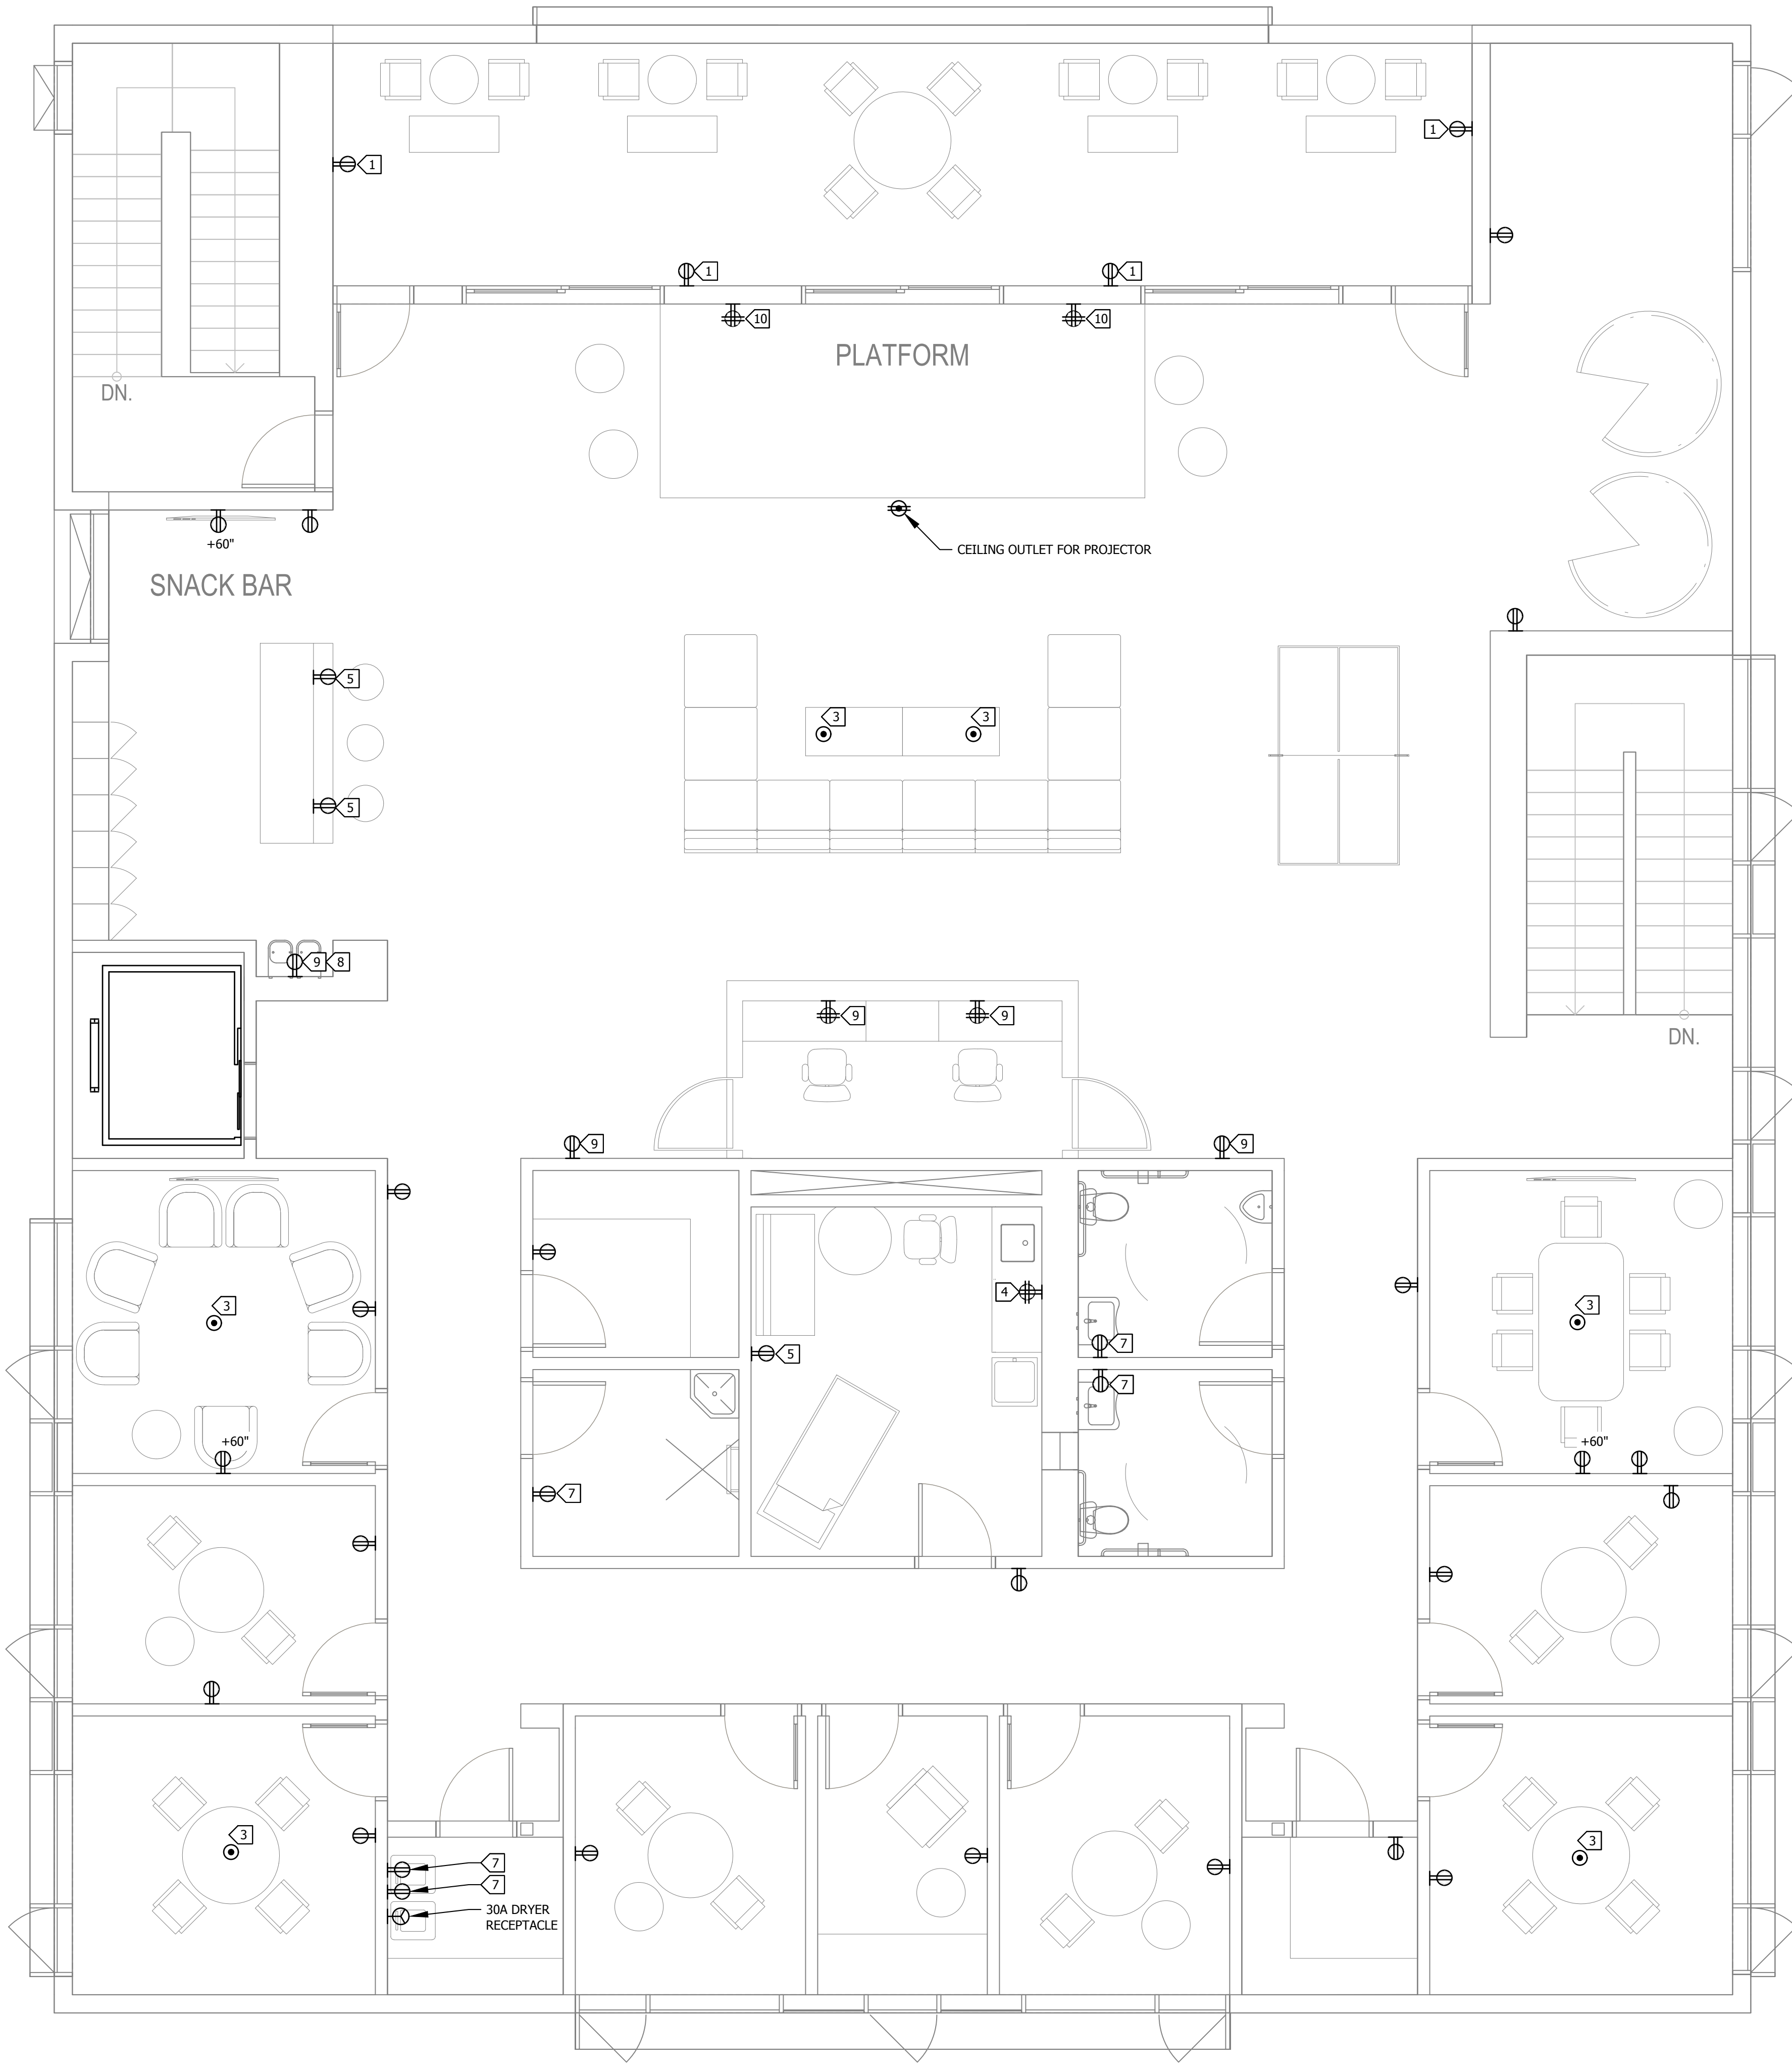
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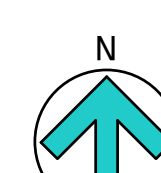


SCALE: 1/4"=1'-0"

## SECOND LEVEL POWER PLAN

SCALE: 1/4"=1'-0"

1  
- E402



### SHEET NOTES:

1. CONTRACTOR SHALL FIELD VERIFY LOCATION & REQUIREMENTS OF ALL DEVICES REQUIRING ELECTRICAL CONNECTION PRIOR TO BID PROPOSAL, ROUGH-IN AND FINISH.
2. COORDINATE WORK WITH OTHER TRADES. OBTAIN ALL DRAWINGS THAT WILL REQUIRE COORDINATION AND PROVIDE ALL ELECTRICAL CONNECTIONS, DEVICES, AND WIRING REQUIRED WHETHER SHOWN ON ELECTRICAL DRAWINGS OR NOT.
3. CONTRACTOR SHALL FURNISH AND INSTALL PULL BOXES AS REQUIRED TO INSTALL CONDUCTORS PER CONDUCTOR MANUFACTURERS RECOMMENDATIONS, PER THE NATIONAL ELECTRICAL CODE AND PER LOCAL AUTHORITIES HAVING JURISDICTION.
4. 3/4" CONDUIT MINIMUM U.O.N.
5. PROVIDE CODE SIZE EQUIPMENT GROUNDING CONDUCTORS IN ALL OCCUPIED CONDUITS.
6. PROVIDE CONTROLS FOR MECHANICAL EQUIPMENT PER MECHANICAL DOCUMENTS. VERIFY LOCATION AND REQUIREMENTS OF MECHANICAL EQUIPMENT ON MECHANICAL DOCUMENTS.
7. VERIFY LOCATION OF ALL DEVICES ON ARCHITECTURAL PLANS.
8. VERIFY THE EXACT ROUTING OF ALL EXPOSED CONDUIT WITH OWNER PRIOR TO INSTALLATION.
9. DO NOT INSTALL RECEPTACLES BACK TO BACK IN WALLS, PROVIDE 18" SEPARATION BETWEEN BOXES & INSTALL PUTTY AROUND BOXES FOR SOUNDPROOFING.

### KEY NOTES:

- 1 WP GFCI RECEPTACLE NEMA 5-20R AT 18" AFF WITH LOCKABLE COVER.
- 2 POWER FOR LANDSCAPE CONTROLLER, VERIFY LOCATION WITH LANDSCAPE PLANS.
- 3 FLOOR BOX, HUBBELL SERIES ONE WITH POWER AND COM, DOUBLE DUPLEX.
- 4 GFCI DOUBLE DUPLEX RECEPTACLE NEMA 5-20R @ +42" AFF, 2 CIRCUITS.
- 5 GFCI RECEPTACLE NEMA 5-20R.
- 6 +42" AFF.
- 7 +42" AFF GFCI NEMA 5-20R.
- 8 GFCI RECEPTACLE AT 18" AFF.
- 9 DEDICATED 20A 120 VAC CIRCUIT.
- 10 TWO 20A, 120 VAC, DEDICATED CIRCUITS.



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PMA PROJECT NO.  
23-727

DRAWING TITLE

**SECOND LEVEL  
POWER PLAN**

SCALE  
AS NOTED

DATE  
02-28-2024

DRAWN CHECKED  
D.S./L.K. K.L.

SHEET NO.

**E402**







ELECTRICAL SCHEDULE FOR MECHANICAL EQUIPMENT												
TAG #	DESCRIPTION	H.P.	FLA	MAX OCP	VOLTAGE	PHASE	NEMA STARTER SIZE OR VFD	DISCONNECT	RECOMMENDED FUSE SIZE/TYPE *	REMARKS	PANEL/CIRCUIT NO.	FEEDER
HP1	HEAT PUMP #1 FOR FIRST FLOOR	..	30.9	40	208	3	N/A	60A/3P	40	4	MP-1-3-5	3/4"C - 3#8 & 1#10 GND
HP2	HEAT PUMP #2 FOR SECOND FLOOR	..	22.6	35	208	3	N/A	60A/3P	35	4	MP-7-9-11	3/4"C - 3#10 & 1#10 GND
HP3	HEAT PUMP #3 FOR THIRD FLOOR	..	28.5	40	208	3	N/A	60A/3P	40	4	MP-13-15-17	3/4"C - 3#8 & 1#10 GND
FC1.1	FAN COIL 1.1	..	1.6	15	208	1	N/A	MOTOR RATED SWITCH	N/A	4	MP-19-21	3/4"C - 2#12 & 1#12 GND
FC1.2	FAN COIL 1.2	..	2.3	15	208	1	N/A	MOTOR RATED SWITCH	N/A	4	MP-19-21	3/4"C - 2#12 & 1#12 GND
FC1.3	FAN COIL 1.3	..	2.3	15	208	1	N/A	MOTOR RATED SWITCH	N/A	4	MP-23-25	3/4"C - 2#12 & 1#12 GND
FC1.4	FAN COIL 1.4	..	1.6	15	208	1	N/A	MOTOR RATED SWITCH	N/A	4	MP-23-25	3/4"C - 2#12 & 1#12 GND
FC1.5	FAN COIL 1.5	..	.4	15	208	1	N/A	MOTOR RATED SWITCH	N/A	4	MP-23-25	3/4"C - 2#12 & 1#12 GND
FC1.6	FAN COIL 1.6	..	.4	15	208	1	N/A	MOTOR RATED SWITCH	N/A	4	MP-23-25	3/4"C - 2#12 & 1#12 GND
FC1.7	FAN COIL 1.7	..	.4	15	208	1	N/A	MOTOR RATED SWITCH	N/A	4	MP-27-29	3/4"C - 2#12 & 1#12 GND
FC2.1	FAN COIL 2.1	..	.4	15	208	1	N/A	MOTOR RATED SWITCH	N/A	4	MP-27-29	3/4"C - 2#12 & 1#12 GND
FC2.2	FAN COIL 2.2	..	.4	15	208	1	N/A	MOTOR RATED SWITCH	N/A	4	MP-27-29	3/4"C - 2#12 & 1#12 GND
FC2.3	FAN COIL 2.3	..	.4	15	208	1	N/A	MOTOR RATED SWITCH	N/A	4	MP-27-29	3/4"C - 2#12 & 1#12 GND
FC2.4	FAN COIL 2.4	..	.4	15	208	1	N/A	MOTOR RATED SWITCH	N/A	4	MP-27-29	3/4"C - 2#12 & 1#12 GND
FC2.5	FAN COIL 2.5	..	.4	15	208	1	N/A	MOTOR RATED SWITCH	N/A	4	MP-27-29	3/4"C - 2#12 & 1#12 GND
FC2.6	FAN COIL 2.6	..	.4	15	208	1	N/A	MOTOR RATED SWITCH	N/A	4	MP-31-33	3/4"C - 2#12 & 1#12 GND
FC2.7	FAN COIL 2.7	..	.4	15	208	1	N/A	MOTOR RATED SWITCH	N/A	4	MP-31-33	3/4"C - 2#12 & 1#12 GND
FC2.8	FAN COIL 2.8	..	.4	15	208	1	N/A	MOTOR RATED SWITCH	N/A	4	MP-31-33	3/4"C - 2#12 & 1#12 GND
FC2.9	FAN COIL 2.9	..	.4	15	208	1	N/A	MOTOR RATED SWITCH	N/A	4	MP-31-33	3/4"C - 2#12 & 1#12 GND
FC2.10	FAN COIL 2.10	..	.4	15	208	1	N/A	MOTOR RATED SWITCH	N/A	4	MP-31-33	3/4"C - 2#12 & 1#12 GND
FC2.11	FAN COIL 2.11	..	2.3	15	208	1	N/A	MOTOR RATED SWITCH	N/A	4	MP-35-37	3/4"C - 2#12 & 1#12 GND
FC2.12	FAN COIL 2.12	..	2.3	15	208	1	N/A	MOTOR RATED SWITCH	N/A	4	MP-35-37	3/4"C - 2#12 & 1#12 GND
FC2.13	FAN COIL 2.13	..	1.6	15	208	1	N/A	MOTOR RATED SWITCH	N/A	4	MP-39-41	3/4"C - 2#12 & 1#12 GND
FC2.14	FAN COIL 2.14	..	1.6	15	208	1	N/A	MOTOR RATED SWITCH	N/A	4	MP-39-41	3/4"C - 2#12 & 1#12 GND
EF1	EXHAUST FAN 1	.2	..	..	120	1	N/A	MOTOR RATED SWITCH	N/A	4	MP-2	3/4"C - 2#12 & 1#12 GND
EF2	EXHAUST FAN 2	.2	..	..	120	1	N/A	MOTOR RATED SWITCH	N/A	4	MP-4	3/4"C - 2#12 & 1#12 GND
EF3	EXHAUST FAN 3	.1	..	..	120	1	N/A	MOTOR RATED SWITCH	N/A	4	MP-6	3/4"C - 2#12 & 1#12 GND
SF1	SUPPLY FAN 1	.2	..	..	120	1	N/A	MOTOR RATED SWITCH	N/A	4	MP-8	3/4"C - 2#12 & 1#12 GND
SF2	SUPPLY FAN 2	.2	..	..	120	1	N/A	MOTOR RATED SWITCH	N/A	4	MP-10	3/4"C - 2#12 & 1#12 GND
WH-1	WATER HEATER	..	10	15	120	1	N/A	MOTOR RATED SWITCH	N/A	4	MP-12	3/4"C - 2#12 & 1#12 GND
* ALL FUSES BY BUSSMAN AND SHALL BE SIZED PER MANUFACTURERS RECOMMENDATION.												

- SHEET NOTES:
1.

FIELD VERIFY MECHANICAL EQUIPMENT LOCATIONS.
2.

SEE ELECTRICAL SCHEDULE FOR MECHANICAL EQUIPMENT FOR ELECTRICAL REQUIREMENTS.
3.

ALL WORK SHALL BE COORDINATED WITH OTHER TRADES.
4.

THE LOCATION OF ALL ROOF PENETRATIONS SHALL BE COORDINATED WITH THE ARCHITECTURAL, MECHANICAL, AND STRUCTURAL DRAWINGS.
5.

PROVIDE ROOF JACKS AND PROPERLY SEAL ALL ROOF PENETRATIONS TO A LEAK FREE CONDITION.
6.

THE FINAL CONNECTIONS TO EQUIPMENT SHALL BE LIQUIDTIGHT FLEXIBLE METAL CONDUIT. INSTALL WITH ENOUGH SLACK TO PRECLUDE VIBRATION TRANSMISSION. SUPPORT SHALL BE PER N.E.C. ARTICLE 351-8
7.

PROVIDE WEATHERPROOF AND EXTERIOR RATED DEVICES IN ALL EXTERIOR AREAS.
8.

PROVIDE ALL DEVICES AS REQUIRED ON MECHANICAL CONTRACTOR SHOP DRAWINGS AND APPROVED SUBMITTALS.
9.

NO CONDUIT/FEEDER SHALL BE PERMITTED ON THE ROOF WITH CRIPPLES,ALL FEEDERS SHALL BE RUN BENEATH THE ROOF.
10.

ALL DISCONNECTS SHALL BE MOUNTED ON UNISTRUT ON AH UNIT.
11.

CONTRACTOR SHALL VERIFY LOCATION & REQUIREMENTS OF ALL ELECTRICAL DEVICES PRIOR TO BID, ROUGH-IN & INSTALLATION.
12.

CONTRACTOR SHALL, IN ROUTING ALL CIRCUITS, INCREASE CONDUCTOR & CONDUIT SIZE TO ALLOW FOR VOLTAGE DROP SHOULD THE CONTRACTOR EXCEED ROUTING INDICATED ON DRAWING. ENGINEER OF RECORD MUST BE NOTIFIED PRIOR TO ANY DEVIATIONS FROM APPROVED PLAN CHECK (PERMIT SET) DRAWINGS.
13.

EACH DISCONNECT OR STARTER AND A SPARE SET OF FUSES SHALL BE CONTRACTOR PROVIDED.

- KEY NOTES:
- 1

FOR FEEDER AND DISCONNECT INFORMATION SEE ELECTRICAL SCHEDULE FOR MECHANICAL EQUIPMENT THIS SHEET.
- 2

PROVIDE 3/4"C & CONTROLS PER MECHANICAL.
- 3

W.P. GFCL RECEPTACLE
- 4

SEE MECHANICAL PLANS FOR CONTROLS, CONNECTIONS, & INSTALLATION REQUIREMENTS.

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HEALTH DISTRICT

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PMA PROJECT NO.

23-727

DRAWING TITLE

ELECTRICAL  
SCHEDULE FOR  
MECHANICAL  
EQUIPMENT

SCALE

AS NOTED

DATE

02-28-2024

DRAWN

CHECKED

D.S./L.K.

K.L.

SHEET NO.

E420

Drawn: CM01, PMA Proj: 23-727  
Rev: 02/28/24, LK  
02/28/24 10:46 AM  
02/28/24 10:46 AM  
02/28/24 10:46 AM

Drafter: CM01, G:\23\727\EL\Sheets\23-727 E420.dwg, DATE: 02-18-2024, TIME: 9:49 AM

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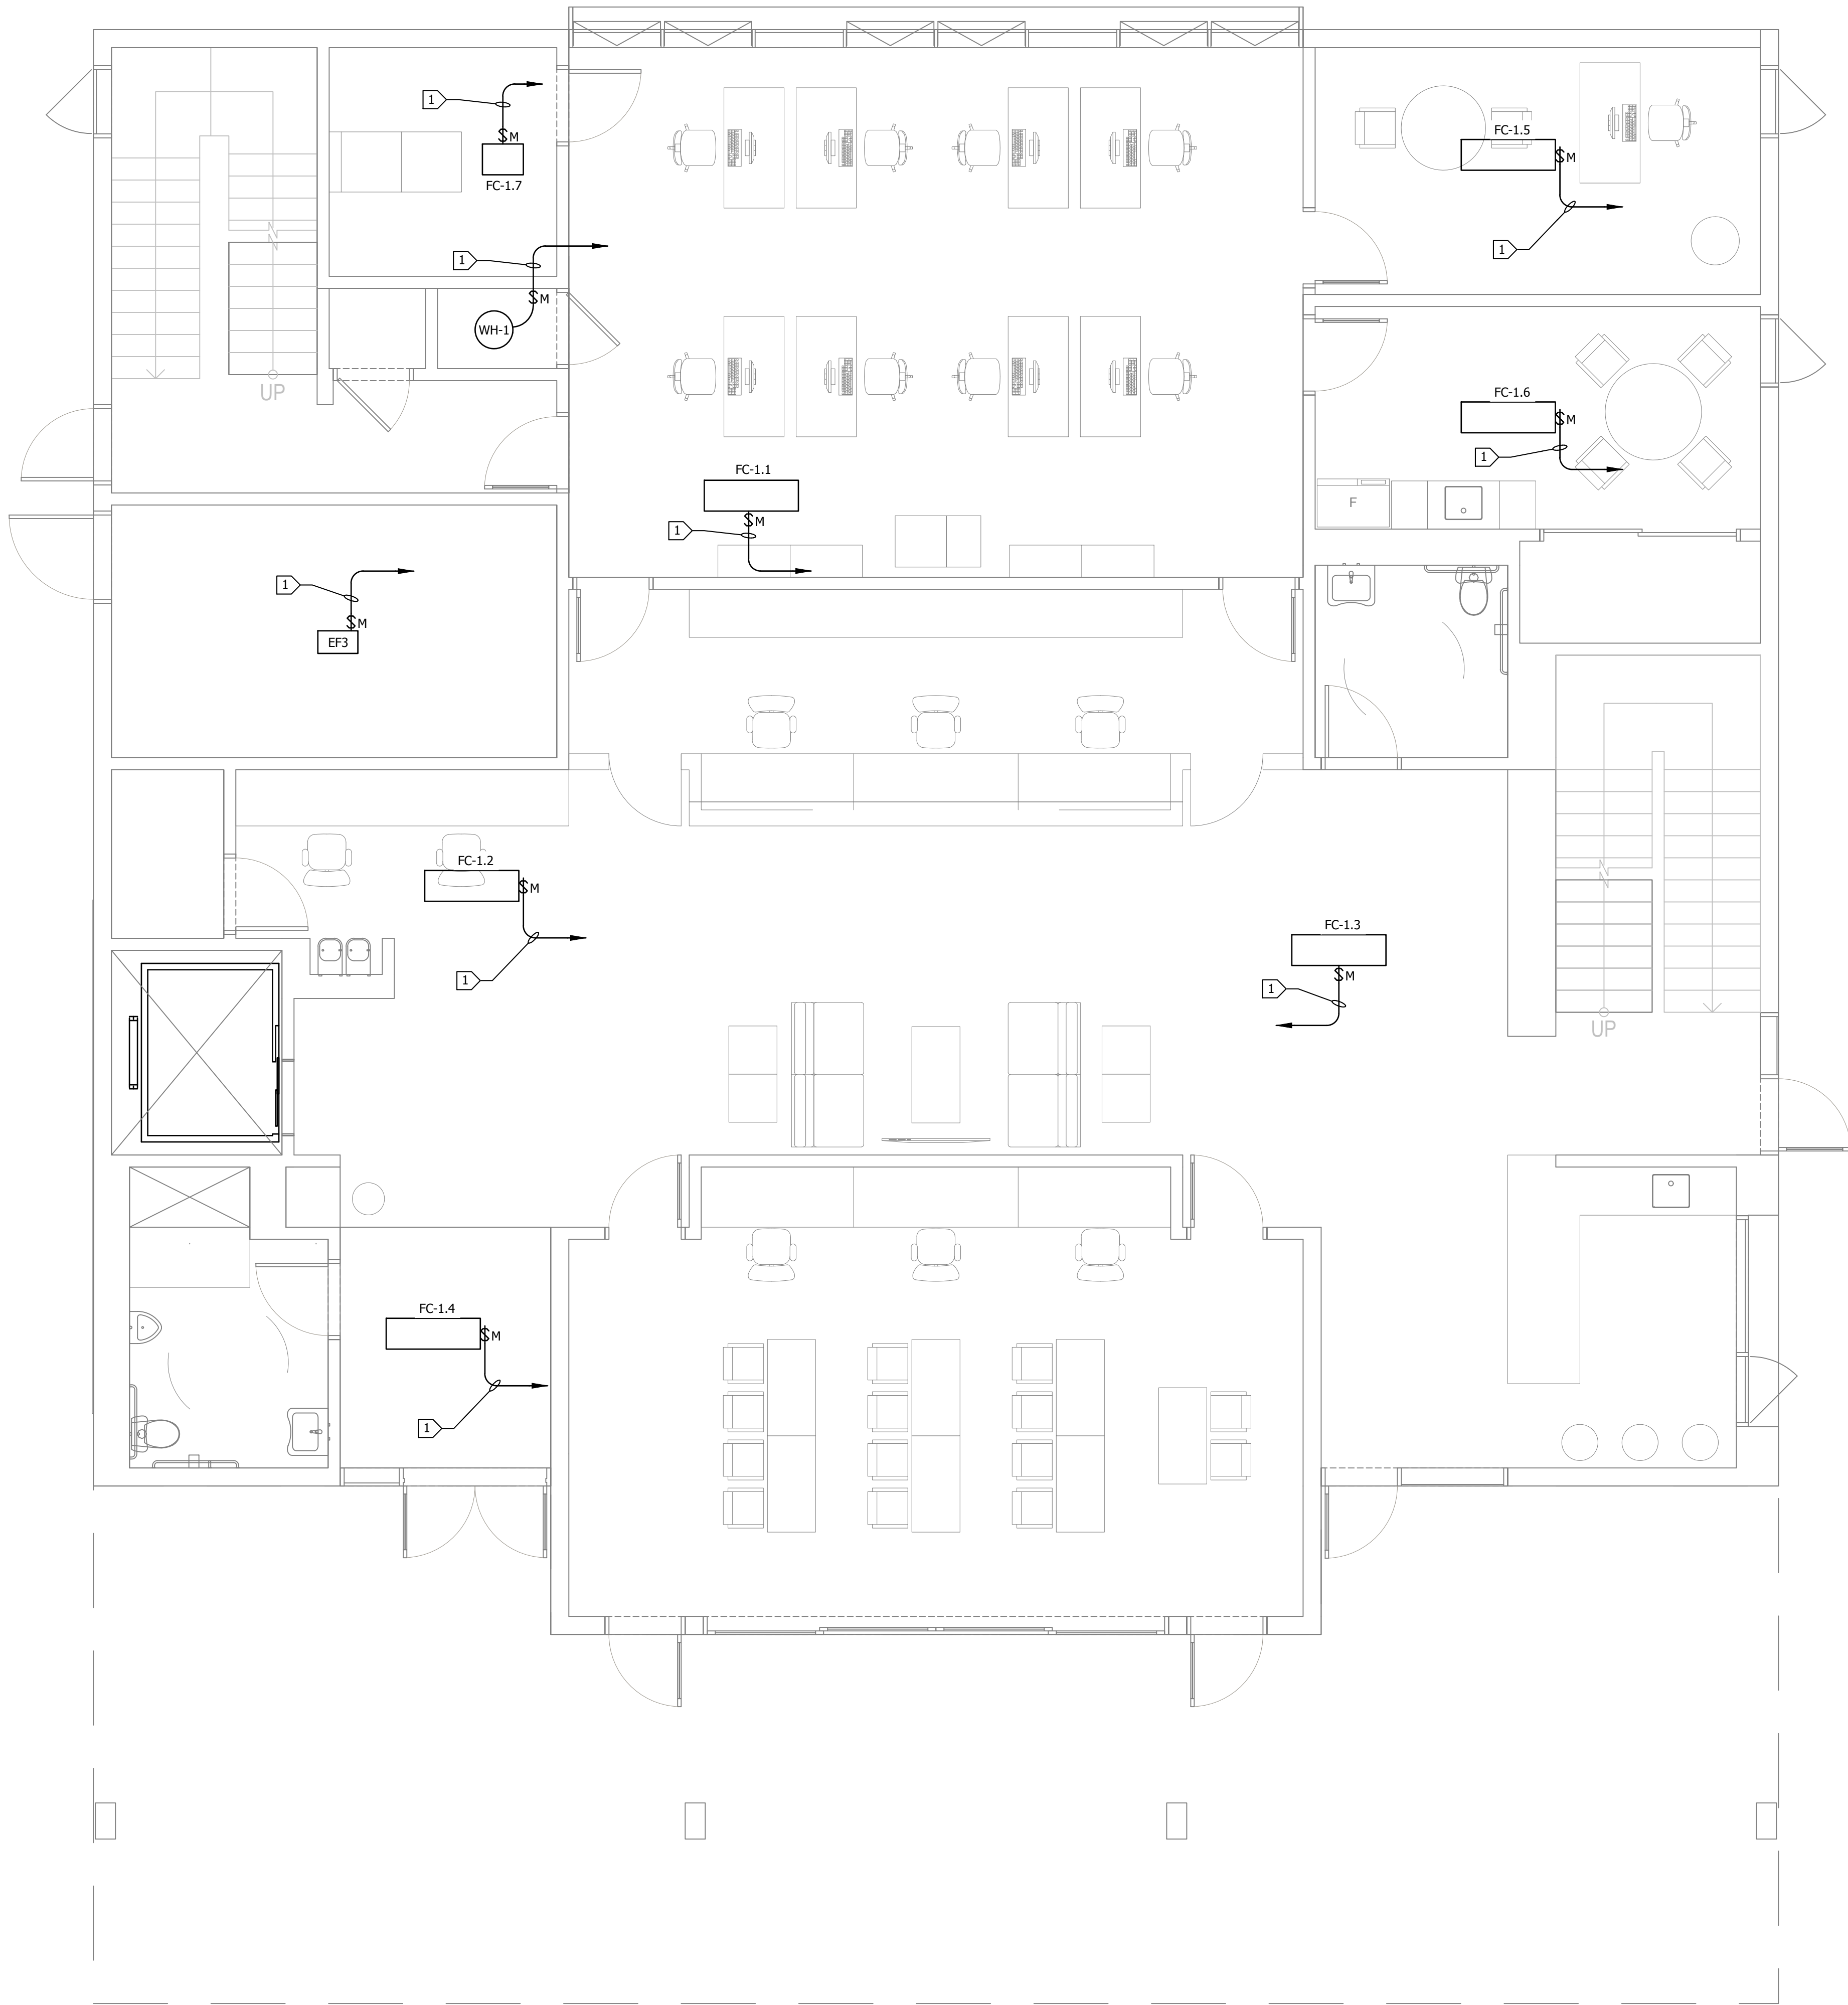
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DATE: 27 February 2024  
TIME: 3:35 pm  
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DRAFTER: CM01


Drawn: CM01, PMA Proj: 23-727  
Rev: 23-04-24, 1:00 pm  
PMA Project: 23-727  
PMA Project: 23-727  
PMA Project: 23-727



# FIRST LEVEL MECHANICAL POWER PLAN

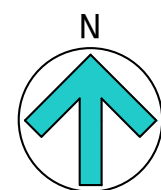SCALE: 1/4"=1'-0"

1  
- E421  
-



## SHEET NOTES:

- COORDINATE MECHANICAL EQUIPMENT LOCATIONS.
- SEE ELECTRICAL SCHEDULE PER MECHANICAL EQUIPMENT FOR ELECTRICAL REQUIREMENTS.
- ALL WORK SHALL BE COORDINATED WITH OTHER TRADES.
- THE LOCATION OF ALL ROOF PENETRATIONS SHALL BE COORDINATED WITH THE ARCHITECTURAL, MECHANICAL, AND STRUCTURAL DRAWINGS.
- THE FINAL CONNECTIONS TO EQUIPMENT SHALL BE LIQUIDTIGHT FLEXIBLE METAL CONDUIT. INSTALL WITH ENOUGH SLACK TO PRECLUDE VIBRATION TRANSMISSION. SUPPORT SHALL BE PER N.E.C. ARTICLE 351-6.
- PROVIDE WEATHERPROOF AND EXTERIOR RATED DEVICES IN ALL EXTERIOR AREAS.
- PROVIDE ALL DEVICES AS REQUIRED ON MECHANICAL CONTRACTOR SHOP DRAWINGS AND APPROVED SUBMITTALS.
- NO CONDUIT/FEEDER SHALL BE PERMITTED ON THE ROOF WITH CRIPPLES, ALL FEEDERS SHALL BE RUN BENEATH THE ROOF.
- ALL DISCONNECTS SHALL BE MOUNTED ON UNISTRUT ON AH OR EF UNITS.
- CONTRACTOR SHALL VERIFY LOCATION & REQUIREMENTS OF ALL ELECTRICAL DEVICES PRIOR TO BID, ROUGH-IN & INSTALLATION.
- CONTRACTOR SHALL, IN ROUTING ALL CIRCUITS, INCREASE CONDUCTOR & CONDUIT SIZE TO ALLOW FOR VOLTAGE DROP SHOULD THE CONTRACTOR EXCEED ROUTING INDICATED ON DRAWING. ENGINEER OF RECORD MUST BE NOTIFIED PRIOR TO ANY DEVIATIONS FROM APPROVED PLAN CHECK (PERMIT SET) DRAWINGS.
- EACH DISCONNECT OR STARTER AND A SPARE SET OF FUSES SHALL BE CONTRACTOR PROVIDED.

## KEY NOTES:

- 1 HOME RUN & CONTROLS PER E420 & MECHANICAL PLANS.



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PMA PROJECT NO. 23-727  
DRAWING TITLE: FIRST LEVEL MECHANICAL POWER PLAN  
100% PRELIMINARY DESIGN SUBMITTAL

NO. DATE REVISION

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BEACH CITIES  
HEALTH DISTRICT

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DESIGN SUBMITTAL

PMA PROJECT NO.  
23-727

DRAWING TITLE

**FIRST LEVEL  
MECHANICAL POWER  
PLAN**

SCALE  
AS NOTED

DATE  
02-28-2024

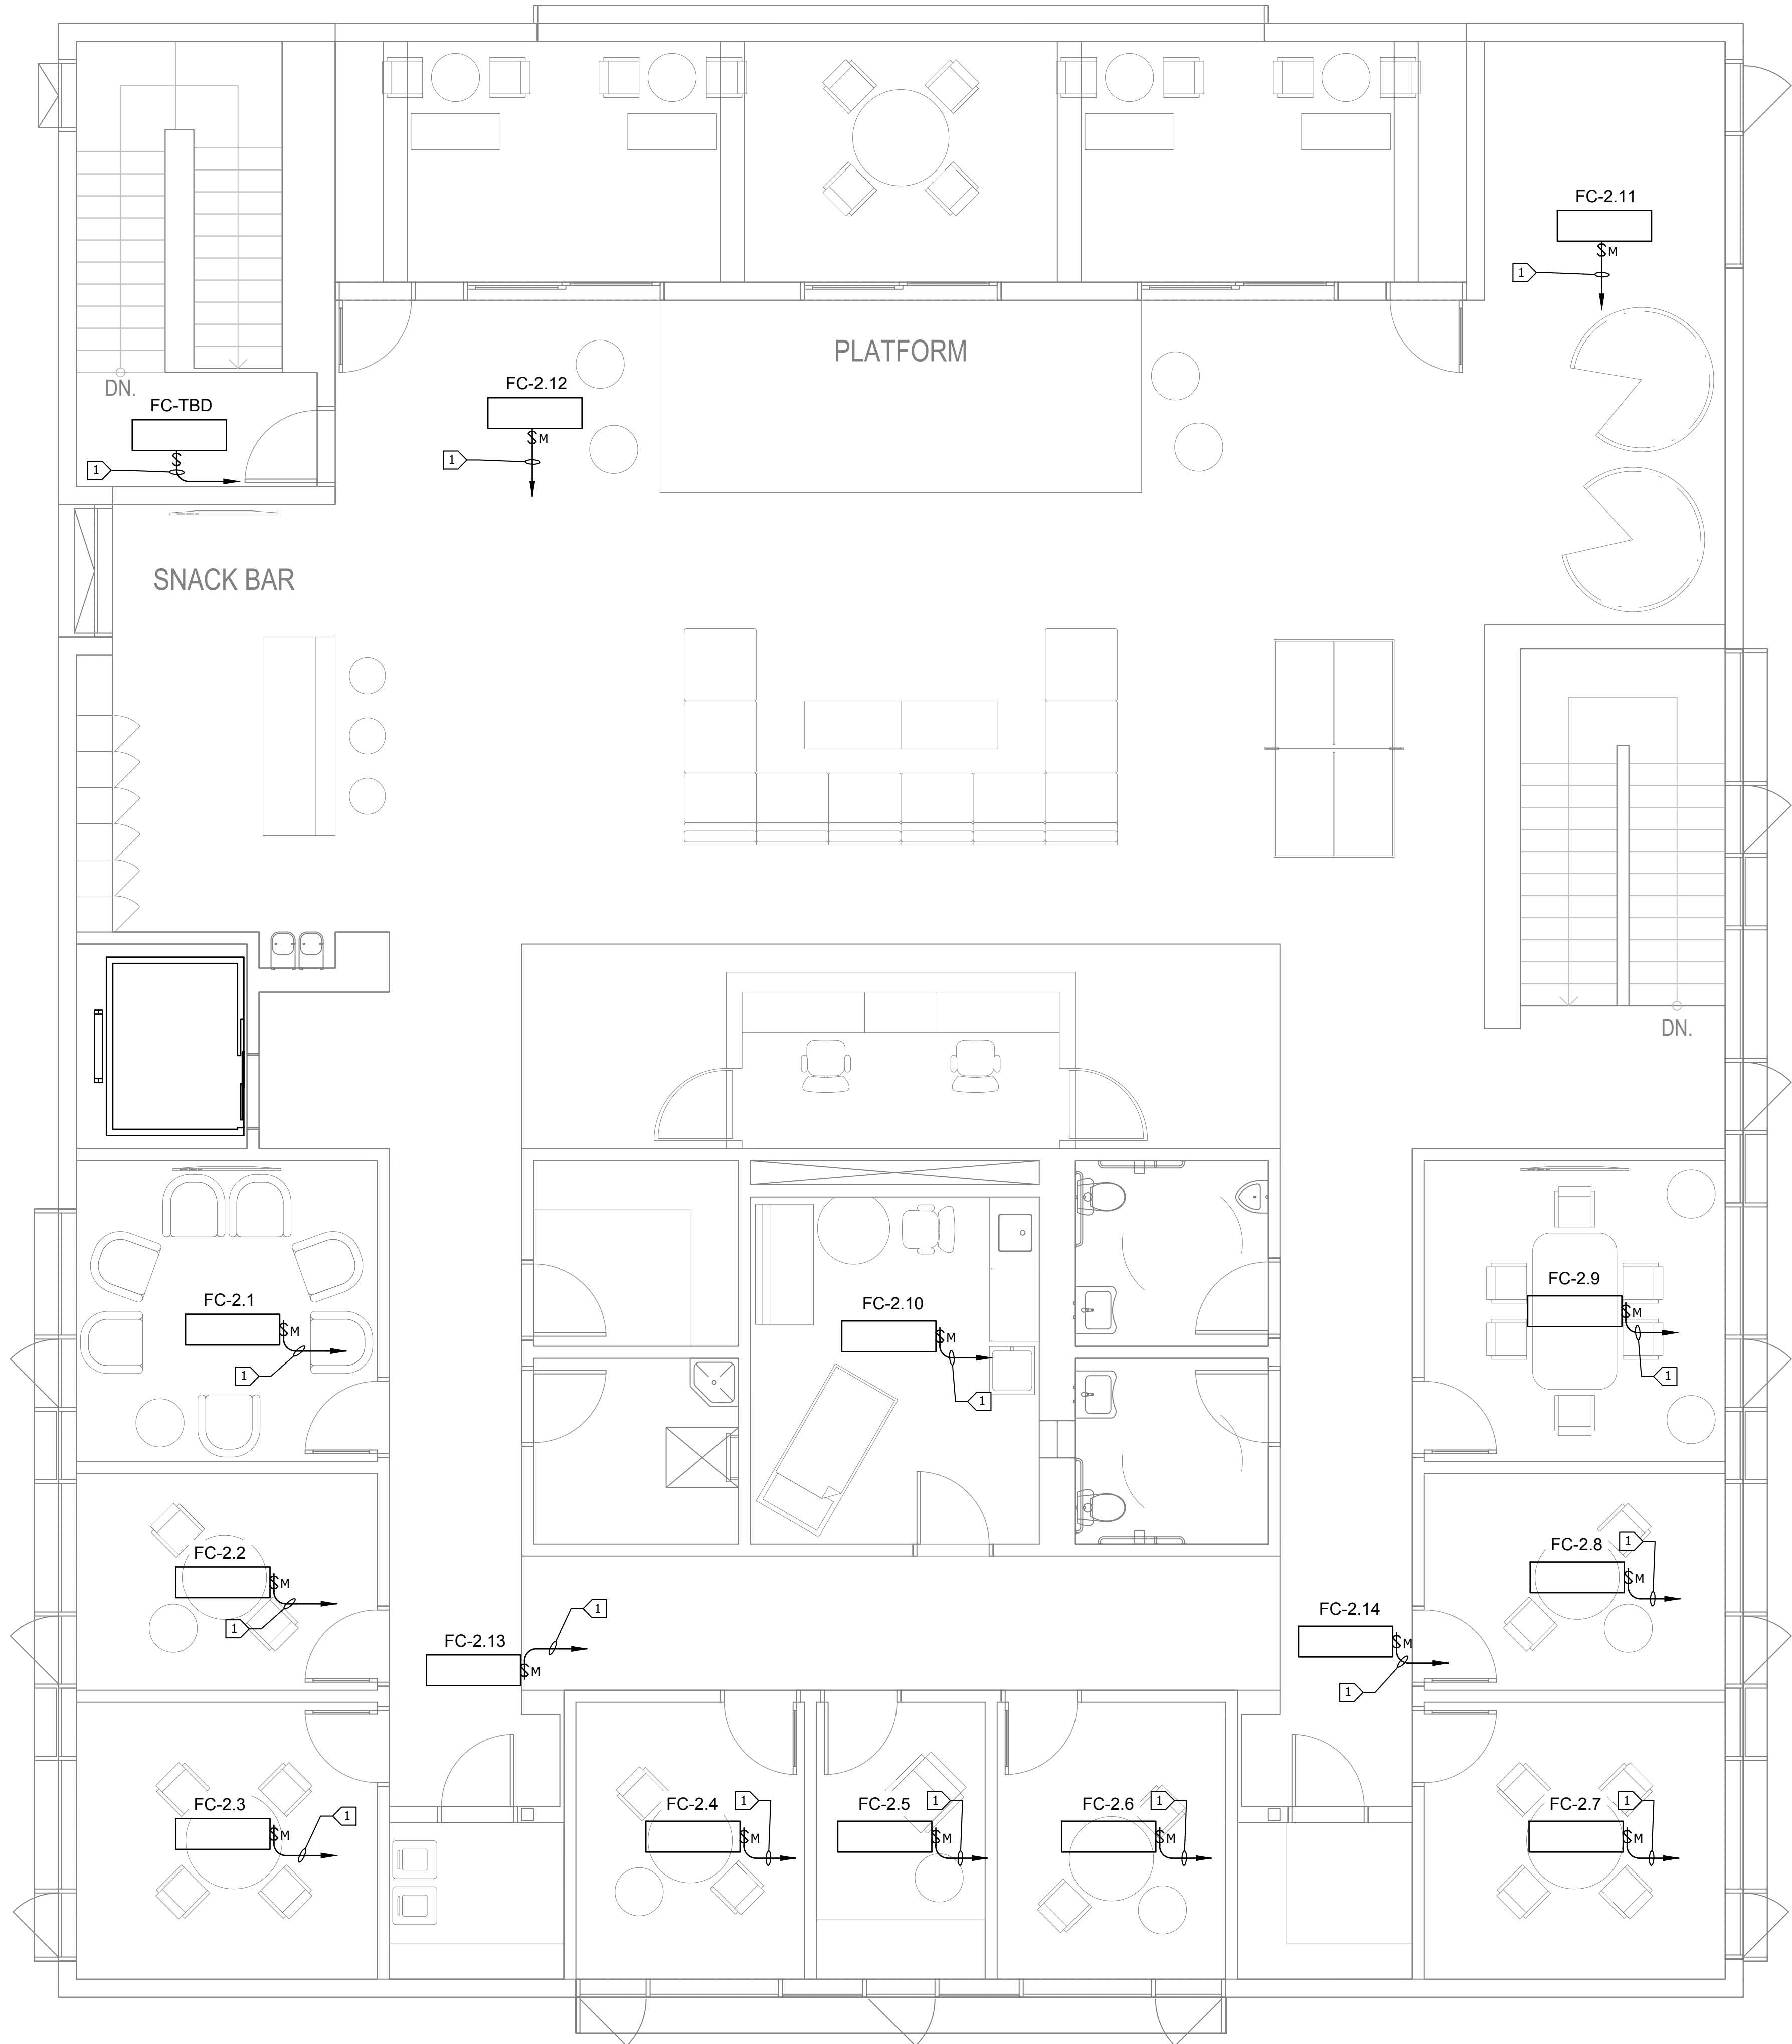
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D.S./L.K. K.L.

SHEET NO.

**E421**



DATE: 27 February 2024  
TIME: 3:35 pm  
PATHNAME: G:\23\727\EL\Sheets  
DRAWING FILENAME: 23-727 E422  
DRAFTER: CM01



SECOND LEVEL MECHANICAL POWER PLAN  
SCALE: 1/4"=1'-0"

- SHEET NOTES:**
- COORDINATE MECHANICAL EQUIPMENT LOCATIONS.
  - SEE ELECTRICAL SCHEDULE PER MECHANICAL EQUIPMENT FOR ELECTRICAL REQUIREMENTS.
  - ALL WORK SHALL BE COORDINATED WITH OTHER TRADES.
  - THE LOCATION OF ALL ROOF PENETRATIONS SHALL BE COORDINATED WITH THE ARCHITECTURAL, MECHANICAL, AND STRUCTURAL DRAWINGS.
  - THE FINAL CONNECTIONS TO EQUIPMENT SHALL BE LIQUDTIGHT FLEXIBLE METAL CONDUIT. INSTALL WITH ENOUGH SLACK TO PRECLUDE VIBRATION TRANSMISSION. SUPPORT SHALL BE PER N.E.C. ARTICLE 351-8.
  - PROVIDE WEATHERPROOF AND EXTERIOR RATED DEVICES IN ALL EXTERIOR AREAS.
  - PROVIDE ALL DEVICES AS REQUIRED ON MECHANICAL CONTRACTOR SHOP DRAWINGS AND APPROVED SUBMITTALS.
  - NO CONDUIT/FEEDER SHALL BE PERMITTED ON THE ROOF WITH CRIPPLES, ALL FEEDERS SHALL BE RUN BENEATH THE ROOF.
  - ALL DISCONNECTS SHALL BE MOUNTED ON UNISTRUT ON AH OR EF UNITS.
  - CONTRACTOR SHALL VERIFY LOCATION & REQUIREMENTS OF ALL ELECTRICAL DEVICES PRIOR TO BID, ROUGH-IN & INSTALLATION.
  - CONTRACTOR SHALL, IN ROUTING ALL CIRCUITS, INCREASE CONDUCTOR & CONDUIT SIZE TO ALLOW FOR VOLTAGE DROP SHOULD THE CONTRACTOR EXCEED ROUTING INDICATED ON DRAWING. ENGINEER OF RECORD MUST BE NOTIFIED PRIOR TO ANY DEVIATIONS FROM APPROVED PLAN CHECK (PERMIT SET) DRAWINGS.
  - EACH DISCONNECT OR STARTER AND A SPARE SET OF FUSES SHALL BE CONTRACTOR PROVIDED.

**KEY NOTES:**

1 HOME RUN & CONTROLS PER E420 & MECHANICAL PLANS.

**PAUL MURDOCH  
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PMA PROJECT NO.  
23-727

DRAWING TITLE  
SECOND LEVEL  
MECHANICAL POWER  
PLAN

SCALE  
AS NOTED

DATE  
02-28-2024

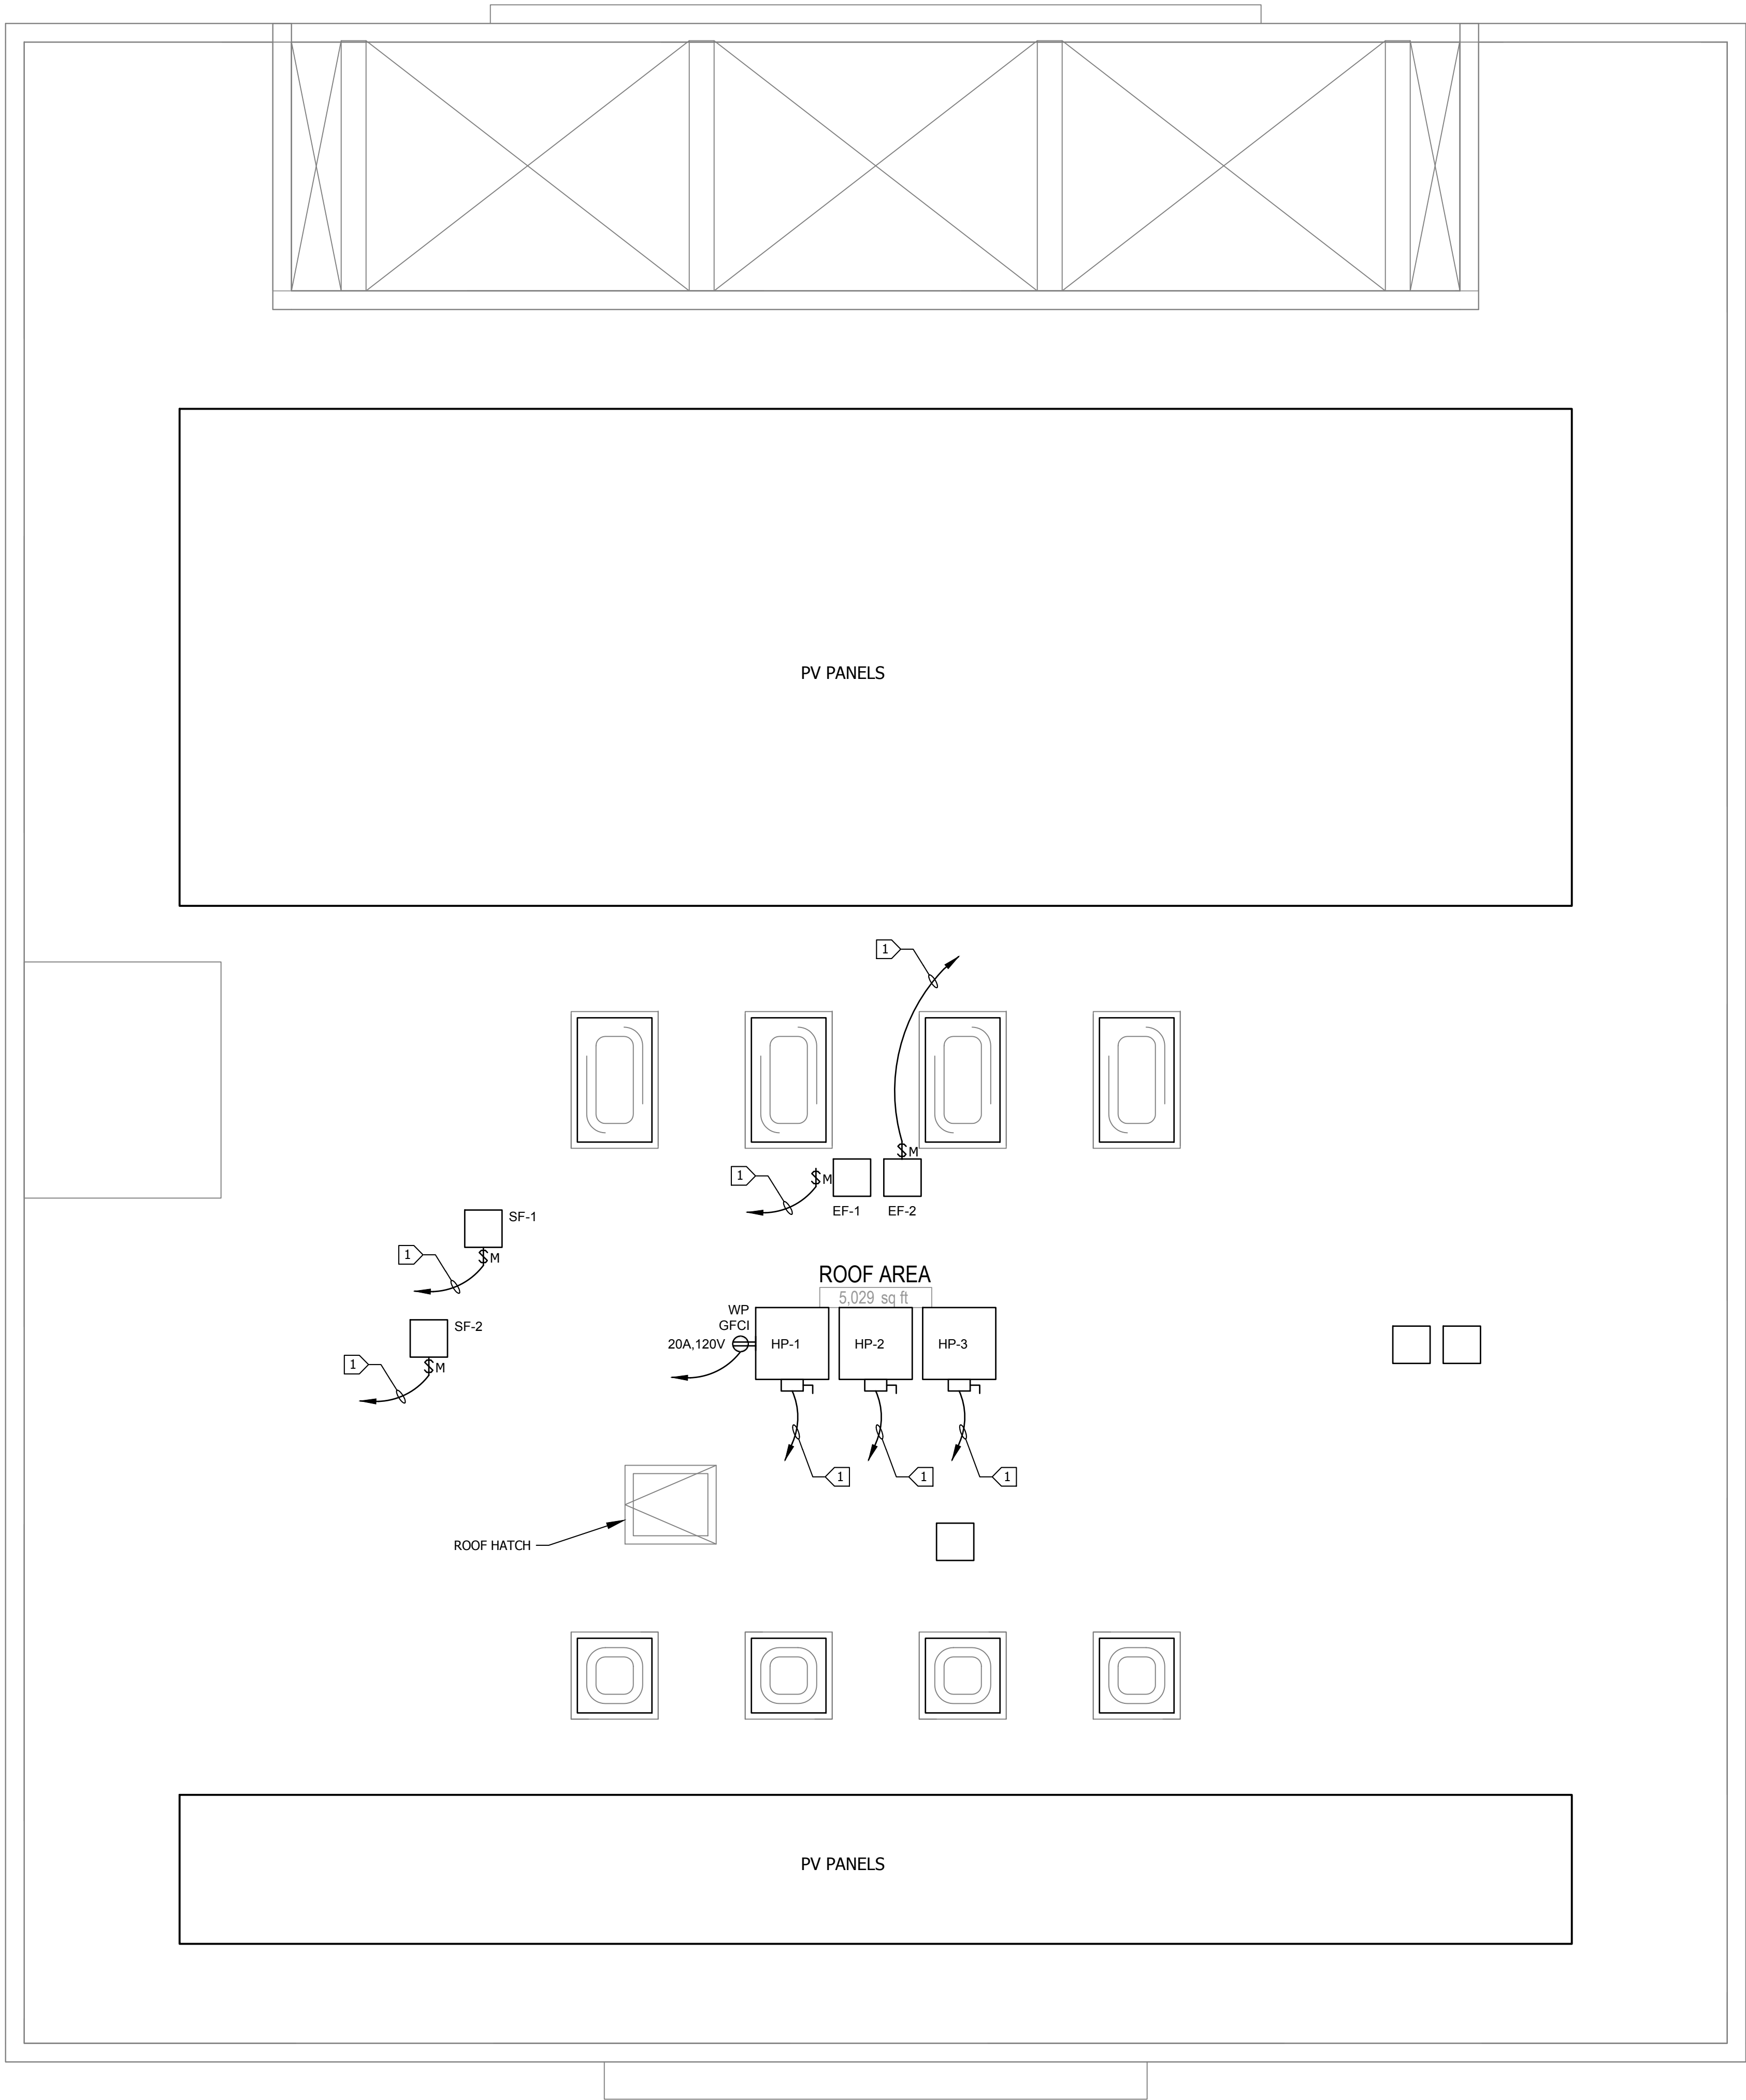
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SHEET NO.  
E422



DATE: 27 February 2024  
PATHNAME: G:\23\727\EL\Sheets  
DRAWING FILENAME: 23-727 E423  
DRAFTER: CN01


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# ROOF POWER PLAN

SCALE: 1/4"=1'-0"

1  
E423



## SHEET NOTES:
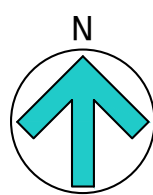
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## KEY NOTES:

- 1 HOME RUN & CONTROLS PER E420 & MECHANICAL PLANS.



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PMA PROJECT NO.  
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DRAWING TITLE  
ROOF POWER PLAN

SCALE  
AS NOTED

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## GENERAL NOTES

1. ALL WORK SHALL CONFORM WITH THE 2022 CALIFORNIA BUILDING CODE, AND ALL LOCAL ORDINANCES.
2. THE CONTRACTOR SHALL VERIFY ALL DIMENSIONS AND CONDITIONS PRIOR TO STARTING CONSTRUCTION AND BRING TO THE ATTENTION OF THE ENGINEER ANY DISCREPANCIES OR INCONSISTENCIES.
3. NO STRUCTURAL MEMBER SHALL BE CUT, NOTCHED, BORED OR OTHER-WISE WEAKENED EXCEPT AS ALLOWED BY THE CALIFORNIA BUILDING CODE OR APPROVED BY THE ENGINEER.
4. THE ENGINEER SHALL BE NOTIFIED OF ANY UNUSUAL OR UNFORSEEN CONDITION WHICH EFFECTS THE STRUCTURAL STABILITY OF THE BUILDING PRIOR TO CONTINUING WITH CONSTRUCTION. SHOULD ANY CONDITION ARISE WHERE THERE APPEARS TO BE AN ERROR ON THE DRAWINGS OR A DISCREPANCY BETWEEN THE DRAWINGS AND CONDITIONS IN THE FIELD, THE ENGINEER SHALL BE NOTIFIED PRIOR TO CONTINUING WITH THE WORK.
5. IN THE CASE WHERE TWO OR MORE DETAILS APPLYING TO THE SAME PART OF THE WORK ARE IN CONFLICT, THE MOST RESTRICTIVE SHALL GOVERN UNLESS CLARIFIED OR OTHERWISE APPROVED BY THE ENGINEER.
6. REVIEW OF SHOP DRAWINGS MEANS REVIEW OF GENERAL METHOD OF FABRICATION ONLY. DIMENSIONS AND QUANTITIES MAY NOT BE CHECKED, AND REVIEW OF THE SHOP DRAWINGS DOES NOT RELIEVE THE CONTRACTOR FROM COMPLIANCE WITH THE CONSTRUCTION DOCUMENTS UNLESS SPECIFICALLY SO INDICATED IN THE REVIEW.
7. THE ENGINEER HAS NOT BEEN RETAINED FOR SUPERVISION OR INSPECTION DURING CONSTRUCTION, BUT WILL RESOLVE STRUCTURAL ITEMS BROUGHT TO HIS ATTENTION DURING CONSTRUCTION.
8. THE CONTRACTOR SHALL BE RESPONSIBLE FOR ALL SHORING AND BRACING REQUIRED TO PROTECT PERSONNEL AND ADJACENT PROPERTY DURING CONSTRUCTION. THE CONTRACTOR SHALL ADEQUATELY BRACE ELEMENTS OF THE STRUCTURE DURING CONSTRUCTION TO INSURE THE SAFETY OF THE STRUCTURE.
9. (E) INDICATES EXISTING CONDITION OR MEMBER, (N) NEW.

### FOUNDATION

1. THERE IS NO SILS REPORT FOR THIS PROJECT AND AN ASSUMED SOIL BEARING VALUE OF 1,000 PSF, (NET), HAS BEEN USED IN THE DESIGN OF THE A/C PAD.
2. THE NEW GENERATOR PAD/MAT SHALL BEAR A MINIMUM OF 8" INTO FIRM, UNDISTURBED SOILS. THE CONTRACTOR SHALL RECOMPACT THE SOILS UNDERNEATH THE NEW PAD/MAT AS NECESSARY.

### CONCRETE

1. ALL CONCRETE UNLESS OTHERWISE SHOWN ON THE PLANS SHALL BE HARDROCK CONFORMING TO ASTM C-94 WITH A MINIMUM COMPRESSIVE STRENGTH AT 28 DAYS OF  $f'_c = 3,000$  PSI.
2. AGGREGATE FOR THE CONCRETE SHALL CONFORM TO ASTM C-33, INCLUDING APPENDIX "X1".
3. THE CONTRACTOR SHALL TAKE ADEQUATE PRECAUTIONS FOR MIXING, PLACING, FINISHING, CURING, AND PROTECTING CONCRETE DURING UNFAVORABLE WEATHER CONDITIONS.
4. ALL REINFORCING STEEL SHALL BE NEW STOCK DEFORMED BAR CONFORMING TO ASTM A-615, GRADE 60 EXCEPT #3 BARS MAY BE GRADE 40.. ALL WELDED REINF. STEEL SHALL BE ASTM-A706. ALL BARS SHALL BE FREE OF RUST, GREASE, MILL SCALE OR ANY OTHER MATERIALS WHICH MIGHT AFFECT ITS BOND TO THE CONCRETE ALL BAR BENDS SHALL BE MADE COLD.
5. PROVIDE 3/4" CHAMFER ON ALL EXPOSED CORNERS.
6. BAR SPLICES SHALL BE LAP SPLICES w/ MIN. 40 BAR DIAM. LAP w/ AN 18" MINIMUM, (WHICHEVER IS GREATER). STAGGER LAP SPLICES OF MULTIPLE BARS, (i.e. IN CONT. FOOTING w/ 2 HORIZ. BARS TOP AND BOTTOM STAGGER TOP BAR LAP SPLICES AND STAGGER BOTTOM BAR LAP SPLICES- SPLICES DO NOT HAVE TO BE STAGGERED BETWEEN TOP AND BOTTOM BARS).
7. REINFORCING BARS SHALL HAVE THE FOLLOWING CONCRETE COVER, (UNLESS NOTED OTHERWISE IN DETAILS):  
CONCRETE POURED AGAINST EARTH.....3 INCHES  
CONCRETE BEAMS AND COLUMNS.....2 INCHES  
CONCRETE SLABS ABOVE GRADE.....1 INCH
8. DRYPACK SHALL BE MIXED IN THE PROPORTIONS OF 1 PART PORTLAND CEMENT TO 2-1/2 PARTS SAND WITH ENOUGH WATER TO PRODUCE A STIFF MIX. DRYPACK SHALL BE THOROUGHLY TAMPED INTO PLACE TO ENSURE A DENSE FINISH, FREE OF VOIDS.
9. THE SLUMP OF THE CONCRETE SHALL BE THE MINIMUM THAT IS PRACTICABLE. WHEN VIBRATORS ARE USED TO CONSOLIDATE THE CONCRETE, THE SLUMP SHALL NOT EXCEED 4 INCHES, OTHERWISE THE SLUMP SHALL NOT EXCEED 6 INCHES.
10. ALL CONCRETE SHALL BE ADEQUATELY CONSOLIDATED DURING PLACEMENT AND ALL REINFORCING STEEL AND EMBEDDED ITEMS SHALL BE SECURELY TIED IN PLACE TO PREVENT DISPLACEMENT DURING CONCRETE PLACEMENT.
11. EXCEPT WHERE INDICATED OTHERWISE, ALL REINFORCING STEEL SHALL BE BENT AND PLACED IN ACCORDANCE WITH THE "CODE OF STANDARD PRACTICE AND THE SPECIFICATIONS FOR PLACING REINFORCING STEEL" OF THE CONCRETE REINFORCING STEEL INSTITUTE.

### SPECIAL INSPECTIONS

PROVIDE SPECIAL INSPECTION BY A LICENSED DEPUTY INSPECTOR APPROVED BY THE LOCAL BUILDING OFFICIAL FOR THE FOLLOWING WORK IN ACCORDANCE WITH THE REQUIREMENTS OF CHAPTER 17 OF THE CALIFORNIA BUILDING CODE:

1. FOR ALL "POST INSTALLED" ANCHORS, (MECHANICAL EXPANSION BOLTS AND EPOXIED THREADED RODS ANCHOR).

### EQUIPMENT ANCHORAGE

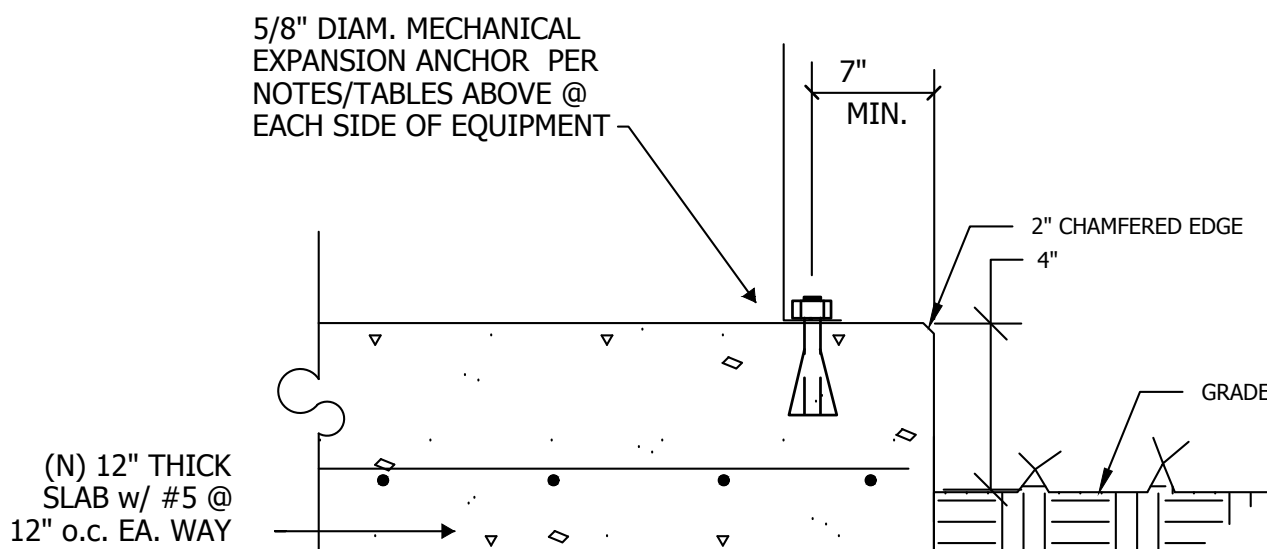
THE EQUIPMENT SHALL BE ANCHORED TO THE NEW 8" THICK CONCRETE MAT/SLAB WITH SIMPSON STRONG-BOLT 2 STAINLESS STEEL WEDGE ANCHORS PLACED IN THE EXISTING HOLES AT THE BASE OF THE EQUIPMENT PER THE TABLES BELOW:

#### SIMPSON STRONG-BOLT 2

PRE-DRILLED HOLE SIZE IN EQUIP. BASE	ANCHOR SIZE	MIN. HOLE DEPTH	NOMINAL EMBED. DEPTH	TORQUE (FT. LB.)
0.69" DIAM.	5/8" DIAM.	5"	4-3/8 "	80


ALL ANCHORS SHALL BE STAINLESS STEEL SIMPSON STRONG-BOLT 2 EXPANSION ANCHORS INSTALLED PER ICC-ESR - 3037 w/ SPECIAL INSPECTION REQUIRED BY A LICENSED DEPUTY INSPECTOR

THE CONTRACTOR SHALL LOCATE ALL EXISTING SLAB HORIZONTAL REINFORCING STEEL PRIOR TO DRILLING FOR EXPANSION ANCHORS TO AVOID DAMAGING SLAB REINF. STEEL.




## EQUIPMENT INSTALLATION

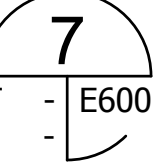SCALE: NTS FOR FLOOR MOUNTED ELECTRICAL EQUIPMENT





### DETAIL NOTES:

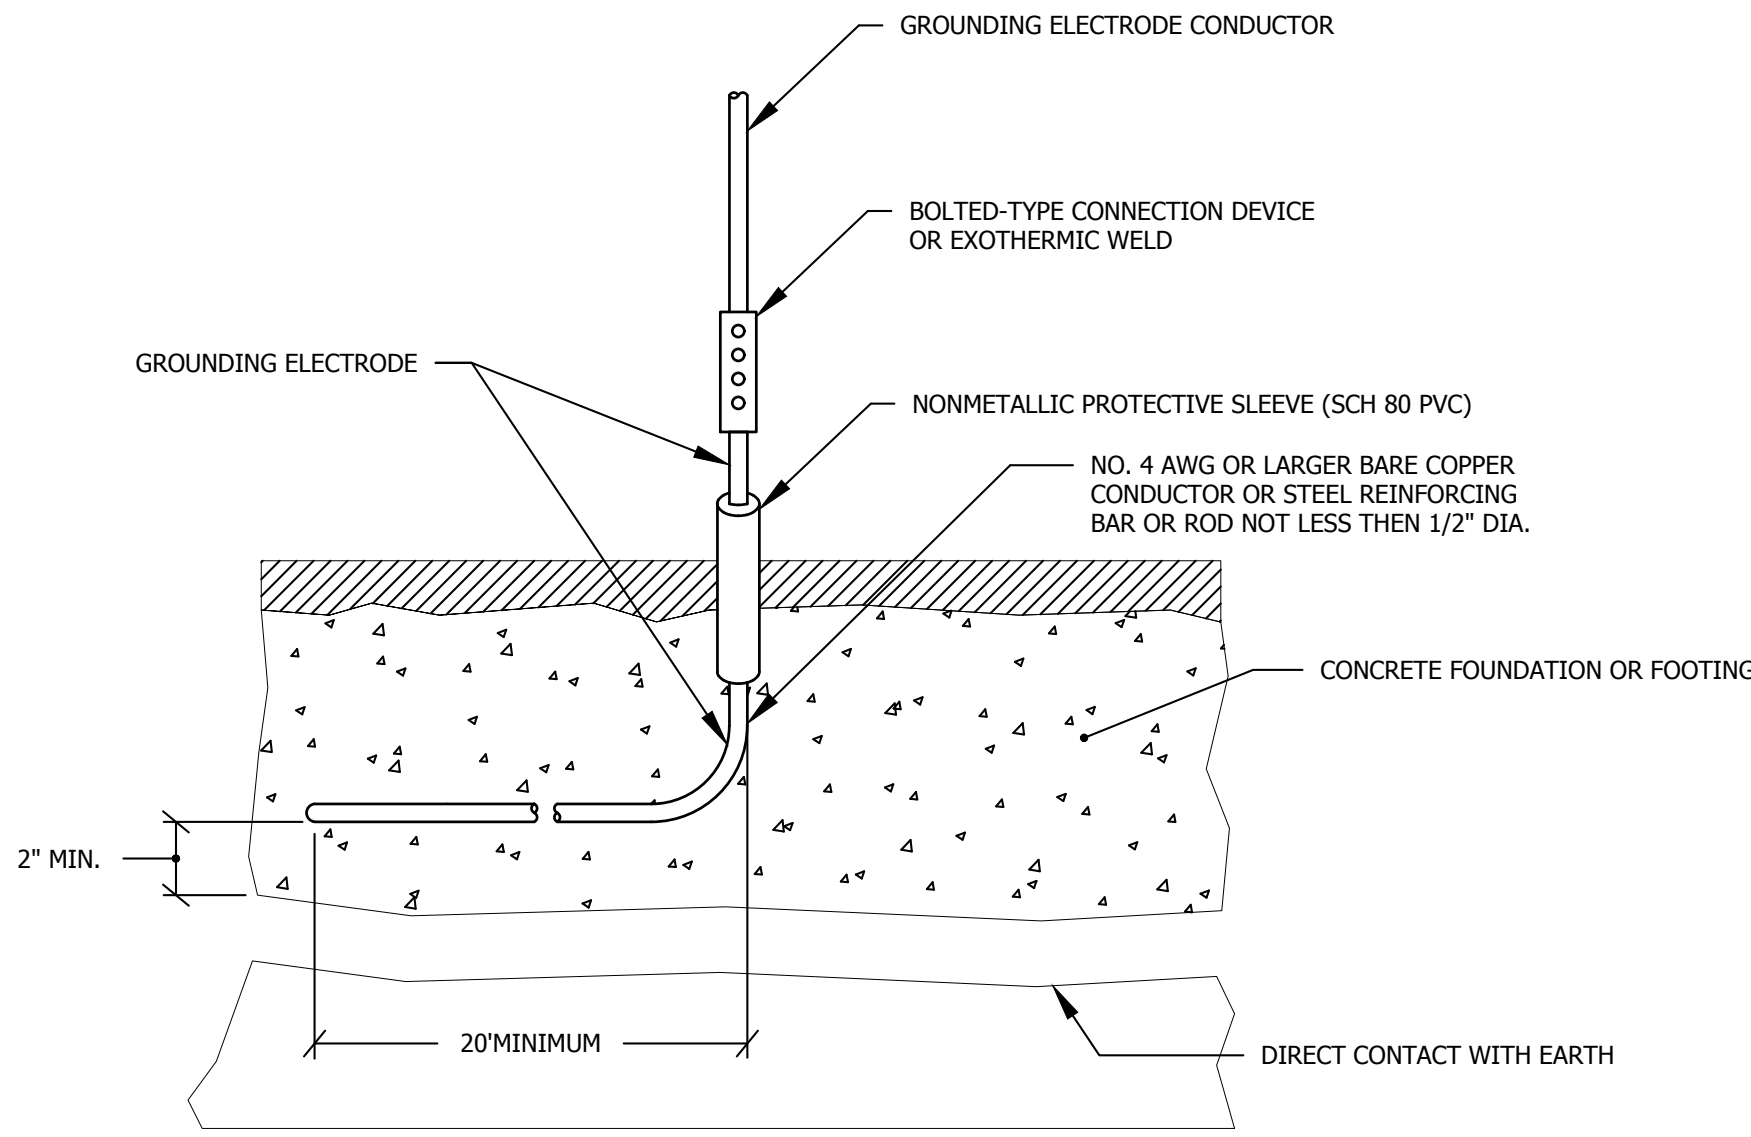1. CONCRETE-ENCASED ELECTRODE: AN ELECTRODE ENCASED BY AT LEAST 2 INCHES (50.8MM) OF CONCRETE, LOCATED WITHIN AND NEAR THE BOTTOM OF A CONCRETE FOUNDATION OR FOOTING THAT IS IN DIRECT CONTACT WITH THE EARTH, CONSISTING OF AT LEAST 20 FEET (6.1 M) OF ONE OR MORE BARE OR ZINC GALVANIZED OR OTHER ELECTRICALLY CONDUCTIVE COATED STEEL REINFORCING BARS OR RODS OF NOT LESS THAN 1/2 INCH (12.7 MM) DIAMETER, OR CONSISTING OF AT LEAST 20 FEET (6.1 M) OF BARE COPPER CONDUCTOR NOT SMALLER THAN NO. 4, SEE PLANS FOR SIZE OF CONDUCTOR IF GREATER THEN #4.





## UFER GROUND DETAIL 3

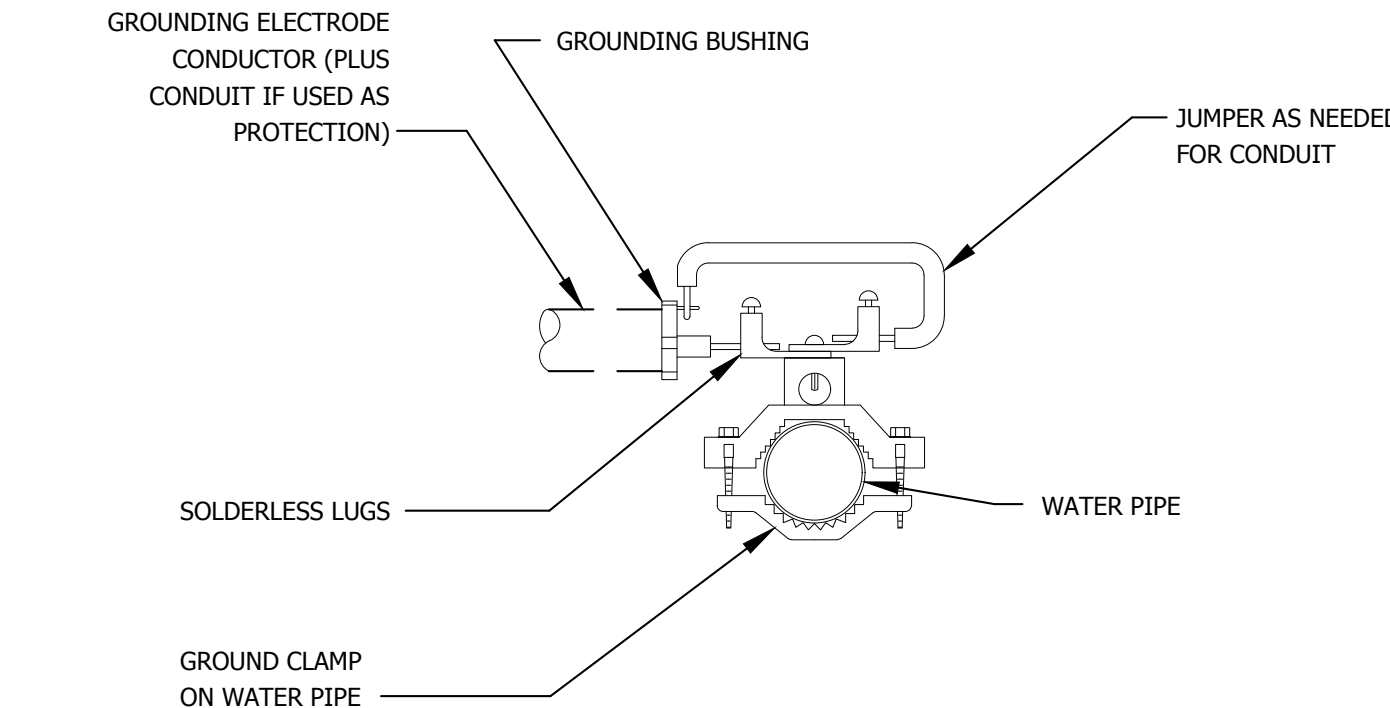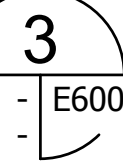SCALE: NONE




## COLD WATER BONDING DETAIL 2

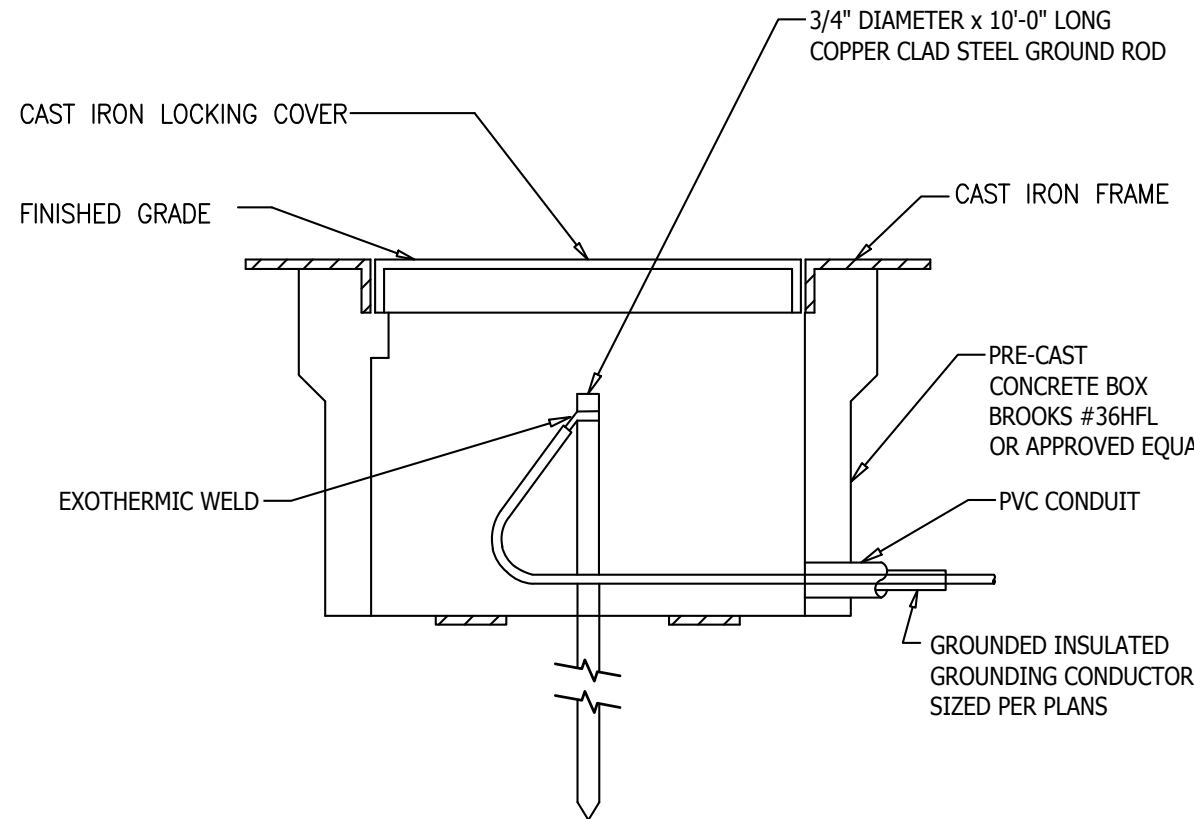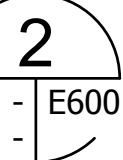SCALE: NONE



## GROUND WELL DETAIL 1

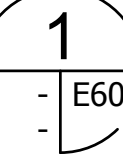SCALE: NONE



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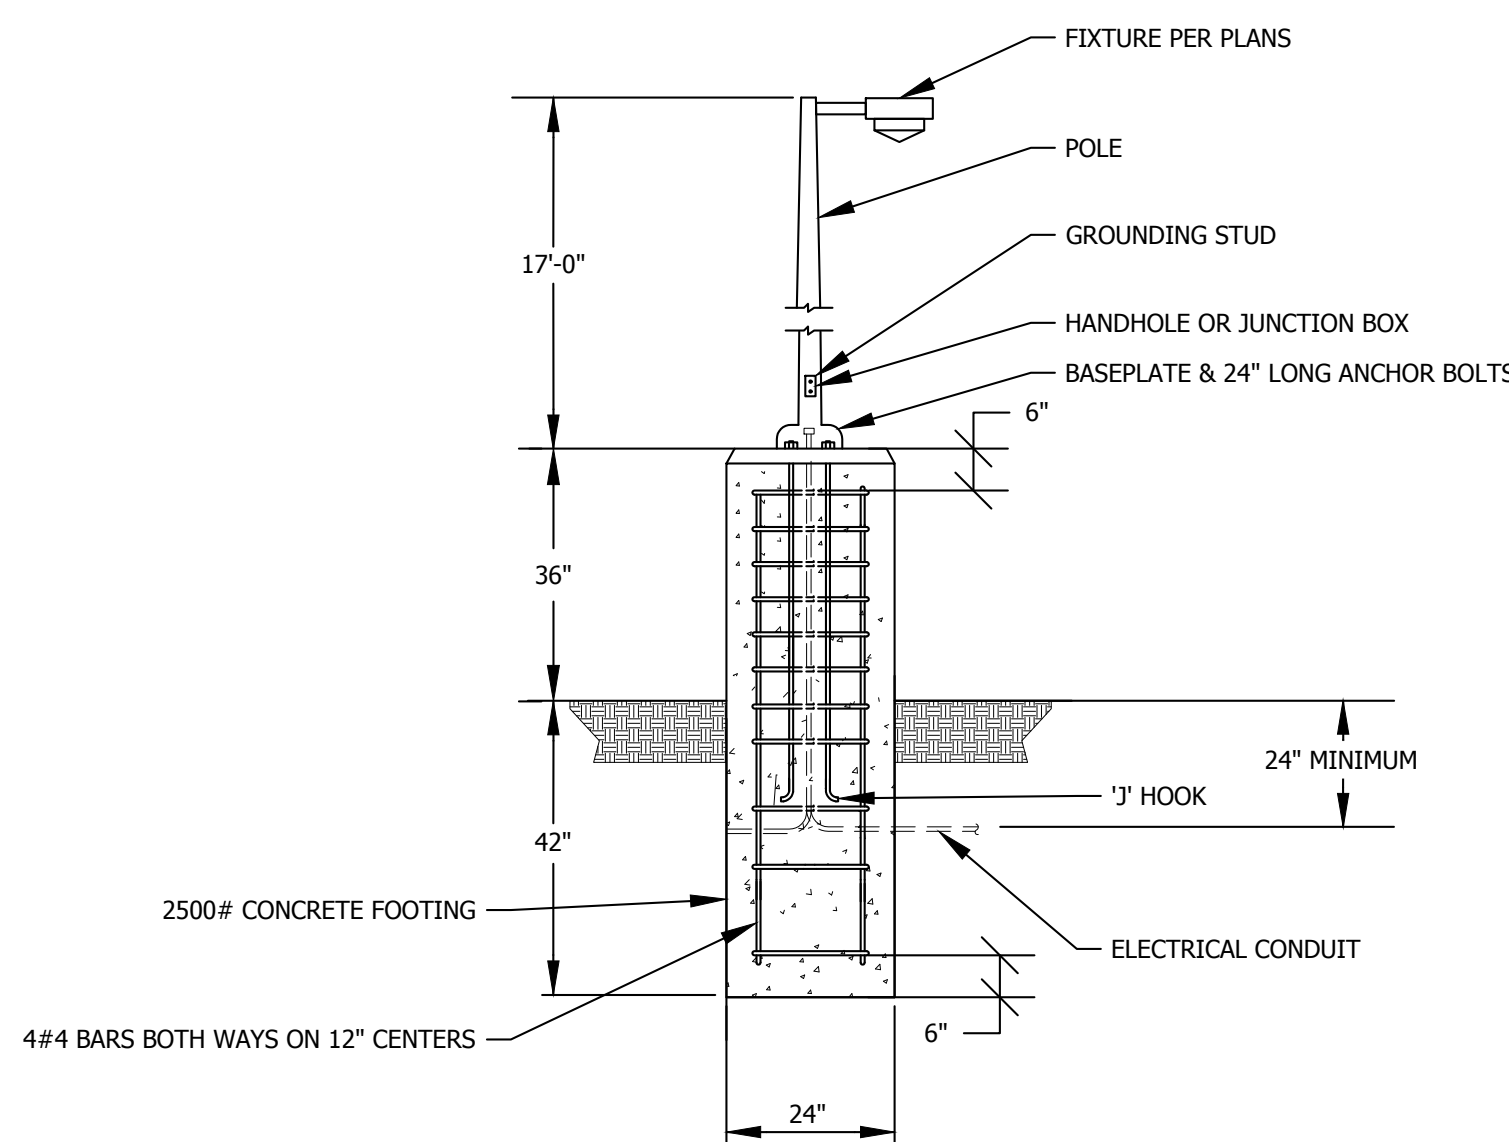
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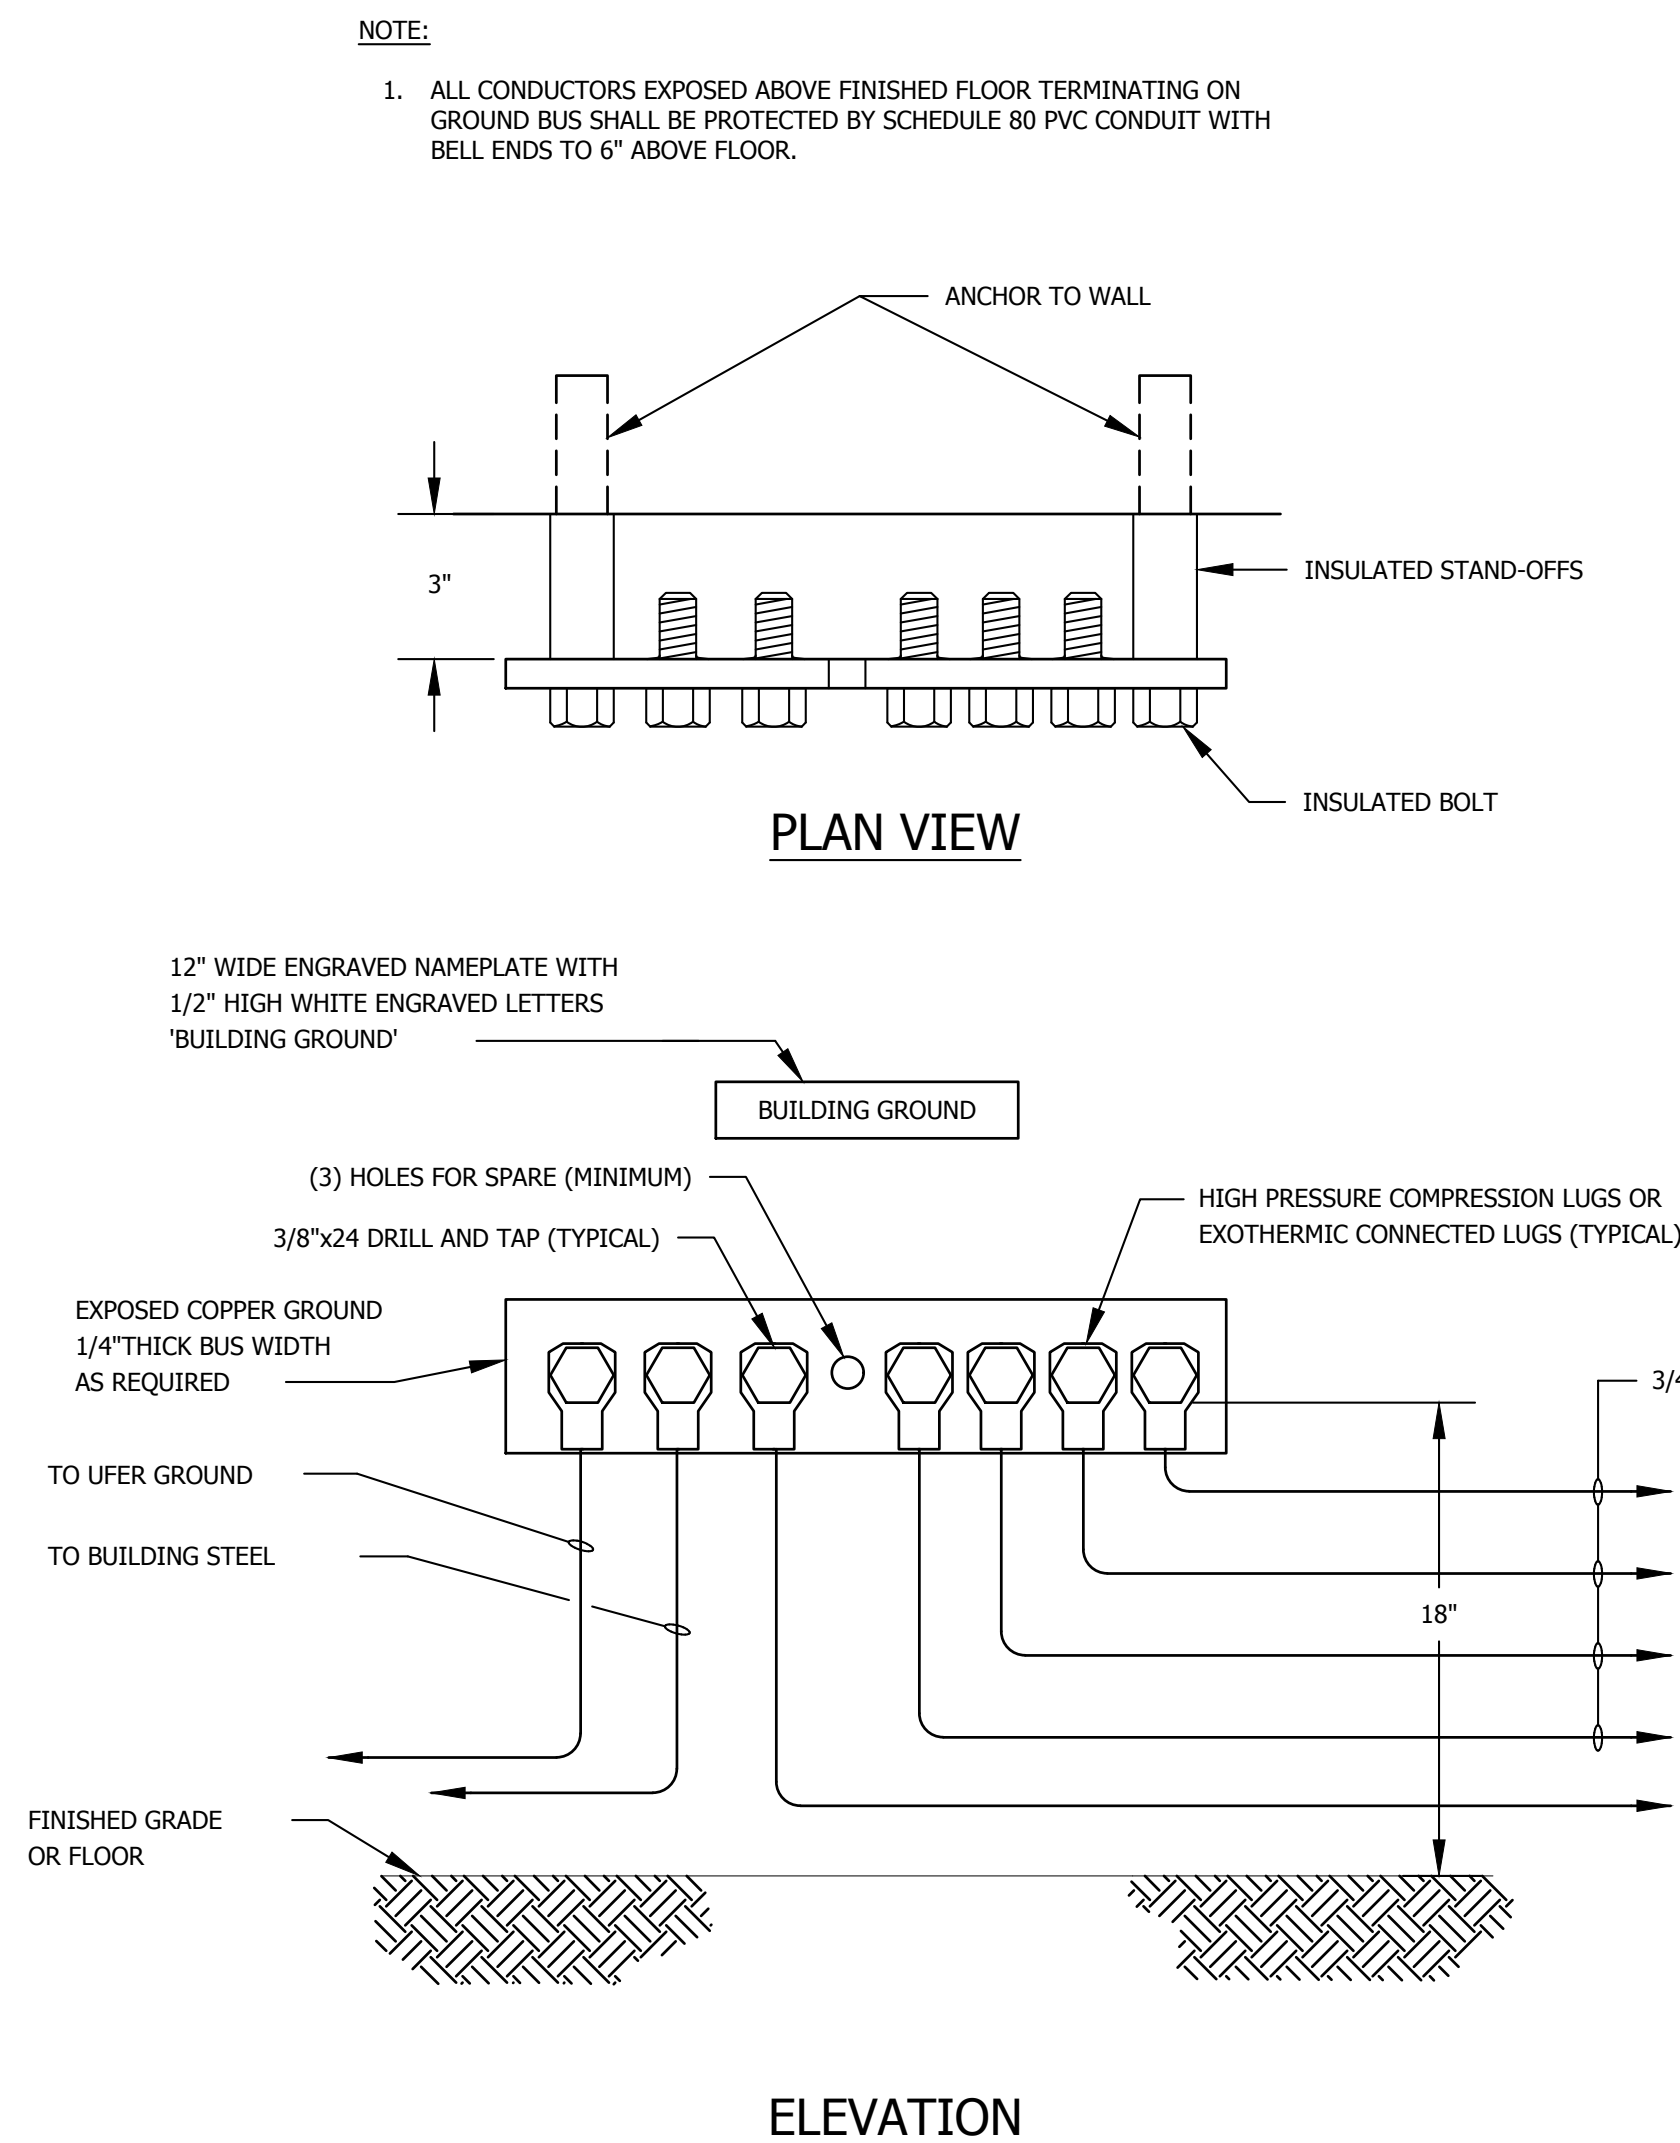
SHEET NO.

E600





NEW POLE / LIGHT PER FIXTURE SCHEDULE 2  
SCALE: NONE - E601



**TYPICAL GROUND BUS BAR DETAIL**

SCALE: NONE

1  
- E601



## **Illuminator IE** Emergency Lighting Inverter System

Single Phase Interruptible Power Systems  
1.5KVA/KW to 16.7KVA/KW For LED & All Other Non-HID Lighting Loads



## STANDARD FEATURES

- 98% Efficient (Typical)
- PWM/IGBT Technology
- Micro-Processor Control
- User Programmable with Password Protection
- UL 924 Listed
- Automatic Event, Test and Alarm Log
- RS232 Communications Port
- Input Circuit Breaker
- 50ms Transfer Time
- Low Audible Noise
- Normally Off Output
- Space-Saving, Single Cabinet Design
- 65kAIC Interrupting Rating

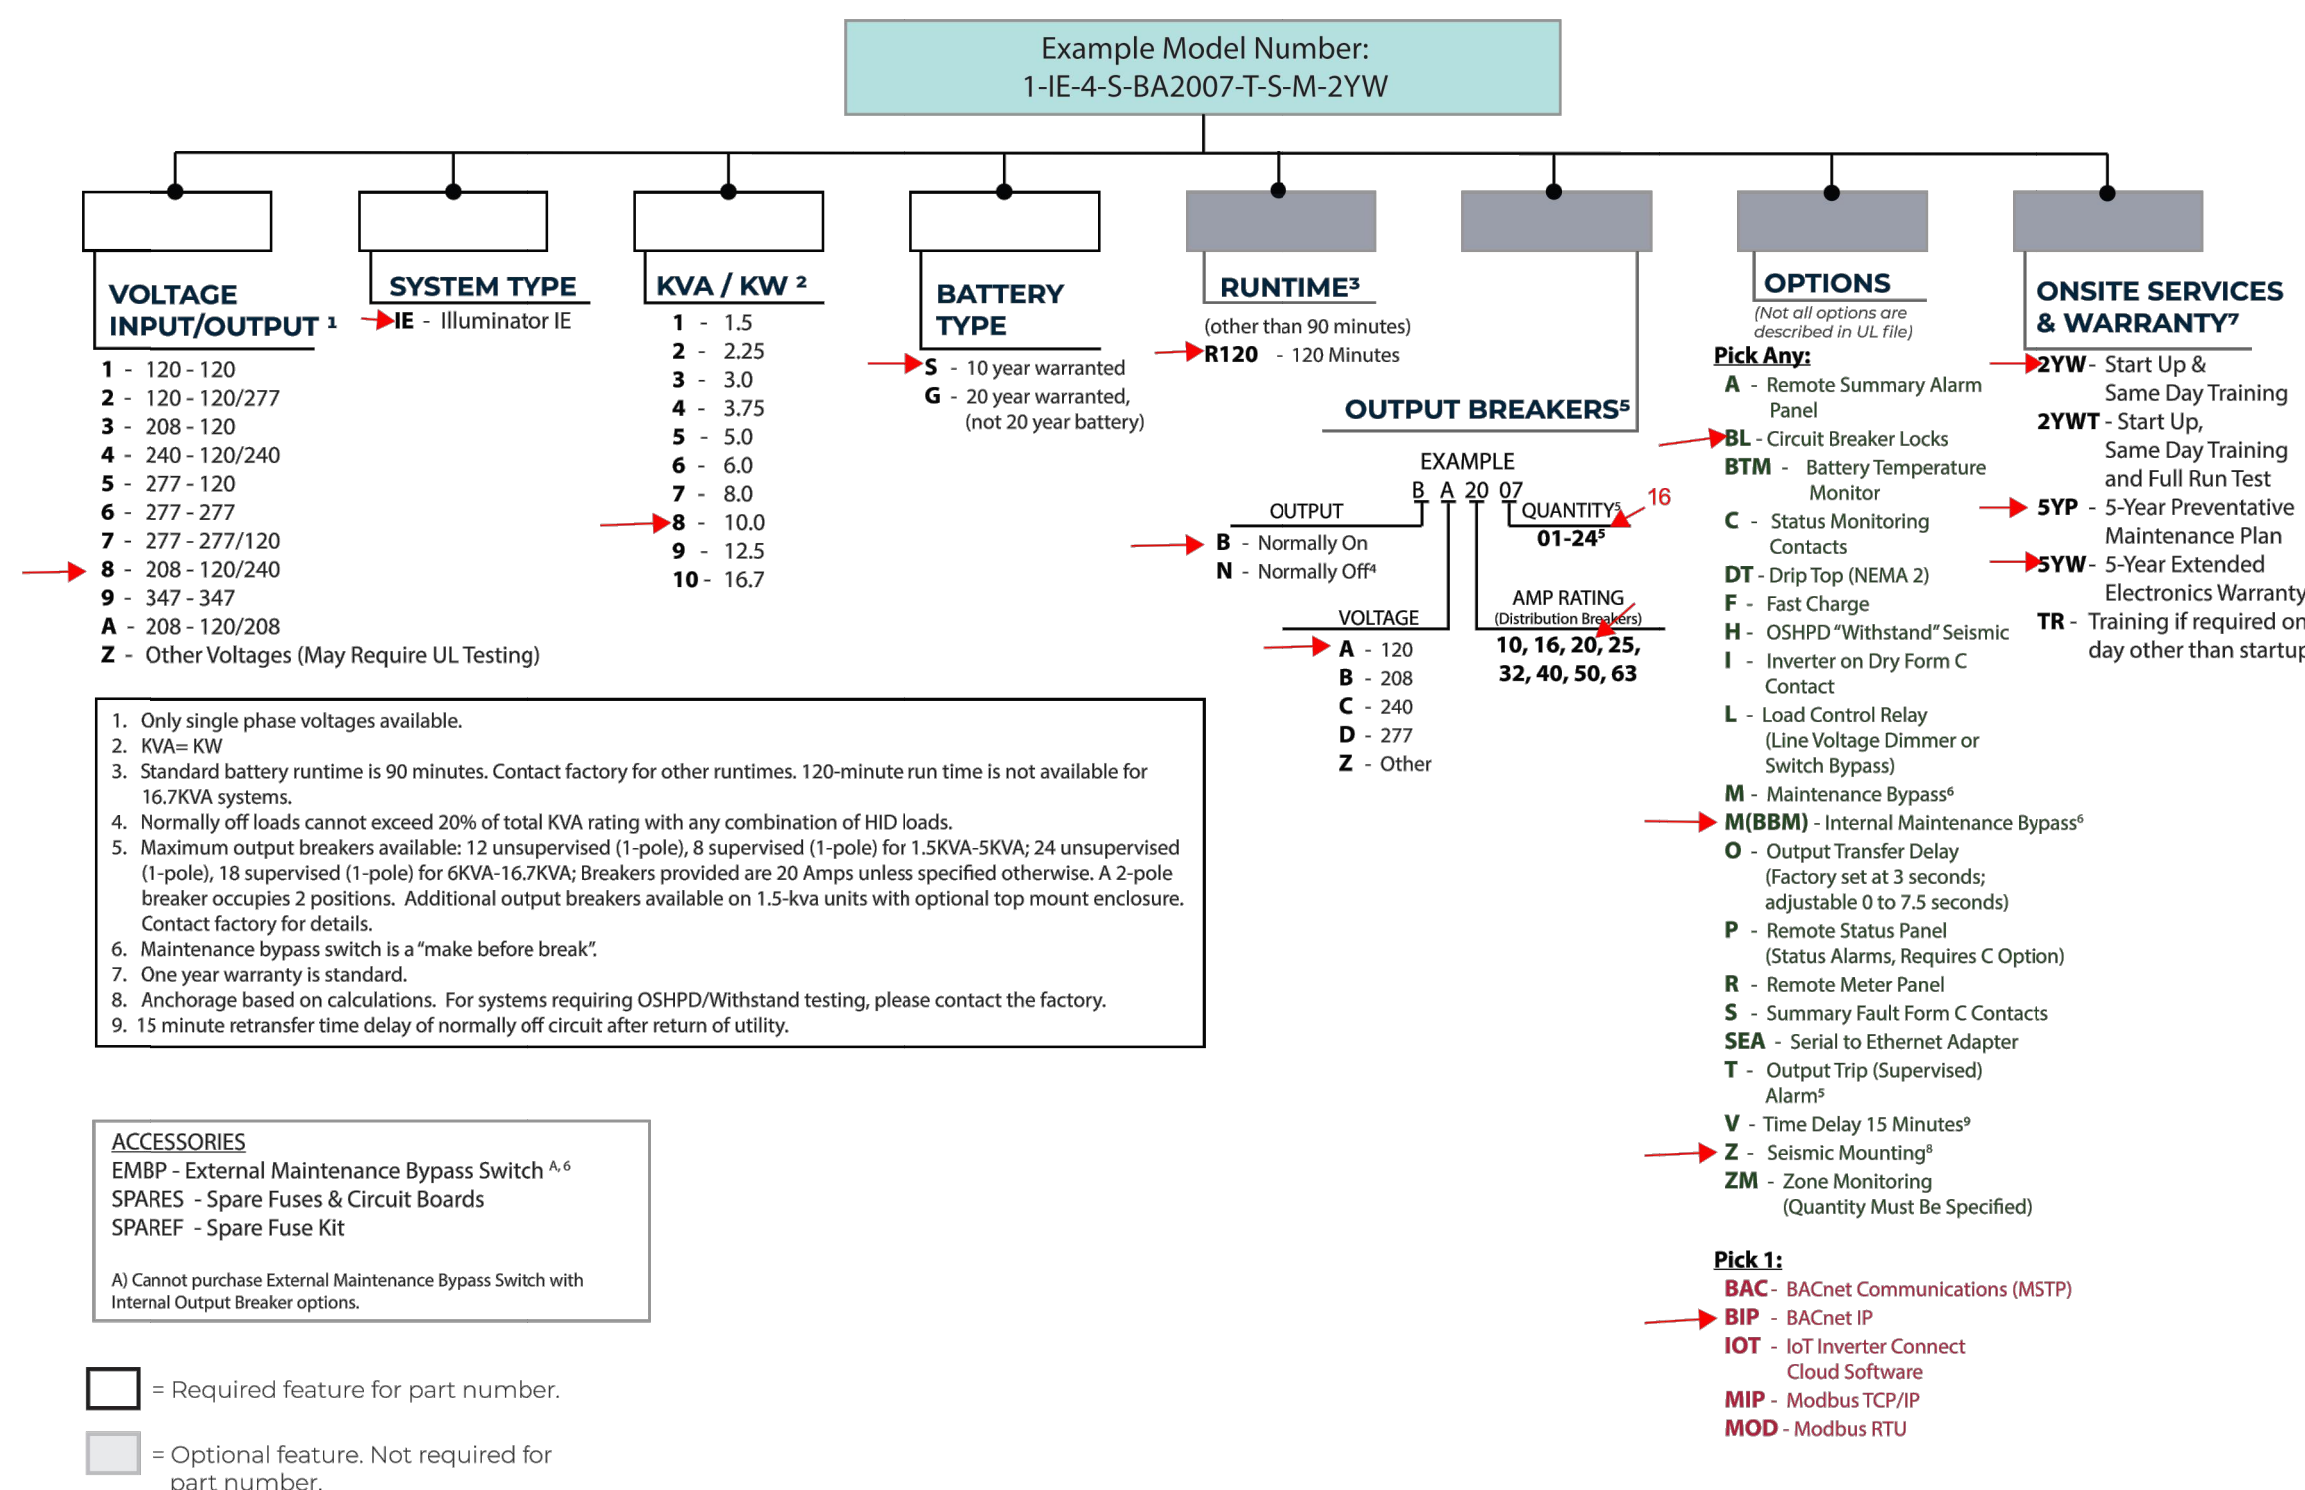
## OPTIONAL FEATURES

- Enhanced Communications
  - Expanded Building Management Protocols
  - BACnet or Modbus Communications Interface
- **NEW IoT Connect Cloud Software**
- Internal Maintenance Bypass
- Summary Fault Form C Dry Contacts
- Fast Charge
- Remote Meter Panel
- Output Circuit Breakers
- Extended Factory Warranty
- Factory Startup and Training
- Output Trip Alarms
- Remote Summary Alarm Panel

## SPECIFICATIONS

- Input 120 or 277VAC 1 Phase 2 Wire Plus Ground
- Output 120 or 277VAC 1 Phase 2 Wire Plus Ground
- Output Load Power Factor .5 Lag to .5 Lead
- Compatible with all LED Drivers
- Forced Air Cooling Only During Emergency Operation; No Filters Required
- Output Distortion Less than 3% THD for Linear Loads
- Compatible with Generators (10% Inverter Size)
- Custom Voltages Available
- 90 Minute Runtime Standard; Other Runtimes Available upon Request

## ORDERING GUIDE



## DIMENSIONS


Electronics Module								Batteries 90 Minutes @ Full Load					
Model Number	Power Rating (KVA / KW)	Efficiency (%)	Audible Noise (db)	Heat Loss (BTU)	Cabinet Dimensions				90 Minutes Batteries (lbs / kg)	Number of Batteries	Voltage (VDC)	Current (amps)	Total System Weight (lbs / kg)
					Width (in / cm)	Height (in / cm)	Depth (in / cm)	Weight (lbs / kg)					
IE-1-5	1.5	98	45	102	30 / 77	47 / 119	25 / 64	215 / 98	296 / 135	4	48	39	511 / 230
IE-2-5	2.25	98	45	153	30 / 77	47 / 119	25 / 64	230 / 105	444 / 200	6	72	38	679 / 306
IE-3-5	3.0	98	45	204	30 / 77	47 / 119	25 / 64	235 / 107	592 / 266	8	96	38	827 / 372
IE-4-5	3.75	98	45	255	30 / 77	47 / 119	25 / 64	240 / 109	740 / 330	10	120	37	980 / 441
IE-5-5	5.0	98	45	340	30 / 77	47 / 119	25 / 64	280 / 128	888 / 400	12	144	40	1168 / 525
IE-6-5	6.0	98	45	408	48 / 122	76 / 193	25 / 64	605 / 272	1110 / 500	15	180	40	1715 / 772
IE-7-5	8.0	98	45	544	48 / 122	76 / 193	25 / 64	640 / 288	1480 / 666	20	240	39	2120 / 954
IE-8-5	10.0	98	45	680	48 / 122	76 / 193	25 / 64	785 / 353	1776 / 800	24	144	82	2561 / 1153
IE-9-5	12.5	98	45	860	48 / 122	76 / 193	25 / 64	805 / 362	2220 / 999	30	180	82	3025 / 1361
IE-10-5	16.7	98	45	1135	48 / 122	76 / 193	25 / 64	885 / 398	2960 / 1332	40	240	80	3845 / 1730



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BEACH CITIES  
HEALTH DISTRICT

100% PRELIMINARY  
DESIGN SUBMITTAL

PMA PROJECT NO.  
23-727

DRAWING TITLE

DRAWING TITLE

## ELECTRICAL DETAILS

SCALE

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AS NOTED

DATE	02-28-2024
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D.S./L.K.	K.L.

SHEET NO.

E601



BEACH CITIES HEALTH DISTRICT  
ALLCOVE  
REDONDO BEACH, CA



PAUL MURDOCH  
ARCHITECTS

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GENERAL NOTES

REFER TO AUDIO VISUAL SPECIFICATION SECTION FOR COMPLETE REQUIREMENTS

1. ELECTRICAL
- A. ALL CONDUITS, JUNCTION BOXES, BACK BOXES, PULL STRING AND POWER OUTLETS BY DIVISION 26 CONTRACTOR AS REQUIRED.
- B. ELECTRICAL CONTRACTOR TO PROVIDE PULLSTRING ON ALL AV CONDUIT.
- C. ALL POWER TO AV EQUIPMENT TO ORIGINATE FROM DEDICATED AUDIO VIDEO LOAD CENTER IN ACCORDANCE WITH THE LATEST LOCAL AND NATIONAL CODES REFERENCING "TECHNICAL POWER SYSTEMS", NEC ARTICLE 640.
- D. BRANCH CIRCUITS FEEDING AUDIO-VISUAL EQUIPMENT MUST NOT ORIGINATE FROM LOAD CENTERS CONNECTED TO INDUCTIVE LOADS.
- E. PROVIDE ALL AV CIRCUITS WITH ISOLATED GROUND, DEDICATED NEUTRAL.
2. COORDINATE
- A. COORDINATE WITH THE WORK OF ALL SECTIONS. COORDINATE THE LOCATION OF BLOCKING AND BACKING REQUIRED BY THIS SECTION. MAKE REASONABLE MINOR ADJUSTMENTS TO PRESERVE ARCHITECTURAL SYMMETRY AND ALIGNMENT WITH ADJACENT FEATURES AT NO CLAIM FOR ADDITIONAL COST OR TIME. PRESENT CONFLICTS IN TIMELY MANNER FOR RESOLUTION.
- B. RELOCATION, REVISION OR CORRECTION CAUSED BY FAILURE OF THE CONTRACTOR TO COORDINATE THE WORK SHALL NOT BE SUBJECT TO CLAIM FOR ADDITIONAL COST OR TIME.
- C. POWER RECEPTACLES SHOWN ON THE AV DRAWINGS OUTSIDE OF EQUIPMENT RACKS ARE SHOWN FOR COORDINATION INFORMATION ONLY. REFER TO DIVISION 26 DOCUMENTS FOR CONSTRUCTION.
- D. THESE DRAWINGS SHOW SCOPE. THE EXACT LOCATION & ELEVATIONS OF LOUDSPEAKERS, RECEPTACLES AND DEVICES MUST BE COORDINATED WITH THE ARCHITECTURAL DRAWINGS.
- E. CONDUIT, BACK BOXES AND PULL BOXES SUPPLIED AND INSTALLED BY ELECTRICAL CONTRACTOR UNDER SUPERVISION OF AV CONTRACTOR.
- F. GENERAL CONTRACTOR SHALL COORDINATE THE CONDUIT, DEVICES, PATHWAYS AND JUNCTION BOXES FOR THE AV SYSTEM WITH OTHER TRADE TO AVOID ANY CONFLICTS.
3. LOCATIONS AND DIMENSIONS
- A. LOCATIONS AND DIMENSIONS SHOWN ON ARCHITECTURAL DRAWINGS TAKE PRECEDENCE OVER THESE AV DRAWINGS. IN CASE OF APPARENT CONFLICT OR AMBIGUITY, SUBMIT TO THE ARCHITECT IN TIMELY MANNER FOR RESOLUTION.
- B. DIMENSIONS TAKE PRECEDENCE OVER SCALE. LARGE SCALE DRAWINGS TAKE PRECEDENCE OVER SMALL. REPORT ALL CONFLICTS BEFORE INSTALLATION.
- C. UNLESS OTHERWISE NOTED, DIMENSIONS ARE SHOWN HEIGHT X WIDTH X DEPTH.
- D. VERIFY ALL DIMENSIONS, LOCATIONS AND CONDITIONS IN THE FIELD PRIOR TO STARTING WORK. NOTIFY ARCHITECT OF ANY APPARENT DISCREPANCIES.
4. SUPPORT
- PROVIDE ALL BLOCKING, BRIDGING, TIES, FASTENERS AND RELATED SUPPORT PROVISIONS FOR ALL WORK OF THIS SECTION. COMPLY WITH APPLICABLE CODE REQUIREMENTS FOR MEANS OF SUPPORT OF ELECTRICAL EQUIPMENT OF THE SAME WEIGHT UNDER THE SAME MOUNTING CONDITIONS. DO NOT APPLY ANY LOAD TO BUILDING STRUCTURE WITHOUT FIRST OBTAINING WRITTEN APPROVAL OF THE PROJECT STRUCTURAL ENGINEER. OBTAIN PER PROJECT PROCEDURES, SUPPORTS FOR RACEWAY SYSTEM BY DIVISION 26 CONTRACTOR.
5. BOX, PANEL AND ENCLOSURE INSTALLATION
- A. COORDINATE THE LOCATION OF ALL BOXES, PANELS, ENCLOSURES AND RELATED RACEWAY WITH THE WORK OF OTHER SECTIONS.
- B. VERIFY ACCESS TO BOXES, PANELS AND ENCLOSURES COMPLY WITH APPLICABLE CODE.
- C. COORDINATE AND CORRECT ALL CONDITIONS OF OCCLUSION OF ALL LOUDSPEAKER ASSEMBLIES. WHERE MORE THAN ONE (1) FLUSH MOUNTED CEILING LOUDSPEAKER HAS BEEN SCHEDULED, NONE SHALL BE LOCATED CLOSER TO ANY FIXED WALL THAN ONE-HALF (1/2) OF THE ADJACENT CLEAR HEIGHT, EXCEPT AT CEILING DISCONTINUITIES, OR WHERE SPECIFICALLY SHOWN ON THE DRAWINGS.
- D. INSTALL BOXES, PANELS AND ENCLOSURES SQUARE AND PLUMB. SET FLUSH MOUNTED UNITS SO THAT THE FACE OF THE COVER, BEZEL OR ESCUTCHEON, IS IN THE SAME PLANE AS THE SURROUNDING FINISHED SURFACE. MOUNT BOXES, PANELS AND TRIM SO THAT THERE ARE NO GAPS, CRACKS OR OBVIOUS LINES BETWEEN THE TRIM AND THE ADJACENT FINISHED SURFACE.
- E. UNLESS OTHERWISE NOTED, PROVIDE STEEL BOXES, PANELS AND ENCLOSURES. COMPLY WITH DIVISION 26 REQUIREMENTS AND APPLICABLE CODE.
- F. UNLESS OTHERWISE NOTED, BOXES AND ENCLOSURES SHALL BE NOT LESS THAN 2-1/8 INCHES DEEP. PROVIDE THE LARGER OF THE SIZE REQUIRED BY APPLICABLE CODE OR AS SHOWN ON DRAWINGS. COORDINATE WIRE AND CABLE BEND RADIUS WITH BOX AND ENCLOSURE SIZE.
- G. PULL BOXES, PROVIDE AS REQUIRED BY THE MOST RESTRICTIVE OF APPLICABLE CODE OR THE PROVISIONS OF DIVISION 26. COORDINATE WITH WIRE AND CABLE BEND RADIUS.
- H. PROVIDE REQUIRED FIRE RATED JUNCTION BOXES OR FIRE STOP BOX GUARDS AT ALL FIRE RATED WALLS.
- I. CONDUIT AND ACCESSORIES MUST BE INSTALLED PLUMB AND TRUE WITH UNIFORM FASTENING, FULLY DRESSED AND FINISHED.

6. RACEWAY
- A. FOR ALL WORK OF THIS SECTION, RACEWAY ABOVE GROUND SHALL BE EMT, RACEWAY BELOW GROUND SHALL BE PVC.
- B. RACEWAY SHALL BE ¾ INCH DIAMETER TRADE SIZE UNLESS OTHERWISE NOTED.
- C. ALL CONDUIT RUNS OVER 100 FT. MUST HAVE LARGE RADIUS BENDS.
- D. A MAXIMUM OF TWO 90 DEGREE ELBOWS IN EACH CONDUIT RUN.
- E. CONDUIT WITH FIBER OPTIC CABLE INSTALLED, MUST CONFORM TO THE MINIMUM BEND RADIUS AS SPECIFIED BY THE MANUFACTURER OF THE CABLE.
- F. DIVISION 26 CONTRACTOR IS TO APPLY RADIUS BENDS WHERE NEEDED. FIBER BEND RADIUS SHALL BE A MINIMUM LONG-TERM LOW-STRESS RADIUS NOT LESS THAN 20 TIMES THE CABLE DIAMETER.
- G. KEEP A MINIMUM OF 12" CLEAR BETWEEN ELECTRICAL CONDUIT AND LOW VOLTAGE CONDUIT.
- H. PROVIDE FIRE RATED CONDUIT PENETRATION SEALS AT ALL FIRE RATED WALLS.
- I. CONDUIT AND ACCESSORIES MUST BE INSTALLED PLUMB AND TRUE WITH UNIFORM FASTENING, FULLY DRESSED AND FINISHED.
7. GROUNDING AND BONDING
- COMPLY WITH ALL APPLICABLE CODES AND ORDINANCES. REFER TO NATIONAL ELECTRICAL CODE SECTION 250.
- A. BOND RACEWAY AND RELATED BOXES, PANELS, ENCLOSURES AND CABINETS AS REQUIRED BY APPLICABLE CODE AND DIVISION 26.
- B. MAKE RACEWAY CONNECTIONS TO EQUIPMENT RACKS AND SIMILAR EQUIPMENT ENCLOSURES CONTAINING POWERED EQUIPMENT WITH ISOLATED FITTINGS.
- C. GROUND AND BOND EQUIPMENT RACKS AND SIMILAR EQUIPMENT ENCLOSURES CONTAINING POWERED EQUIPMENT EXCLUSIVELY VIA THE ISOLATED EQUIPMENT GROUNDING CONDUCTORS PROVIDED UNDER DIVISION 26. SIZE SUCH CONDUCTORS ACCORDING TO APPLICABLE CODE. FOR EACH TECHNICAL BRANCH CIRCUIT, THE ISOLATED EQUIPMENT GROUNDING CONDUCTOR SHALL BE COPPER OF THE SAME GAUGE AS SUPPLY AND NEUTRAL CONDUCTORS. MAIN ISOLATED EQUIPMENT GROUNDING CONDUCTOR TO EACH ENSEMBLE OF EQUIPMENT RACKS SHALL BE COPPER, SIZED AS REQUIRED BY APPLICABLE CODE.
- D. D.C. RESISTANCE BETWEEN THE ISOLATED EQUIPMENT GROUNDING BUS AT EQUIPMENT ROOM TECHNICAL POWER PANELS AND THE MAIN PROJECT GROUND FIELD SHALL NOT EXCEED 0.15 OHMS.
- E. FOR COMMUNITY ANTENNA TELEVISION AND MASTER ANTENNA TELEVISION SYSTEMS AND RELATED PROVISIONS, COMPLY WITH ARTICLE 800, NATIONAL ELECTRICAL CODE.
8. CABLE AND WIRE
- A. ALL LOW VOLTAGE CABLE AND WIRE BY AUDIO-VISUAL CONTRACTOR.
- B. USE PLENUM RATED WIRE WHERE REQUIRED BY CODE.
- C. CABLE SPLICING NOT ALLOWED IN ANY PULLBOXES.
9. GENERAL
- A. IN THE EVENT THAT THESE PLANS, NOTES OR DETAILS OR ANY PART OR PORTION THEREOF ARE USED BY ANY THIRD-PARTY WITHOUT THE EXPRESS AUTHORIZED PERMISSION OF VENEKLASEN ASSOCIATES, THE UNAUTHORIZED USER AND ANYONE BENEFITING THEREFROM, SHALL DEFEND, INDEMNIFY AND HOLD HARMLESS VENEKLASEN ASSOCIATES AND ITS AGENTS, PRINCIPALS, EMPLOYEES AND CONSULTANTS FROM AND AGAINST ANY AND ALL CLAIMS, INCLUDING ATTORNEYS' FEES ARISING OUT OF SAID UNAUTHORIZED USE.
- B. FURTHERMORE, THE UNAUTHORIZED USE OF THESE PLANS, NOTES, DETAILS OR ANY PART OR PORTION THEREFORE IS EXPRESSLY PROHIBITED AND VENEKLASEN ASSOCIATES RETAINS A COPYRIGHT OVER ANY AND ALL DOCUMENTS PREPARED BY VENEKLASEN ASSOCIATES.
- C. IN THE EVENT THAT THE INSTALLER DEVIATES FROM THE PLANS AND SPECIFICATIONS PREPARED BY VENEKLASEN ASSOCIATES WHICH RESULTS IN DAMAGE TO PERSONS OR PROPERTY OF ANY KIND, INSTALLER HEREBY AGREES TO DEFEND, INDEMNIFY AND HOLD HARMLESS VENEKLASEN ASSOCIATES, ITS AGENTS, PRINCIPALS, EMPLOYEES AND CONSULTANTS FROM AND AGAINST ANY AND ALL CLAIMS, INCLUDING ATTORNEYS' FEES CAUSED BY SUCH FAILURE TO FOLLOW THE PLANS AND SPECIFICATIONS PREPARED BY VENEKLASEN ASSOCIATES, EXCEPTING ONLY THE DAMAGES TO PERSONS OR PROPERTY WHICH ARE CAUSED BY THE SOLE NEGLIGENCE OR WILLFUL MISCONDUCT OF VENEKLASEN ASSOCIATES.
- D. DRAWINGS ARE DIAGRAMMATIC AND ARE INTENDED TO CONVEY SCOPE OF WORK AND TO INDICATE GENERAL ARRANGEMENT. THERE ARE NOT INTENDED TO SHOW EVERY DETAIL INCLUDING OFFSET OR FITTING OR EVERY STRUCTURAL DIFFICULTY THAT MAY BE ENCOUNTERED DURING THE WORK. EXCEPT AS OTHERWISE INDICATED, LOCATIONS OF ITEMS ARE APPROXIMATE ONLY. EXACT LOCATIONS NECESSARY TO SECURE PROPER CONDITIONS AND RESULTS MUST BE DETERMINED AT PROJECT SITE AND MUST BE APPROVED BY THE OWNER'S REPRESENTATIVE.
- E. EXCEPT AS OTHERWISE INDICATED, MAKE REASONABLE MODIFICATIONS IN LAYOUT AS NEEDED TO PREVENT CONFLICT WITH OTHER WORK OR PROPER EXECUTION OF WORK.
- F. INCLUDE WORK NOT USUALLY SHOWN OR SPECIFIED, BUT NECESSARY FOR PROPER INSTALLATION AND OPERATION OF A SYSTEM OR PIECE OF EQUIPMENT IN WORK.

SHEET INDEX

100% PRELIMINARY DESIGN - 2/28/2024		
SHEET INDEX		
SHEET NUMBER	SHEET TITLE	
T001	TELECOM GENERAL NOTES AND SHEET INDEX	X
T002	TELECOM ABBREVIATIONS NOTES AND SYMBOLS	X
T100	TELECOM SITE PLAN	X
T111	TELECOM FIRST FLOOR PLAN	X
T112	TELECOM SECOND FLOOR PLAN	X
T211	TELECOM FIRST FLOOR REFLECTED CEILING PLAN	X
T212	TELECOM SECOND FLOOR REFLECTED CEILING PLAN	X
T401	TELECOM RISER DIAGRAM	X
T451	TELECOM EQUIPMENT PLAN LAYOUTS	X

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**allcove**  
BEACH CITIES  
HEALTH DISTRICT

100% PRELIMINARY  
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PMA PROJECT NO.

23007

DRAWING TITLE

TELECOM GENERAL  
NOTES AND SHEET  
INDEX

SCALE

AS NOTED

DATE

02/28/2024

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SHEET NO.

T001







BERYL STREET

TELECOM SITE PLAN

SCALE:  
1/8" = 1'-0"

1



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**Veneklasen Associates**  
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DRAWING TITLE

TELECOM SITE  
PLAN

SCALE  
AS NOTED

DATE	02/28/2024
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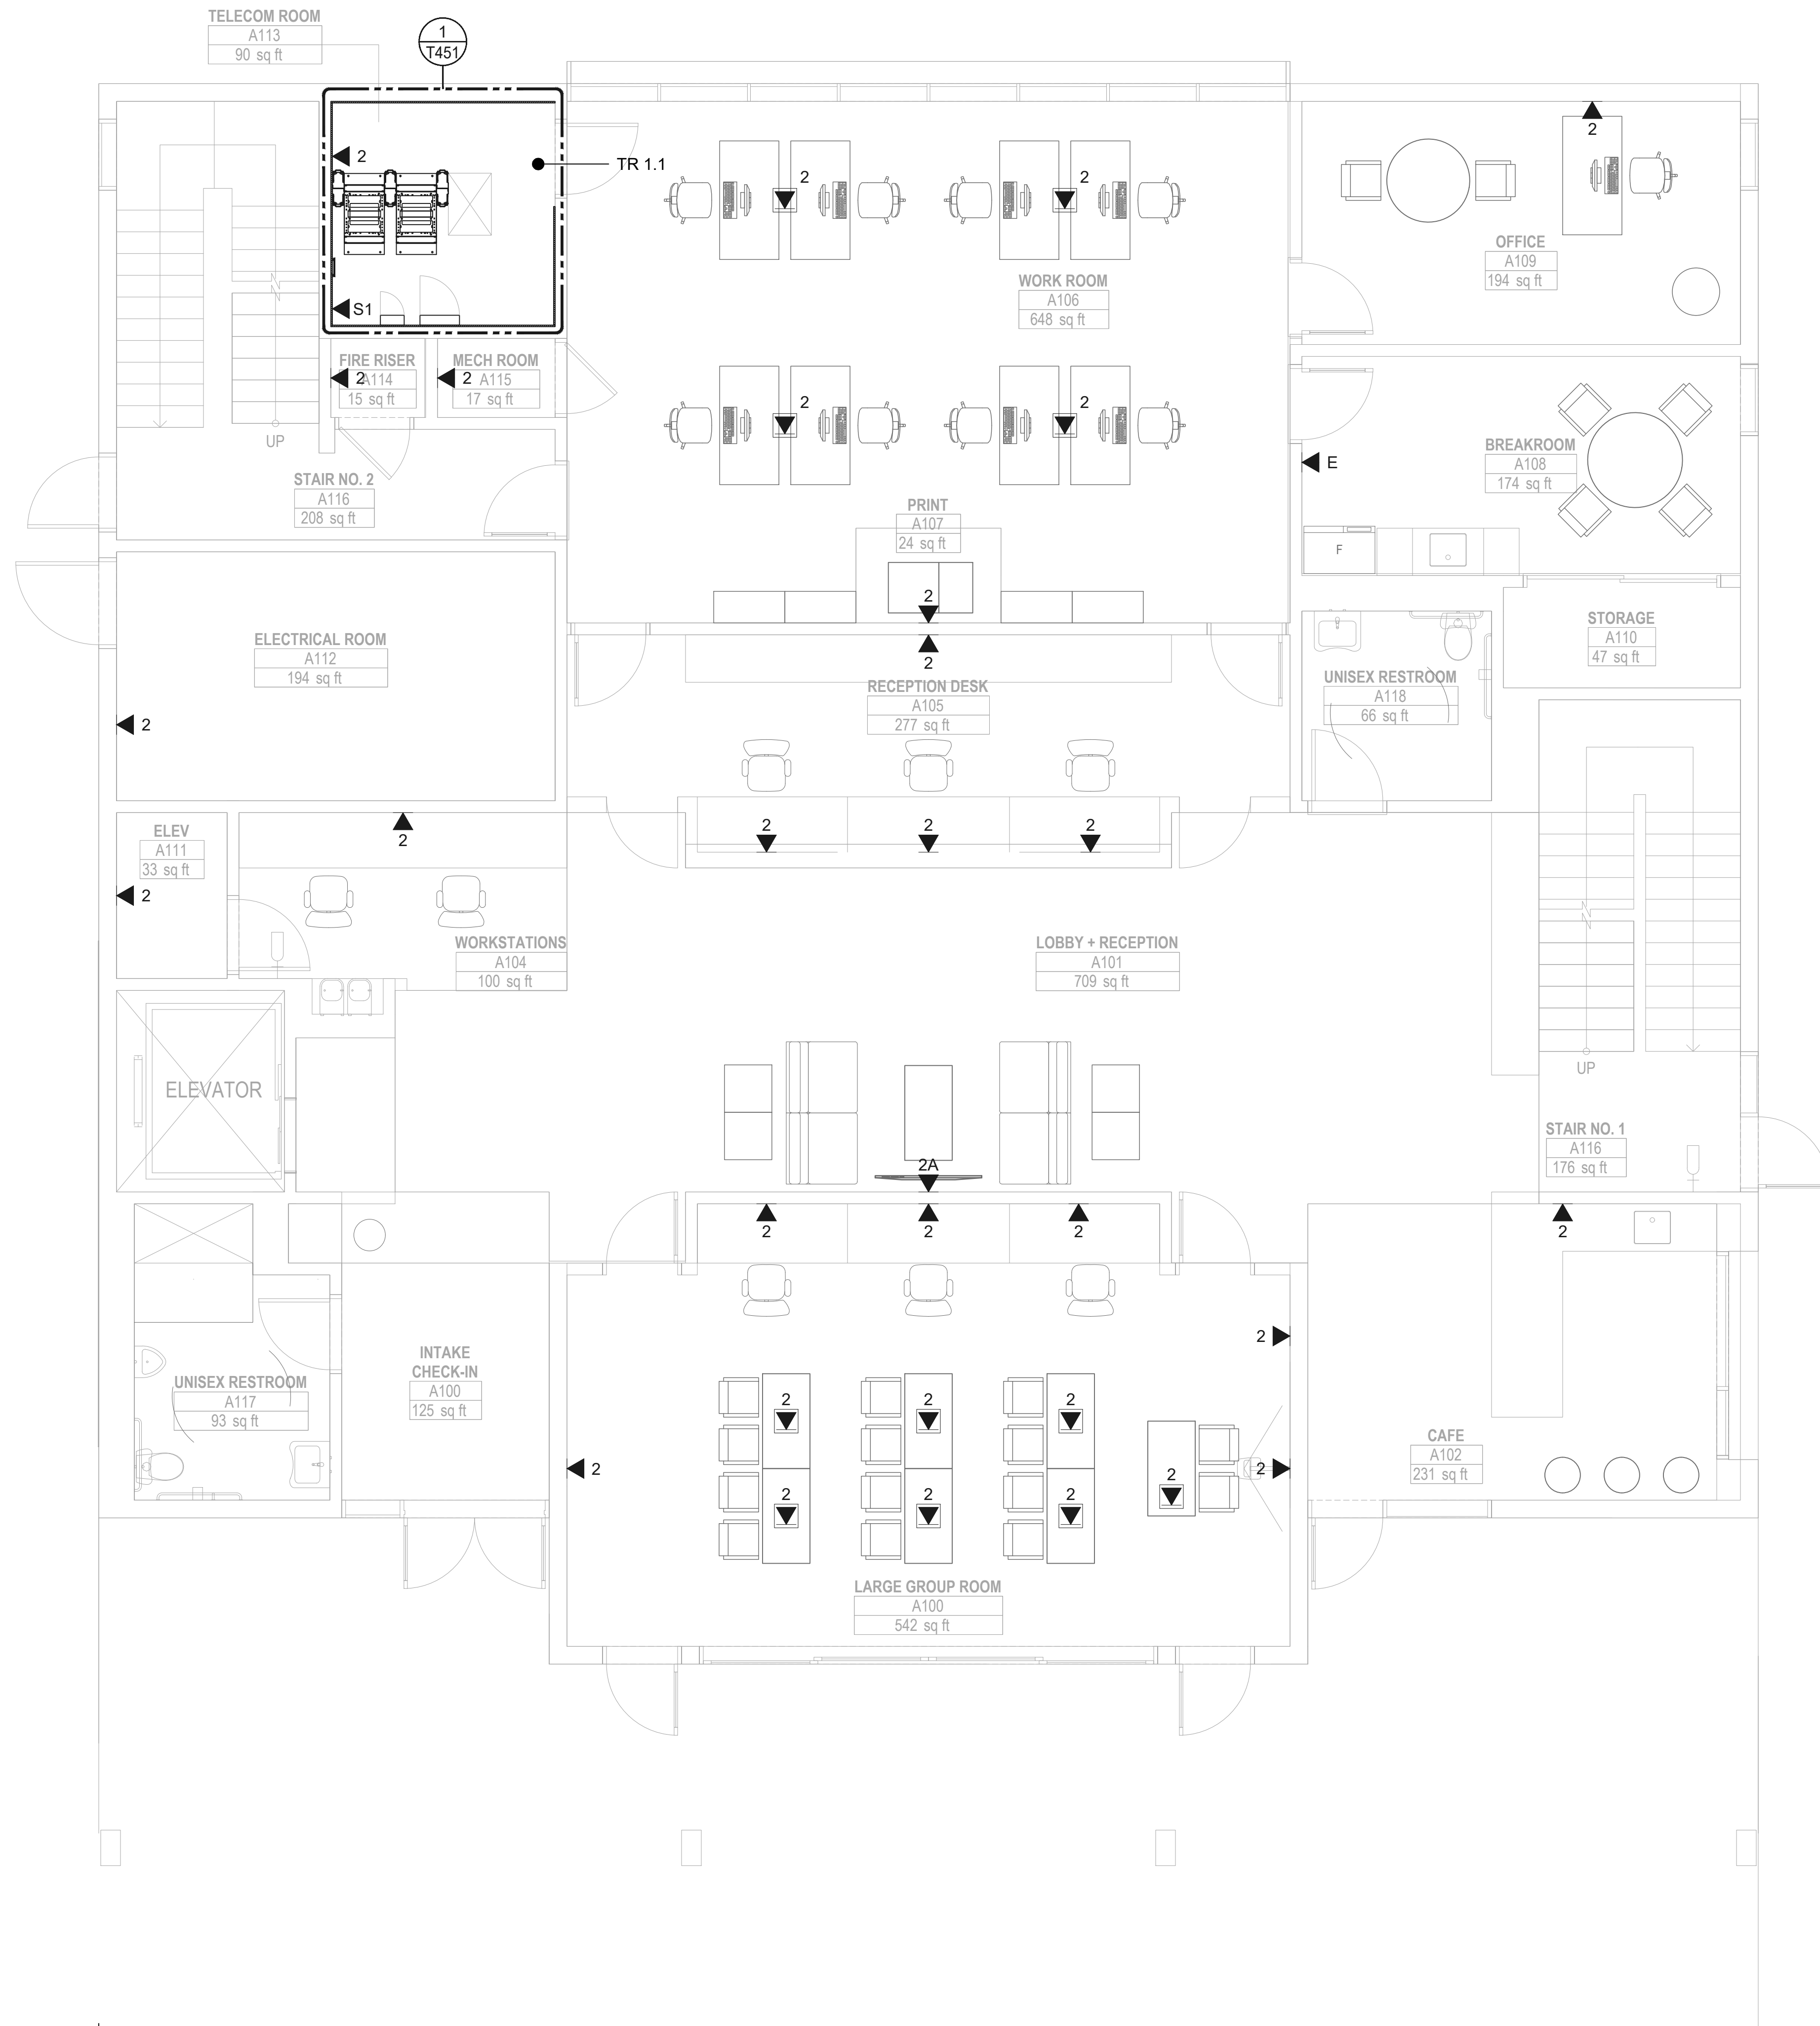
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SHEET NO. \_\_\_\_\_

SHEET NO. \_\_\_\_\_

T100





TELECOM FIRST FLOOR PLAN

SCALE:  
1/4" = 1'-0"

1



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23007

DRAWING TITLE

**TELECOM FIRST  
FLOOR PLAN**

SCALE  
AS NOTED

DATE  
02/28/2024


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SHEET NO.

T111





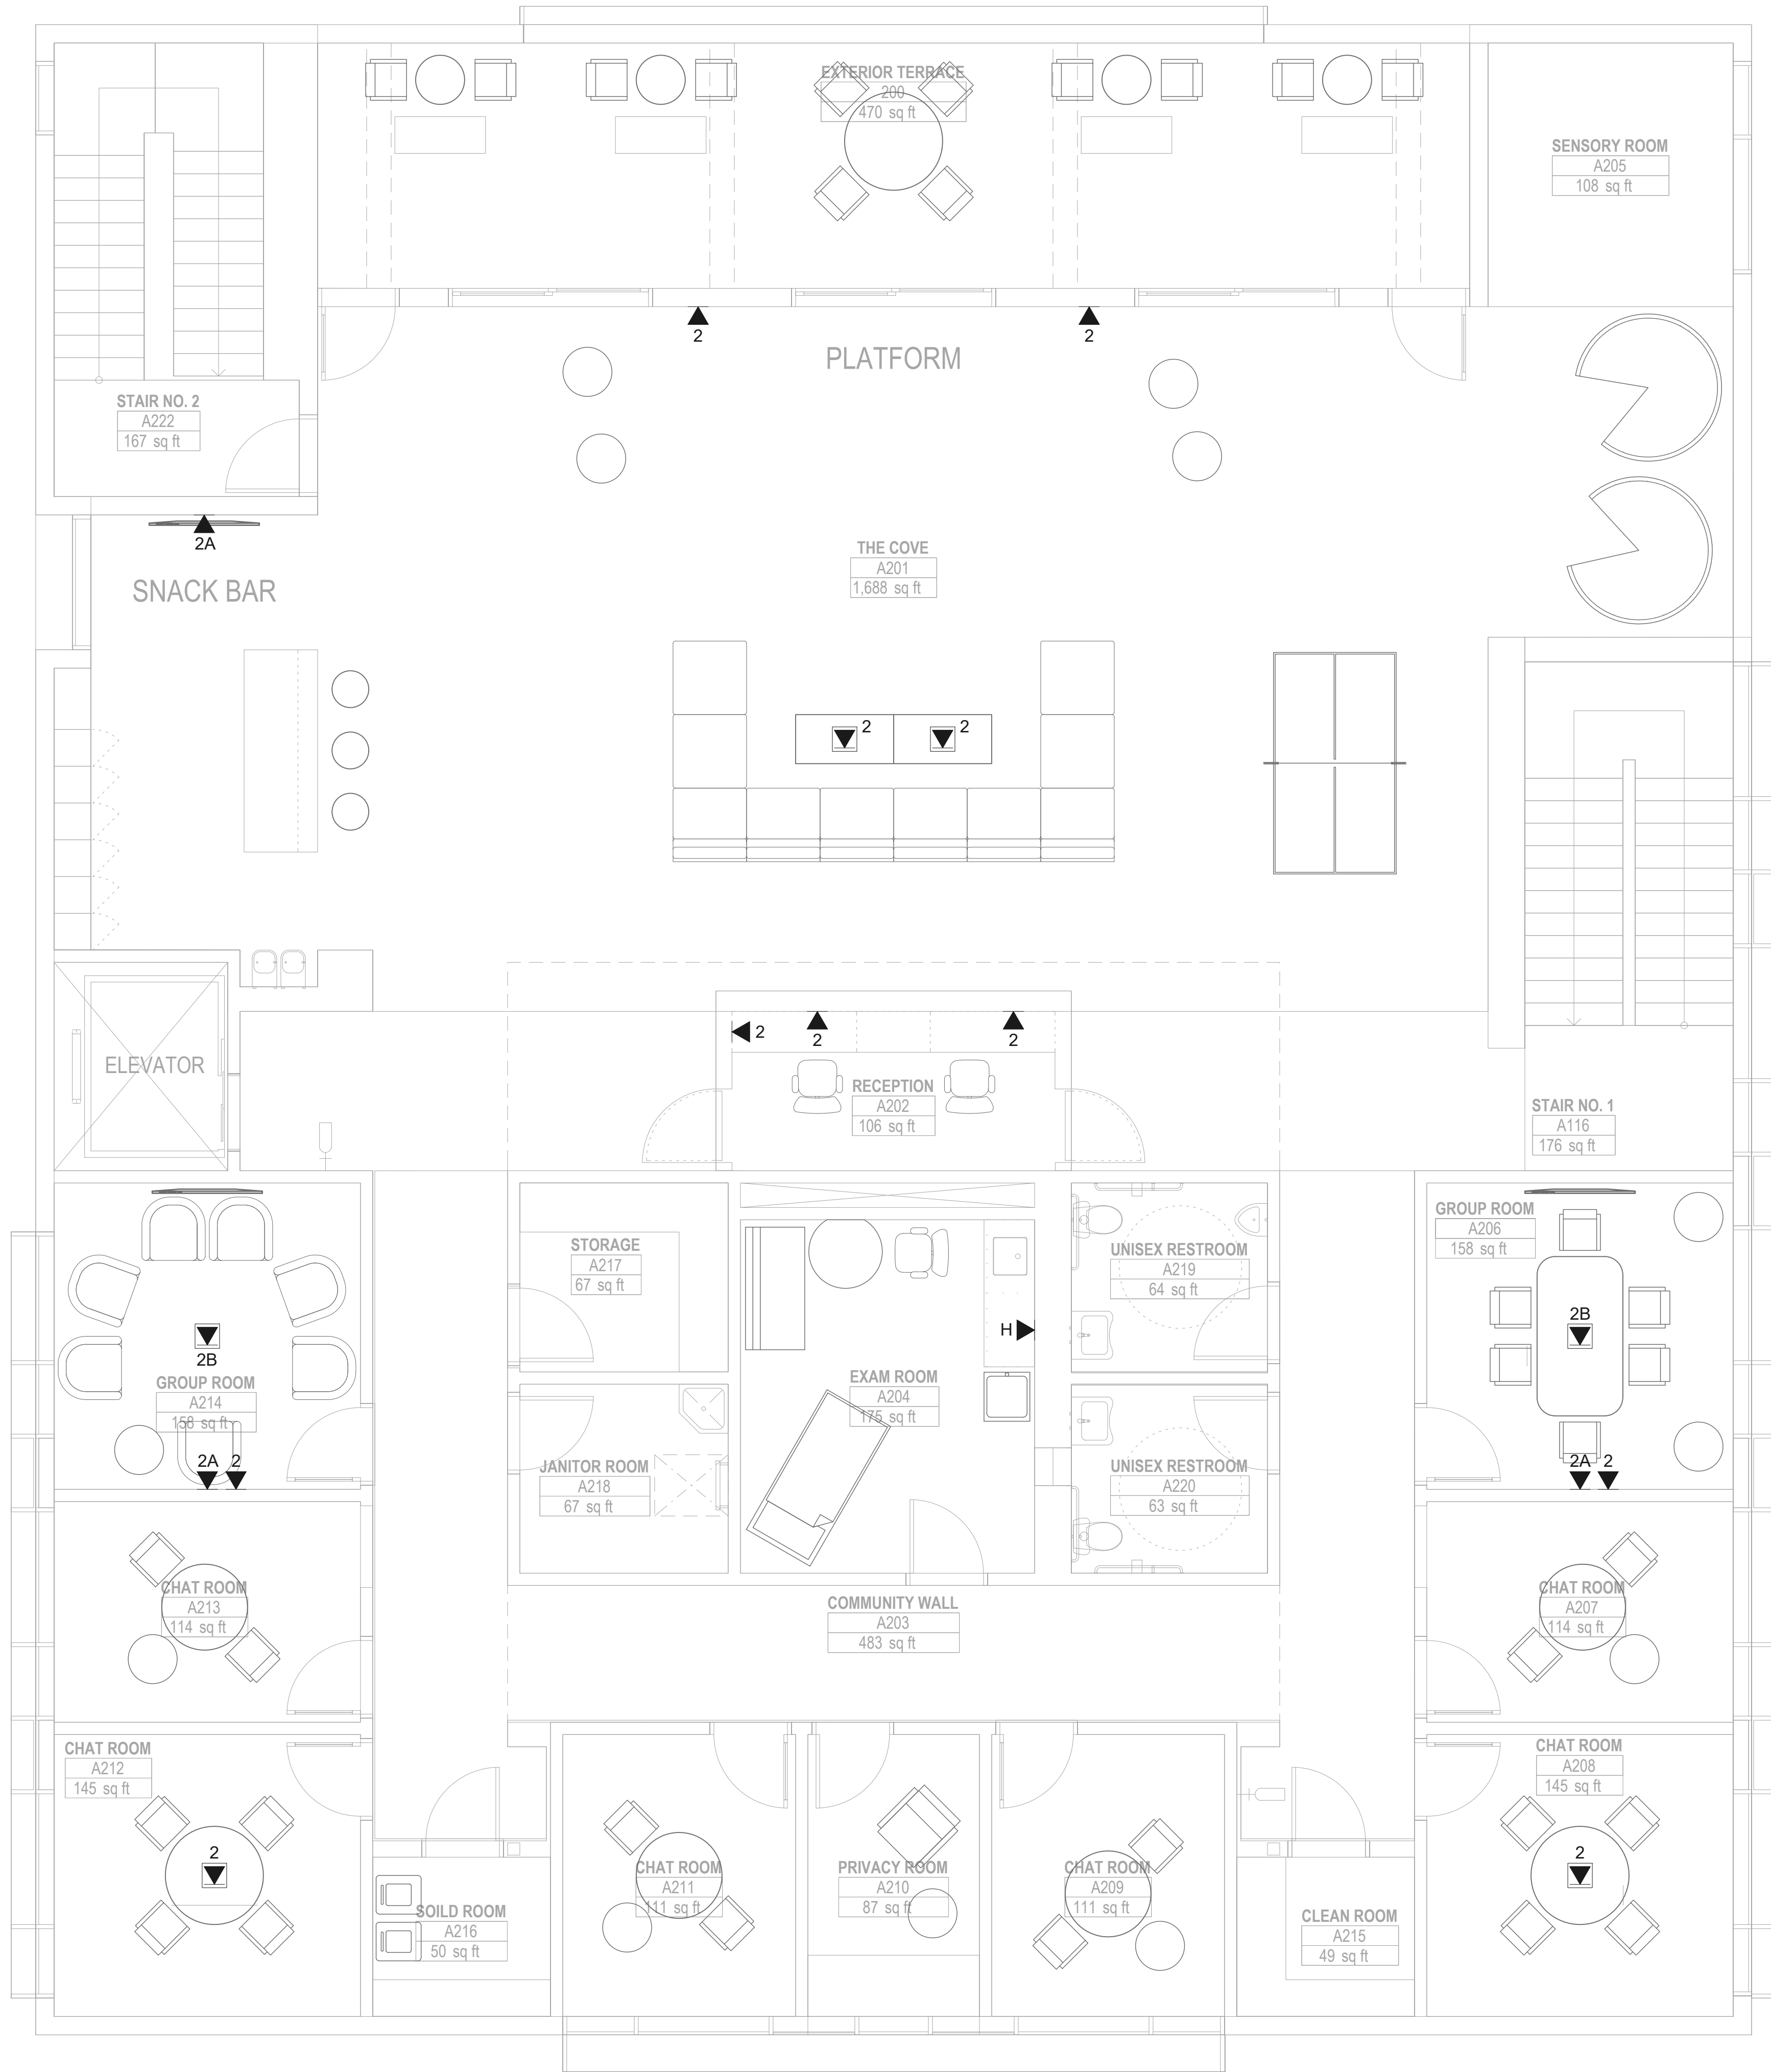TELECOM SECOND FLOOR PLAN

SCALE:  
1/4" = 1'-0"

1



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PMA PROJECT NO.  
23007

DRAWING TITLE  
**TELECOM SECOND  
FLOOR PLAN**

SCALE  
AS NOTED


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SHEET NO.

T112





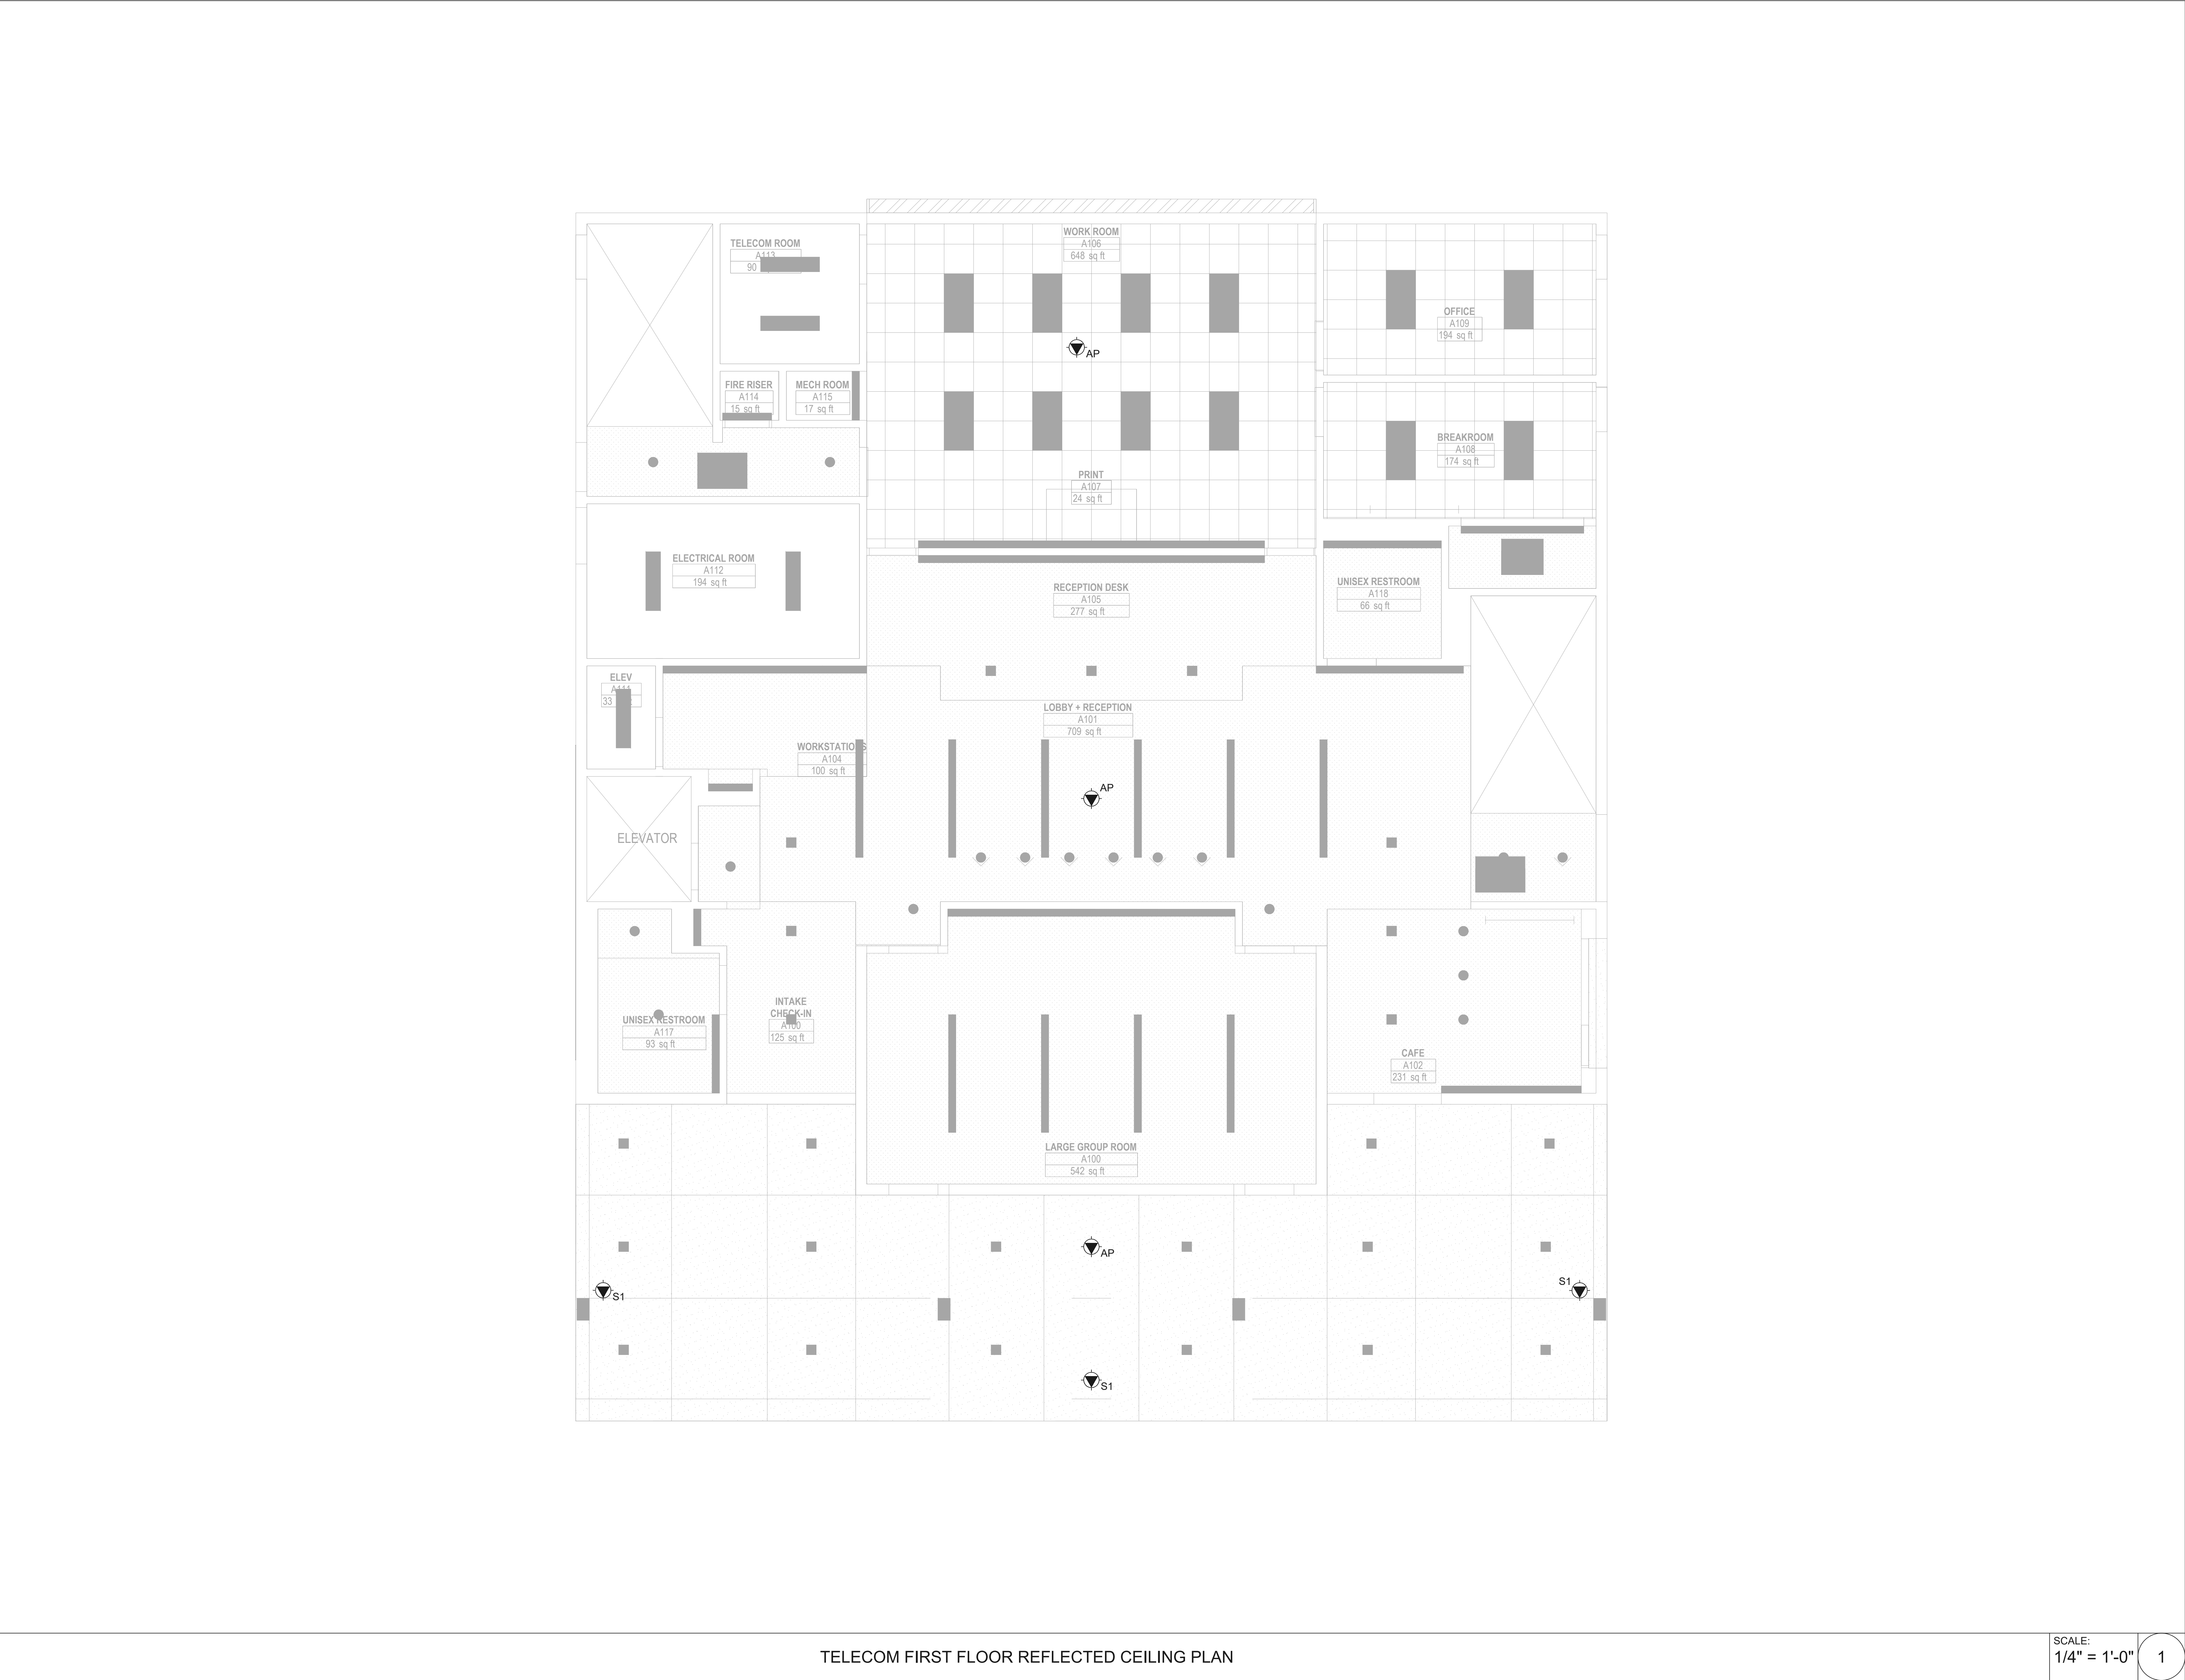TELECOM FIRST FLOOR REFLECTED CEILING PLAN

SCALE:  
1/4" = 1'-0"

1



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PMA PROJECT NO.  
23007

DRAWING TITLE

**TELECOM FIRST  
FLOOR REFLECTED  
CEILING PLAN**

SCALE  
AS NOTED


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SHEET NO.

T211





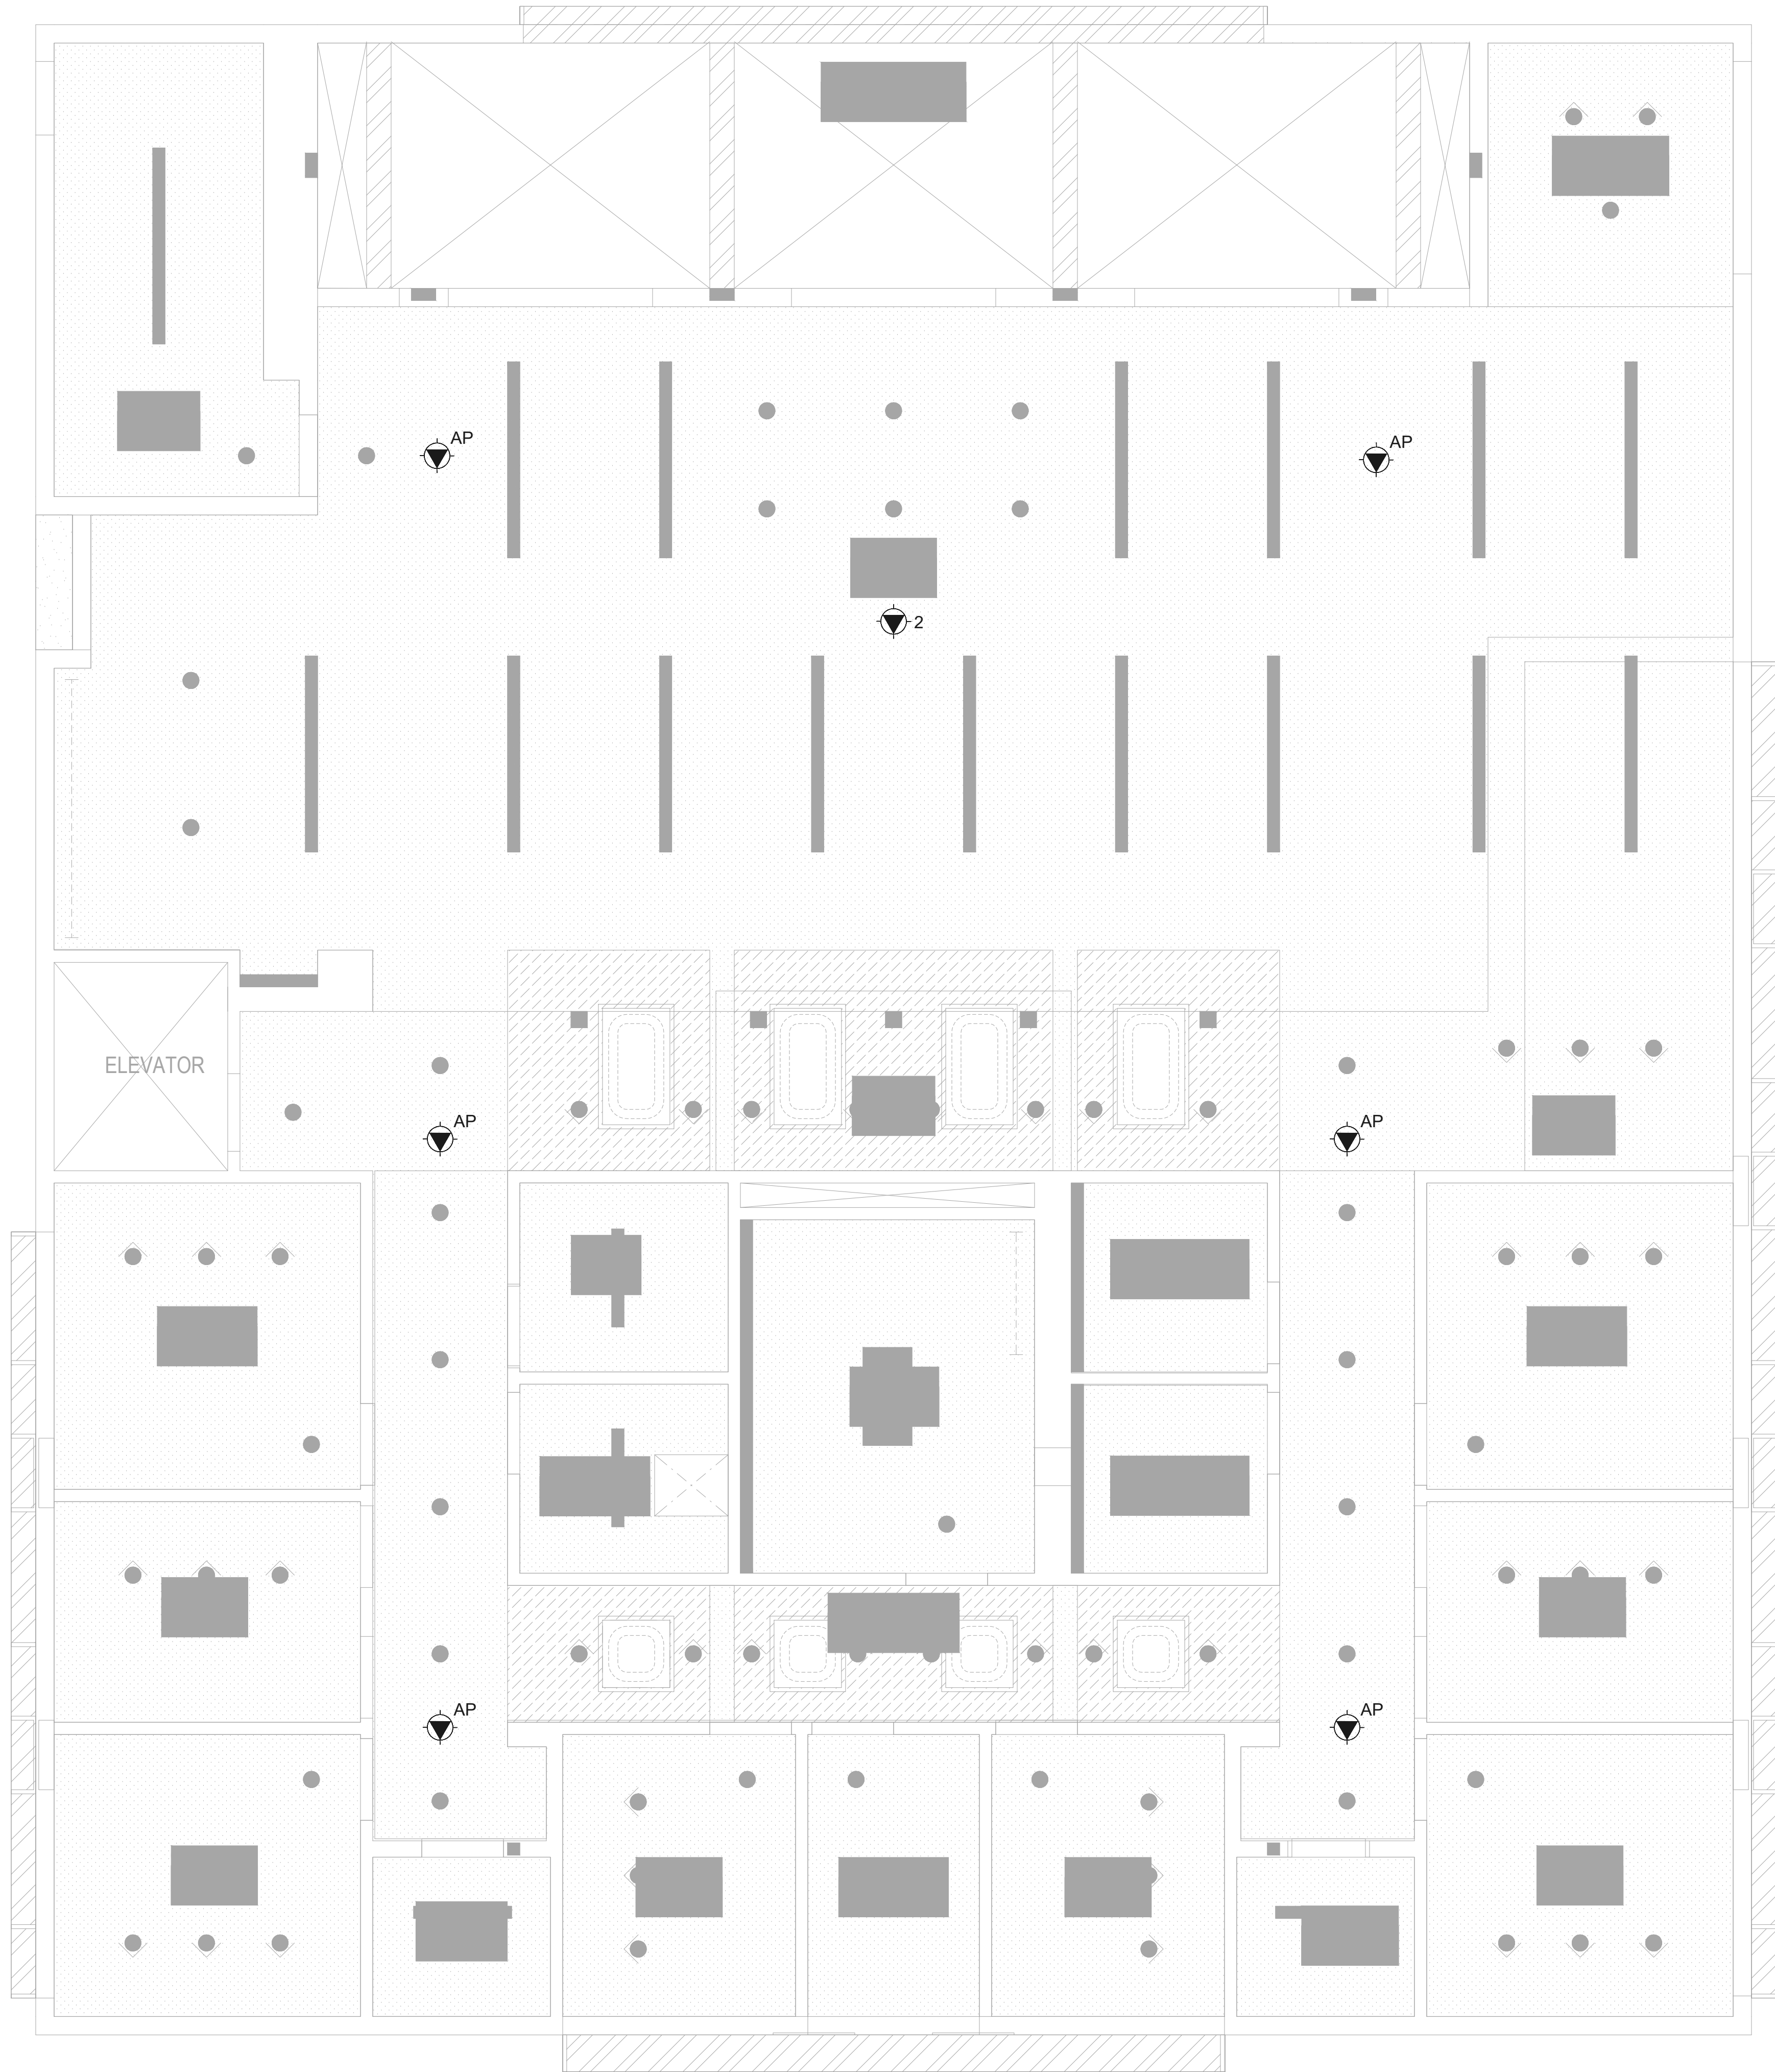TELECOM SECOND FLOOR REFLECTED CEILING PLAN

SCALE:  
1/4" = 1'-0"

1



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23007

DRAWING TITLE  
**TELECOM SECOND  
FLOOR REFLECTED  
CEILING PLAN**

SCALE  
AS NOTED

DATE  
02/28/2024

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SHEET NO.

T212

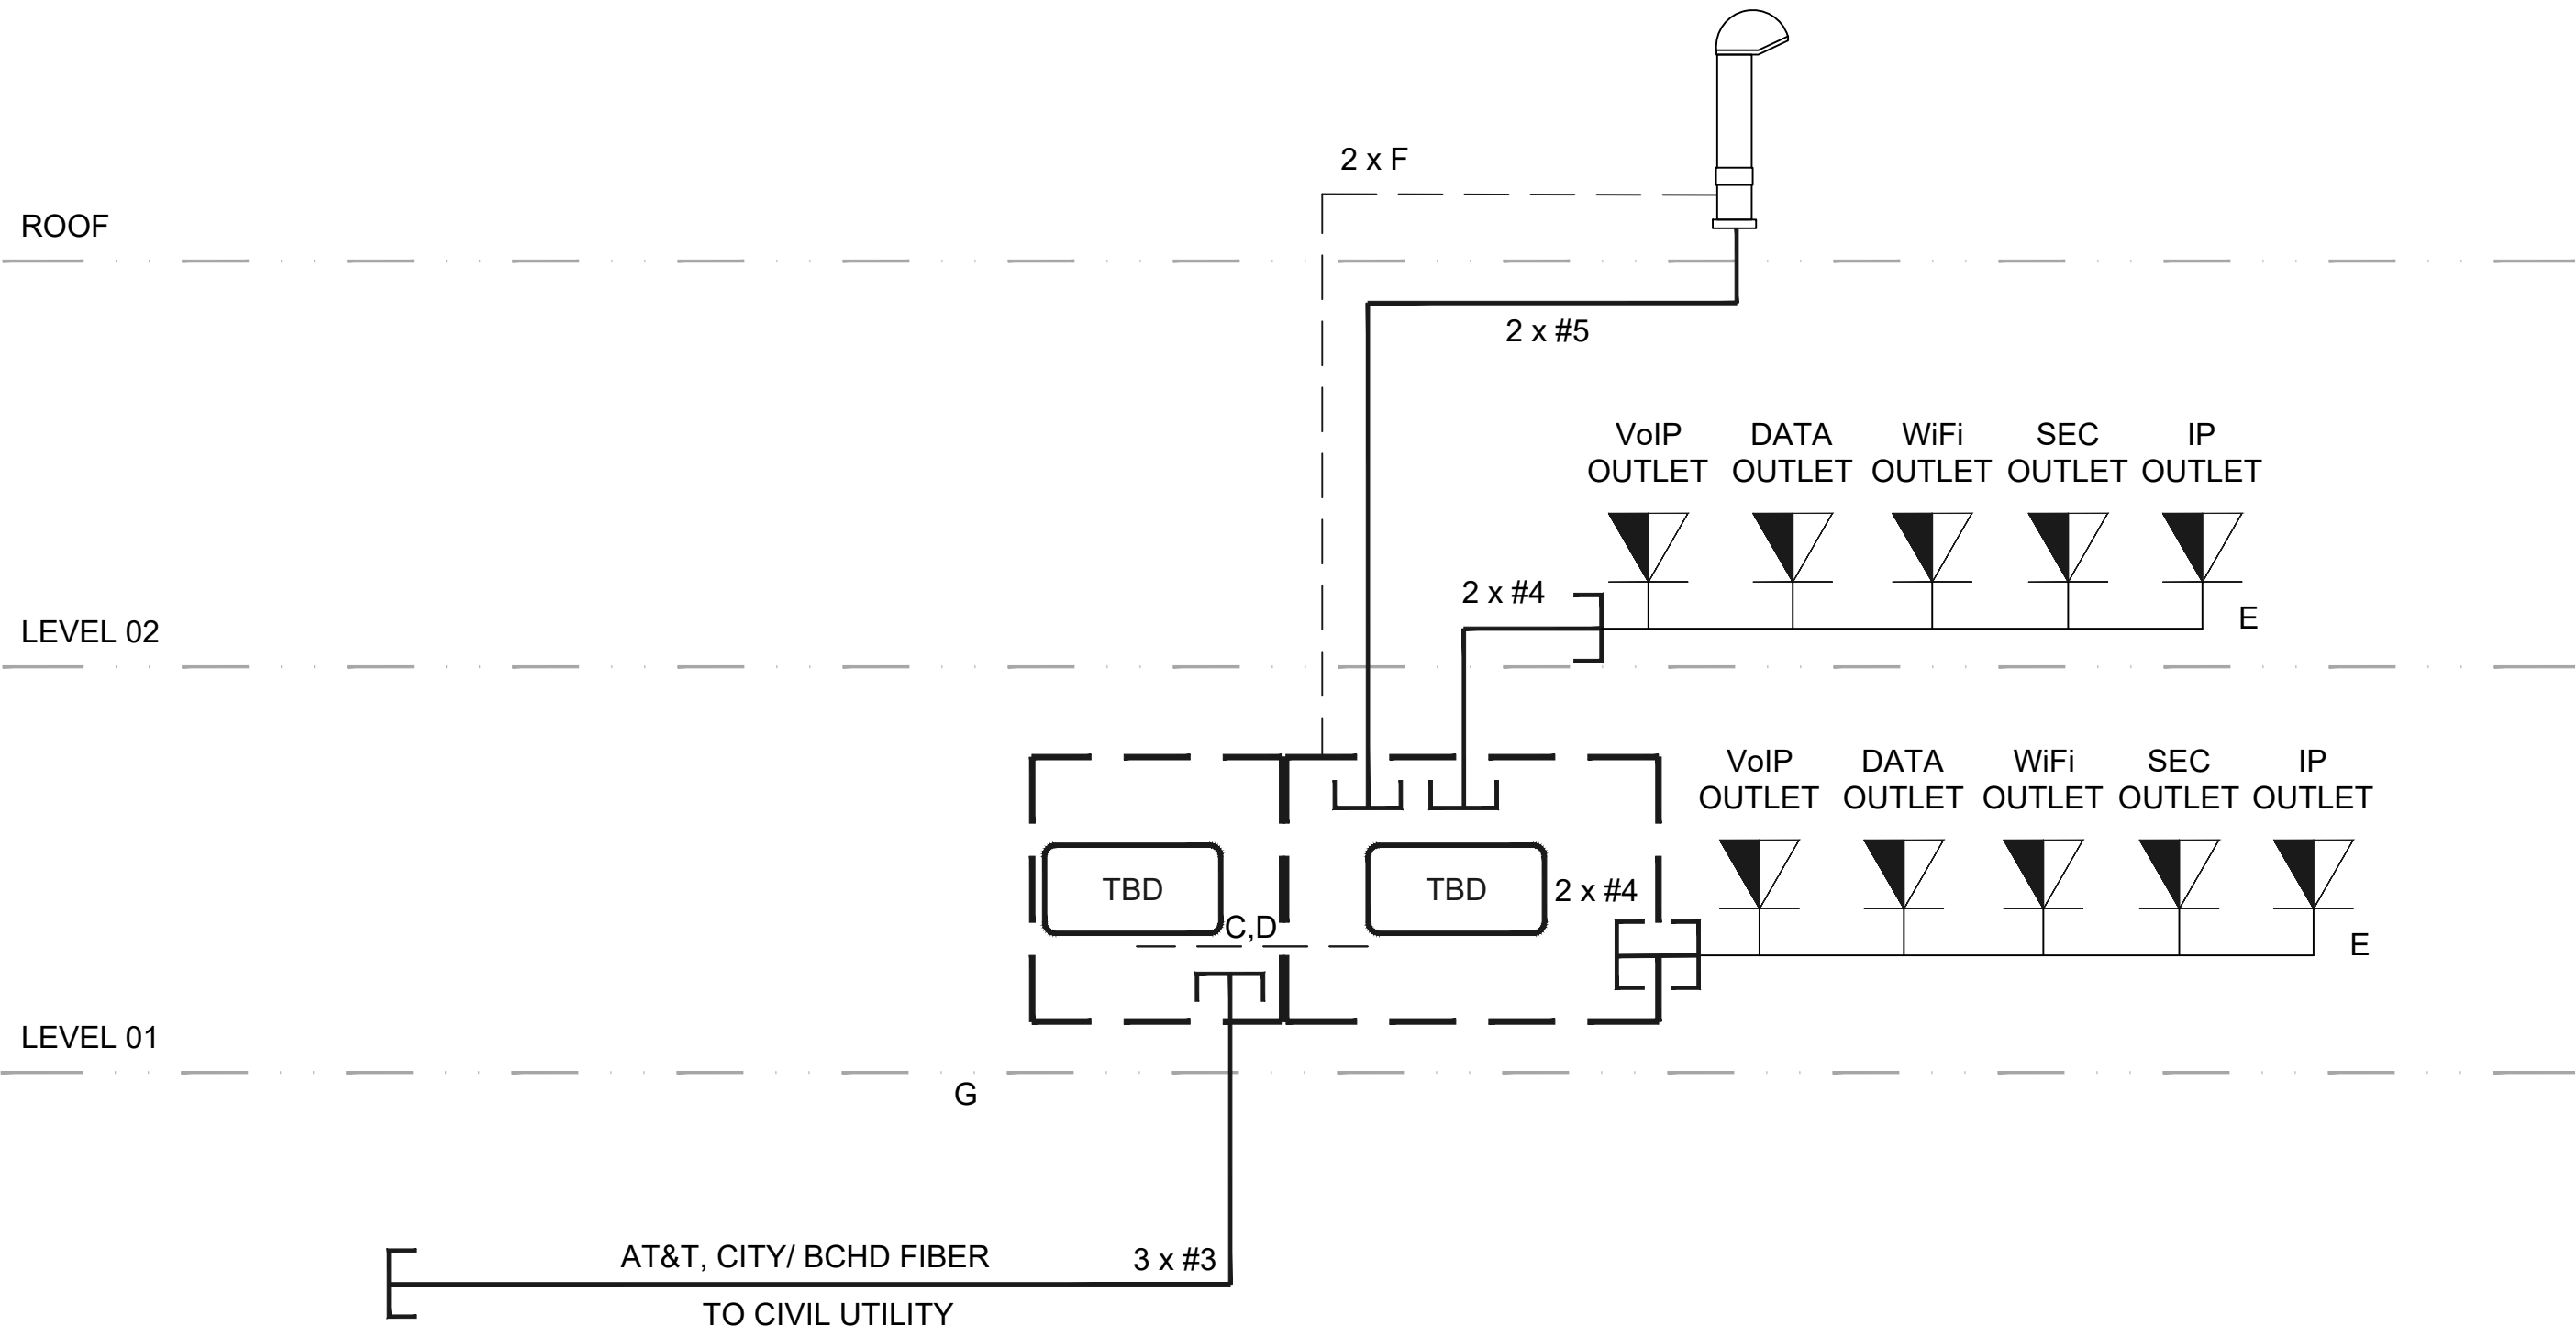


IT/TELECOM CABLING LEGEND

"A" = (1) 06STR/SM-OSP  
"B" = (1) 25PR/CAT.3/ARMM  
"C" = (1) 24STR/SM/OFNR  
"D" = (1)25PR/CAT.3/T&Rx24  
"E" = (#) CAT. 6A/CMX/UTP  
"F" = (#) RG11/CMR

CONDUIT PATHWAYS LEGEND

"#1" = 1" PVC CONDUIT  
"#2" = 2" PVC CONDUIT  
"#3" = 3" PVC CONDUIT  
"#4" = 4" EMT CONDUIT  
"#5" = 2" EMT CONDUIT



TELECOM RISER DIAGRAM

SCALE:  
NTS

1



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PMA PROJECT NO.  
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DRAWING TITLE

**TELECOM RISER  
DIAGRAM**

SCALE  
AS NOTED


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SHEET NO.

T401






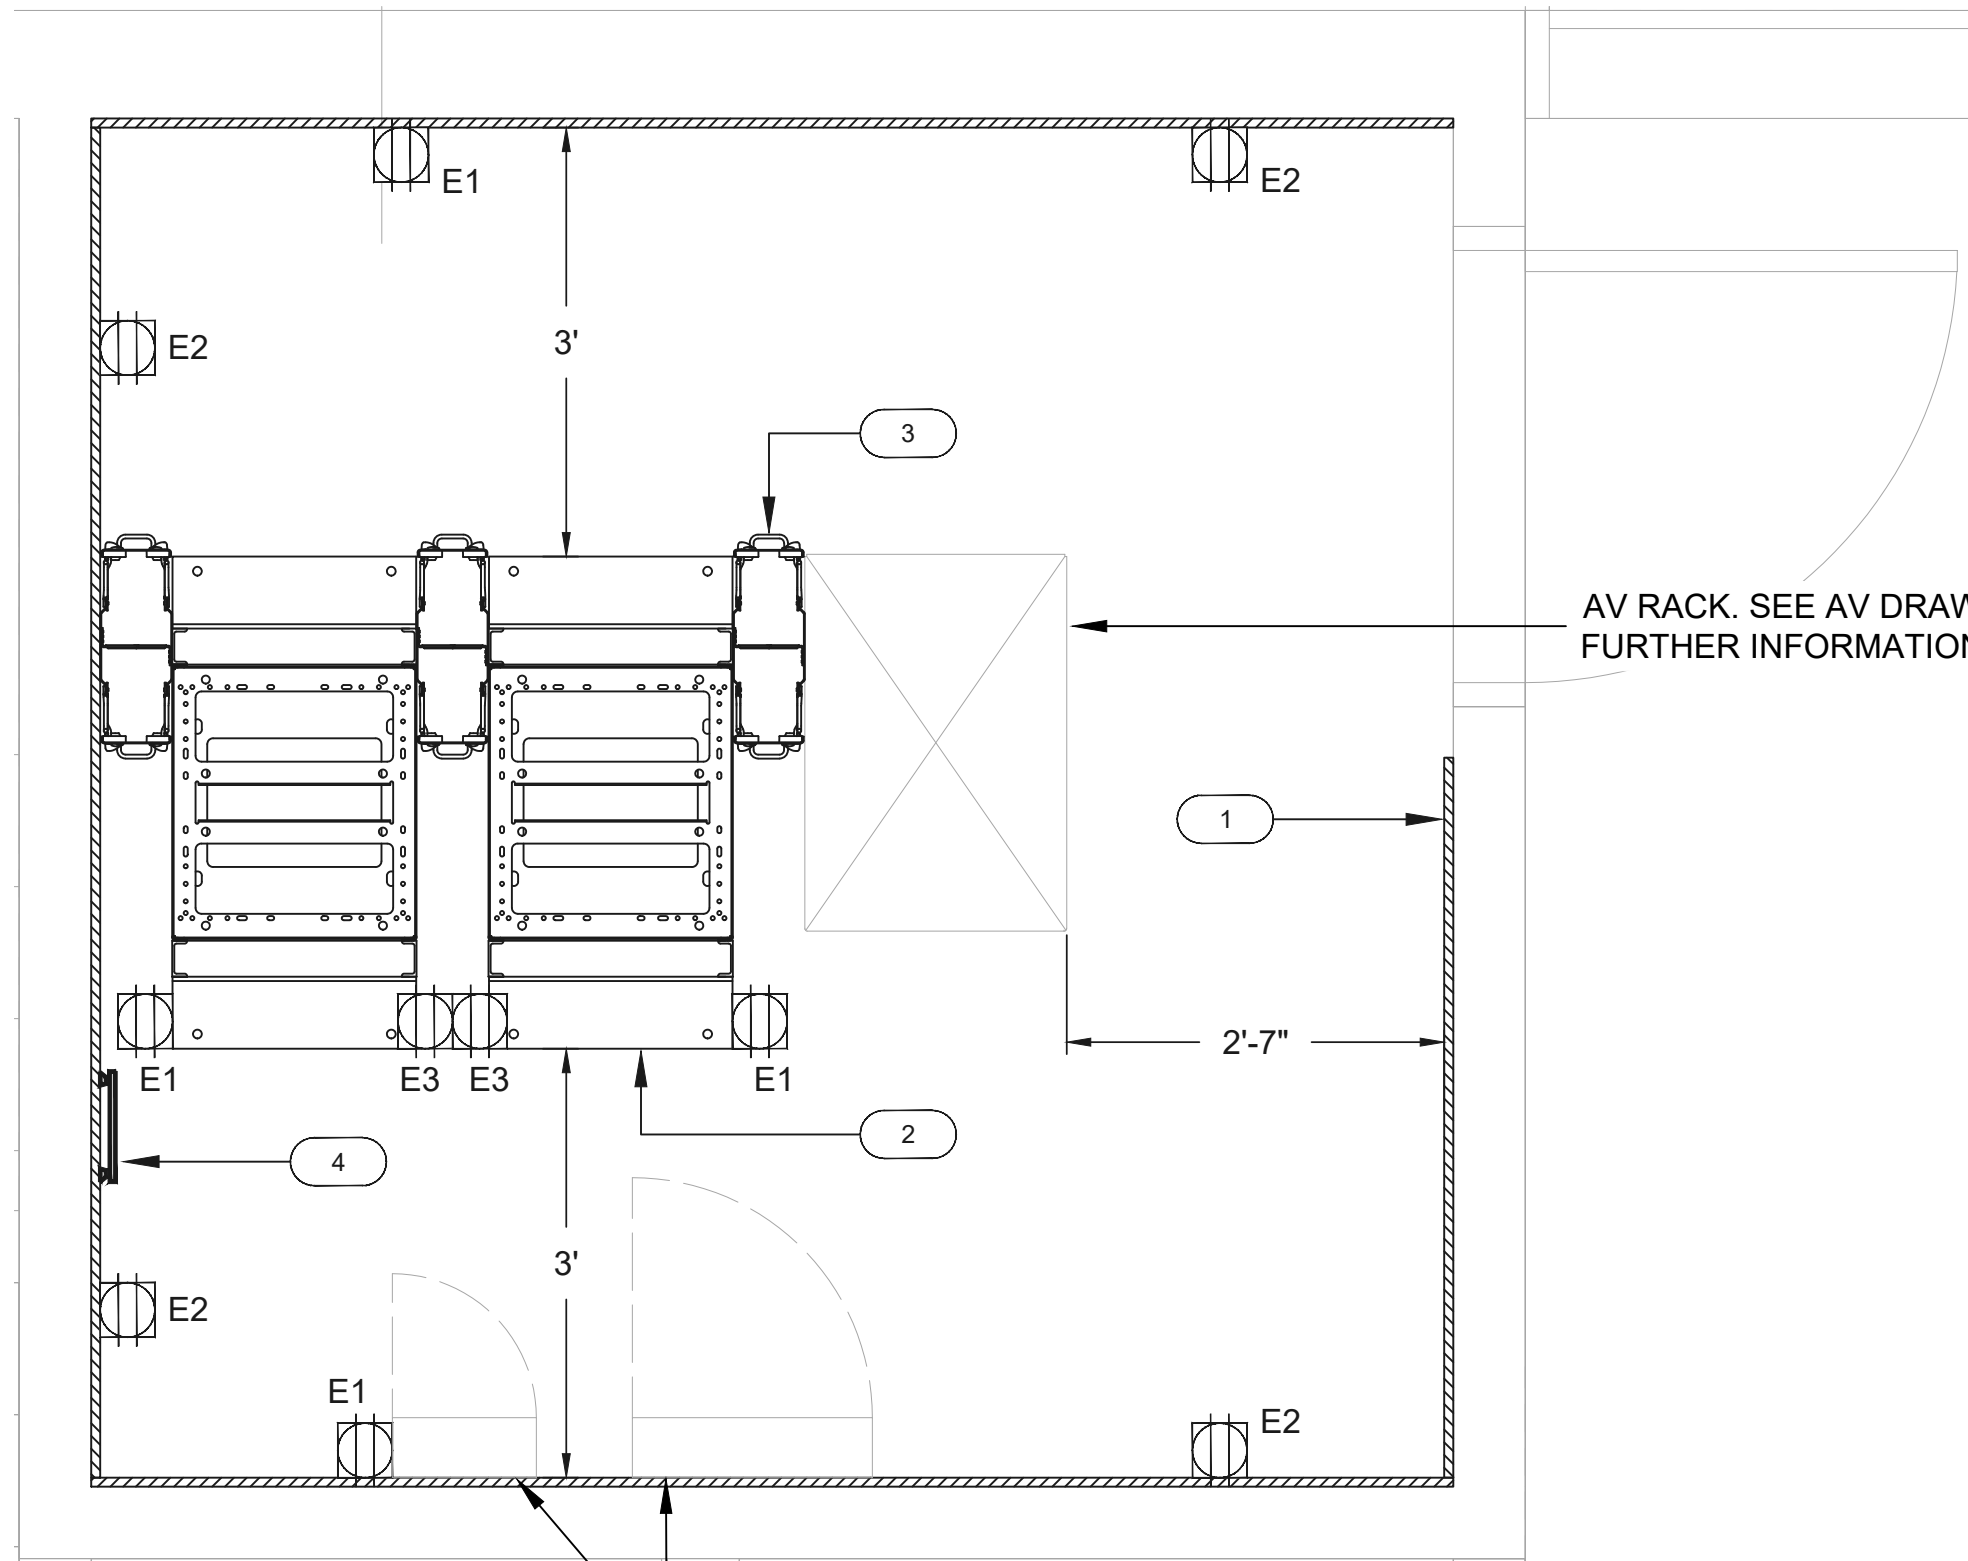TR 1.1 (TELECOM ROOM A113) - TELECOM EQUIPMENT PLAN LAYOUT

SCALE:  
3/4" = 1'-0"

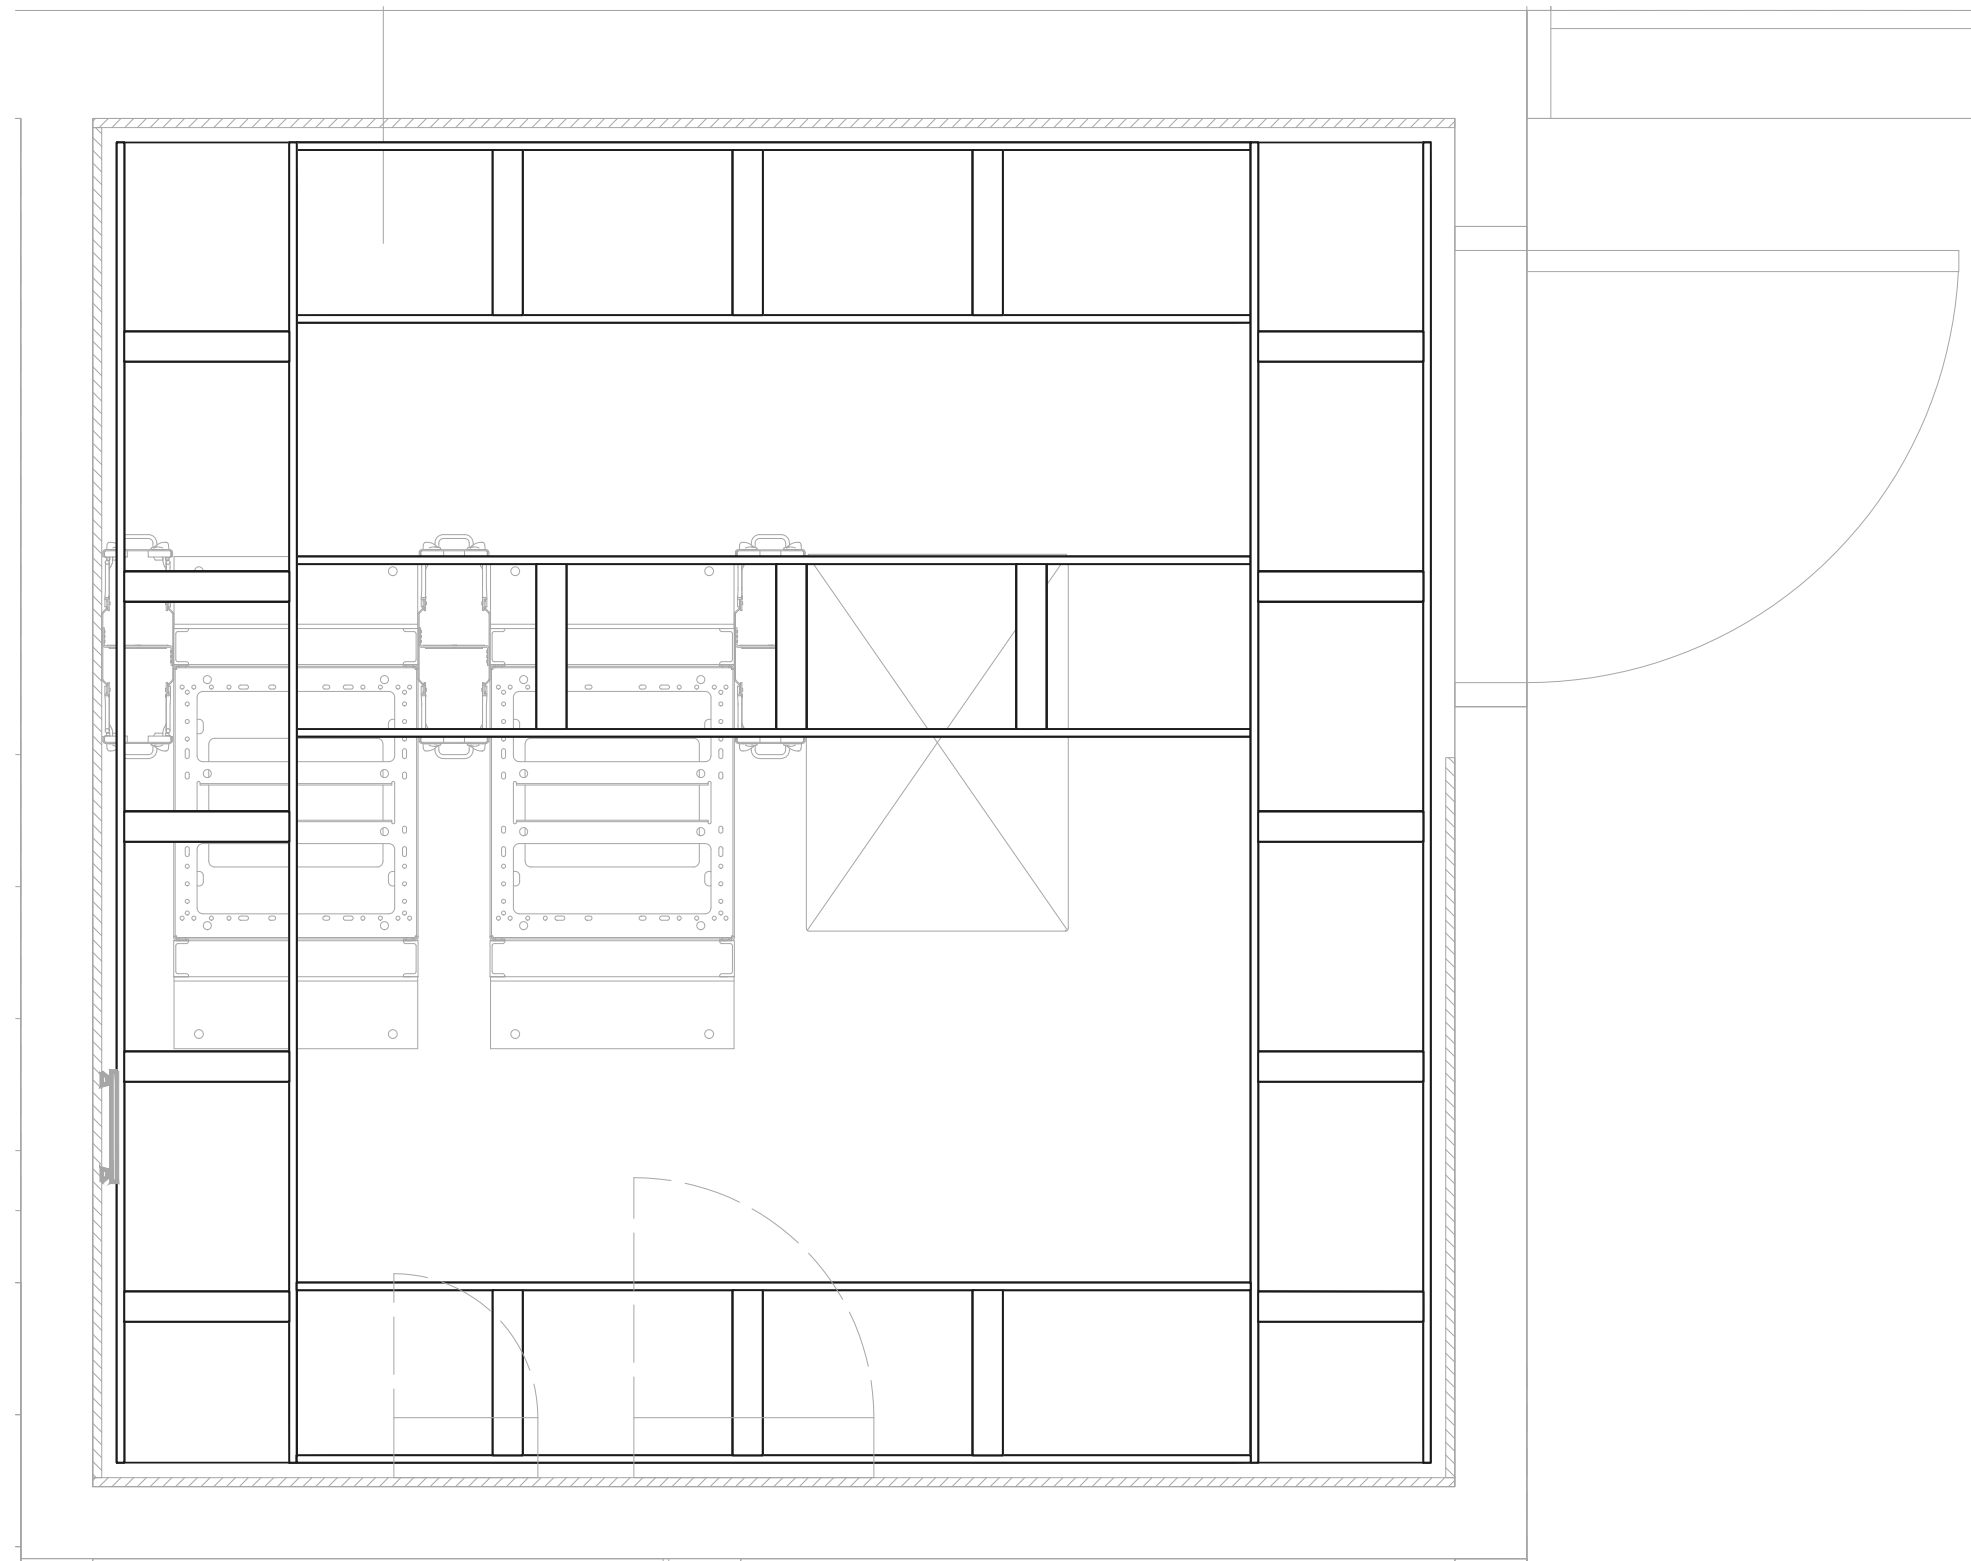1



TR 1.1 (TELECOM ROOM A113) - CABLE TRAY PATHWAYS

SCALE:  
3/4" = 1'-0"

2

##	TELECOMMUNICATION KEYNOTES
1	3/4" FIRE-TREATED PLYWOOD
2	QUAD-POST RACK
3	CABLE MANAGER
4	TELECOMMUNICATIONS MAIN GROUNDING BUSBAR

ELECTRICAL KEYNOTES	
E1	(1) L5/20R OUTLET / PRIMARY
E2	(1) 5-15P CONVENIENCE OUTLET (PSRH)
E3	(1) L6/30R CONVENIENCE OUTLET / UPS

\* ELECTRICAL FOR COORDINATION ONLY

DEVICE ID	DESCRIPTION	BOX TYPE	BOX SIZE	INSTALL METHOD	ELEVATION	VOLTAGE	WATTAGE	CIRCUITS	RECEPTICAL TYPE	RECEPTICAL LOCATION	DATA DROP	DATA LOCATION	BTUs/HR	UTILIZATION	ADJ-BTU
UPS/1.1.1	RACKMOUNTABLE UPS / 4RU / MDF/TR1.1 / RELAY RACK #1	4SD	4"X4"X2-1/2"	LADDER RACK STRINGER	7'-6" AFF	208	6240	1	L6-30R	MDF/TR1.1 / RELAY RACK #1	1	UPS-NIC	21291	70%	14903
UPS/1.1.2	RACKMOUNTABLE UPS / 4RU / MDF/TR1.1 / RELAY RACK #2	4SD	4"X4"X2-1/2"	LADDER RACK STRINGER	7'-6" AFF	208	6240	1	L6-30R	MDF/TR1.1 / RELAY RACK #2	1	UPS-NIC	21291	70%	14903
MDF/TR 1.1 ROOM TOTALS - UPS							12480	2			2		42582		29806
DEVICE ID	DESCRIPTION	BOX TYPE	BOX SIZE	INSTALL METHOD	ELEVATION	VOLTAGE	WATTAGE	CIRCUITS	RECEPTICAL TYPE	RECEPTICAL LOCATION	DATA DROP	DATA LOCATION	BTUs/HR	UTILIZATION	ADJ-BTU
20A/1.2.1	RACKMOUNTABLE UPS / 4RU / MDF/TR1.1 / RELAY RACK #1	4SD	4"X4"X2-1/2"	LADDER RACK STRINGER	7'-6" AFF	120	2200	1	5-20R QUAD	MDF/TR1.1 / RELAY RACK #1	1	NA	7500	70%	5200
20A/1.2.2	RACKMOUNTABLE UPS / 4RU / MDF/TR1.1 / RELAY RACK #2	4SD	4"X4"X2-1/2"	LADDER RACK STRINGER	7'-6" AFF	120	2200	1	5-20R QUAD	MDF/TR1.1 / RELAY RACK #2	1	NA	7500	70%	5200
20A/1.2.3	DEDICATED CIRCUIT / WALL / MPOE	4SD	4"X4"X2-1/2"	PROJECT STANDARD	PSMH	120	2200	1	5-20R QUAD	WALL- PROJECT STANDARD	1	NA	7500	70%	5200
20A/1.2.4	DEDICATED CIRCUIT / WALL / SECURITY SYSTEM	4SD	4"X4"X2-1/2"	SEE SECURITY SHEETS	SC SHEETS	120	2200	1	5-20R QUAD	SEE SECURITY SHEETS	1	NA	7500	70%	5200
MDF/TR 1.1 ROOM TOTALS - DEDICATED							8800	4			4		30000		20800
DEVICE ID	DESCRIPTION	BOX TYPE	BOX SIZE	INSTALL METHOD	ELEVATION	VOLTAGE	WATTAGE	CIRCUITS	RECEPTICAL TYPE	RECEPTICAL LOCATION	DATA DROP	DATA LOCATION	BTUs/HR	UTILIZATION	ADJ-BTU
15A/1.3.1	SHARES CIRCUIT / WALL / UTILITY OUTLET	4SD	4"X4"X2-1/2"	PROJECT STANDARD	PSMH	120	1200	1	5-15R	WALL	1	NA	4100	70%	2870
15A/1.3.2	SHARES CIRCUIT / WALL / UTILITY OUTLET	4SD	4"X4"X2-1/2"	PROJECT STANDARD	PSMH	120	1200	1	5-15R	WALL	1	NA	4100	70%	2870
15A/1.3.3	SHARES CIRCUIT / WALL / UTILITY OUTLET	4SD	4"X4"X2-1/2"	PROJECT STANDARD	PSMH	120	1200	1	5-15R	WALL	1	NA	4100	70%	2870
MDF/TR 1.1 ROOM TOTALS - SHARED							3600	3			3		12300		8610

\* ELECTRICAL FOR COORDINATION ONLY



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NO. DATE REVISION

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BEACH CITIES  
HEALTH DISTRICT

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DESIGN SUBMITTAL**

PMA PROJECT NO.  
23007

DRAWING TITLE

**TELECOM  
EQUIPMENT PLAN  
LAYOUTS**

SCALE  
**AS NOTED**

DATE  
02/28/2024

DRAWN CHECKED

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SHEET NO.

**T451**



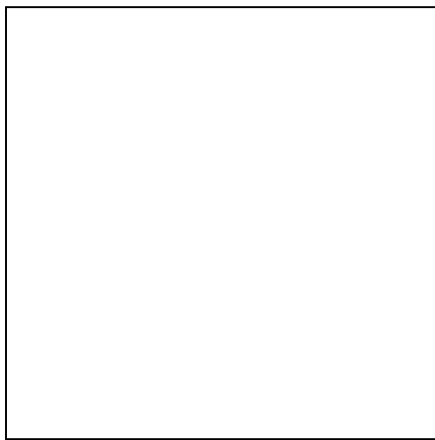
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ALLCOVE  
REDONDO BEACH, CA



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PMA PROJECT NO.  
23007

DRAWING TITLE

**AV GENERAL NOTES  
AND SHEET INDEX**

SCALE  
AS NOTED

DATE  
02/28/2024

DRAWN  
JB

CHECKED  
PA

SHEET NO.

**AV001**

GENERAL NOTES

REFER TO AUDIO VISUAL SPECIFICATION SECTION FOR COMPLETE REQUIREMENTS

- ELECTRICAL
  - ALL CONDUITS, JUNCTION BOXES, BACK BOXES, PULL STRING AND POWER OUTLETS BY DIVISION 26 CONTRACTOR AS REQUIRED.
  - ELECTRICAL CONTRACTOR TO PROVIDE PULLSTRING ON ALL AV CONDUIT.
  - ALL POWER TO AV EQUIPMENT TO ORIGINATE FROM DEDICATED AUDIO VIDEO LOAD CENTER IN ACCORDANCE WITH THE LATEST LOCAL AND NATIONAL CODES REFERENCING "TECHNICAL POWER SYSTEMS", NEC ARTICLE 640.
  - BRANCH CIRCUITS FEEDING AUDIO-VISUAL EQUIPMENT MUST NOT ORIGINATE FROM LOAD CENTERS CONNECTED TO INDUCTIVE LOADS.
  - PROVIDE ALL AV CIRCUITS WITH ISOLATED GROUND, DEDICATED NEUTRAL.
- COORDINATE
  - COORDINATE WITH THE WORK OF ALL SECTIONS. COORDINATE THE LOCATION OF BLOCKING AND BACKING REQUIRED BY THIS SECTION. MAKE REASONABLE MINOR ADJUSTMENTS TO PRESERVE ARCHITECTURAL SYMMETRY AND ALIGNMENT WITH ADJACENT FEATURES AT NO CLAIM FOR ADDITIONAL COST OR TIME. PRESENT CONFLICTS IN TIMELY MANNER FOR RESOLUTION.
  - RELOCATION, REVISION OR CORRECTION CAUSED BY FAILURE OF THE CONTRACTOR TO COORDINATE THE WORK SHALL NOT BE SUBJECT TO CLAIM FOR ADDITIONAL COST OR TIME.
  - POWER RECEPTACLES SHOWN ON THE AV DRAWINGS OUTSIDE OF EQUIPMENT RACKS ARE SHOWN FOR COORDINATION INFORMATION ONLY. REFER TO DIVISION 26 DOCUMENTS FOR CONSTRUCTION.
  - THESE DRAWINGS SHOW SCOPE. THE EXACT LOCATION & ELEVATIONS OF LOUDSPEAKERS, RECEPTACLES AND DEVICES MUST BE COORDINATED WITH THE ARCHITECTURAL DRAWINGS.
  - CONDUIT, BACK BOXES AND PULL BOXES SUPPLIED AND INSTALLED BY ELECTRICAL CONTRACTOR UNDER SUPERVISION OF AV CONTRACTOR.
  - GENERAL CONTRACTOR SHALL COORDINATE THE CONDUIT, DEVICES, PATHWAYS AND JUNCTION BOXES FOR THE AV SYSTEM WITH OTHER TRADE TO AVOID ANY CONFLICTS.
- LOCATIONS AND DIMENSIONS
  - LOCATIONS AND DIMENSIONS SHOWN ON ARCHITECTURAL DRAWINGS TAKE PRECEDENCE OVER THESE AV DRAWINGS. IN CASE OF APPARENT CONFLICT OR AMBIGUITY, SUBMIT TO THE ARCHITECT IN TIMELY MANNER FOR RESOLUTION.
  - DIMENSIONS TAKE PRECEDENCE OVER SCALE. LARGE SCALE DRAWINGS TAKE PRECEDENCE OVER SMALL. REPORT ALL CONFLICTS BEFORE INSTALLATION.
  - UNLESS OTHERWISE NOTED, DIMENSIONS ARE SHOWN HEIGHT X WIDTH X DEPTH.
  - VERIFY ALL DIMENSIONS, LOCATIONS AND CONDITIONS IN THE FIELD PRIOR TO STARTING WORK. NOTIFY ARCHITECT OF ANY APPARENT DISCREPANCIES.
- SUPPORT

PROVIDE ALL BLOCKING, BRIDGING, TIES, FASTENERS AND RELATED SUPPORT PROVISIONS FOR ALL WORK OF THIS SECTION. COMPLY WITH APPLICABLE CODE REQUIREMENTS FOR MEANS OF SUPPORT OF ELECTRICAL EQUIPMENT OF THE SAME WEIGHT UNDER THE SAME MOUNTING CONDITIONS. DO NOT APPLY ANY LOAD TO BUILDING STRUCTURE WITHOUT FIRST OBTAINING WRITTEN APPROVAL OF THE PROJECT STRUCTURAL ENGINEER. OBTAIN PER PROJECT PROCEDURES, SUPPORTS FOR RACEWAY SYSTEM BY DIVISION 26 CONTRACTOR.
- BOX, PANEL AND ENCLOSURE INSTALLATION
  - COORDINATE THE LOCATION OF ALL BOXES, PANELS, ENCLOSURES AND RELATED RACEWAY WITH THE WORK OF OTHER SECTIONS.
  - VERIFY ACCESS TO BOXES, PANELS AND ENCLOSURES COMPLY WITH APPLICABLE CODE.
  - COORDINATE AND CORRECT ALL CONDITIONS OF OCCLUSION OF ALL LOUDSPEAKER ASSEMBLIES. WHERE MORE THAN ONE (1) FLUSH MOUNTED CEILING LOUDSPEAKER HAS BEEN SCHEDULED, NONE SHALL BE LOCATED CLOSER TO ANY FIXED WALL THAN ONE-HALF (1/2) OF THE ADJACENT CLEAR HEIGHT, EXCEPT AT CEILING DISCONTINUITIES, OR WHERE SPECIFICALLY SHOWN ON THE DRAWINGS.
  - INSTALL BOXES, PANELS AND ENCLOSURES SQUARE AND PLUMB. SET FLUSH MOUNTED UNITS SO THAT THE FACE OF THE COVER, BEZEL OR ESCUTCHEON, IS IN THE SAME PLANE AS THE SURROUNDING FINISHED SURFACE. MOUNT BOXES, PANELS AND TRIM SO THAT THERE ARE NO GAPS, CRACKS OR OBVIOUS LINES BETWEEN THE TRIM AND THE ADJACENT FINISHED SURFACE.
  - UNLESS OTHERWISE NOTED, PROVIDE STEEL BOXES, PANELS AND ENCLOSURES. COMPLY WITH DIVISION 26 REQUIREMENTS AND APPLICABLE CODE.
  - UNLESS OTHERWISE NOTED, BOXES AND ENCLOSURES SHALL BE NOT LESS THAN 2-1/8 INCHES DEEP. PROVIDE THE LARGER OF THE SIZE REQUIRED BY APPLICABLE CODE OR AS SHOWN ON DRAWINGS. COORDINATE WIRE AND CABLE BEND RADIUS WITH BOX AND ENCLOSURE SIZE.
  - PULL BOXES. PROVIDE AS REQUIRED BY THE MOST RESTRICTIVE OF APPLICABLE CODE OR THE PROVISIONS OF DIVISION 26. COORDINATE WITH WIRE AND CABLE BEND RADIUS.
  - PROVIDE REQUIRED FIRE RATED JUNCTION BOXES OR FIRE STOP BOX GUARDS AT ALL FIRE RATED WALLS.
  - CONDUIT AND ACCESSORIES MUST BE INSTALLED PLUMB AND TRUE WITH UNIFORM FASTENING, FULLY DRESSED AND FINISHED.

- RACEWAY
  - FOR ALL WORK OF THIS SECTION, RACEWAY ABOVE GROUND SHALL BE EMT, RACEWAY BELOW GROUND SHALL BE PVC.
  - RACEWAY SHALL BE ¾ INCH DIAMETER TRADE SIZE UNLESS OTHERWISE NOTED.
  - ALL CONDUIT RUNS OVER 100 FT. MUST HAVE LARGE RADIUS BENDS.
  - A MAXIMUM OF TWO 90 DEGREE ELBOWS IN EACH CONDUIT RUN.
  - CONDUIT WITH FIBER OPTIC CABLE INSTALLED, MUST CONFORM TO THE MINIMUM BEND RADIUS AS SPECIFIED BY THE MANUFACTURER OF THE CABLE.
  - DIVISION 26 CONTRACTOR IS TO APPLY RADIUS BENDS WHERE NEEDED. FIBER BEND RADIUS SHALL BE A MINIMUM LONG-TERM LOW-STRESS RADIUS NOT LESS THAN 20 TIMES THE CABLE DIAMETER.
  - KEEP A MINIMUM OF 12" CLEAR BETWEEN ELECTRICAL CONDUIT AND LOW VOLTAGE CONDUIT.
  - PROVIDE FIRE RATED CONDUIT PENETRATION SEALS AT ALL FIRE RATED WALLS.
  - CONDUIT AND ACCESSORIES MUST BE INSTALLED PLUMB AND TRUE WITH UNIFORM FASTENING, FULLY DRESSED AND FINISHED.
- GROUNDING AND BONDING

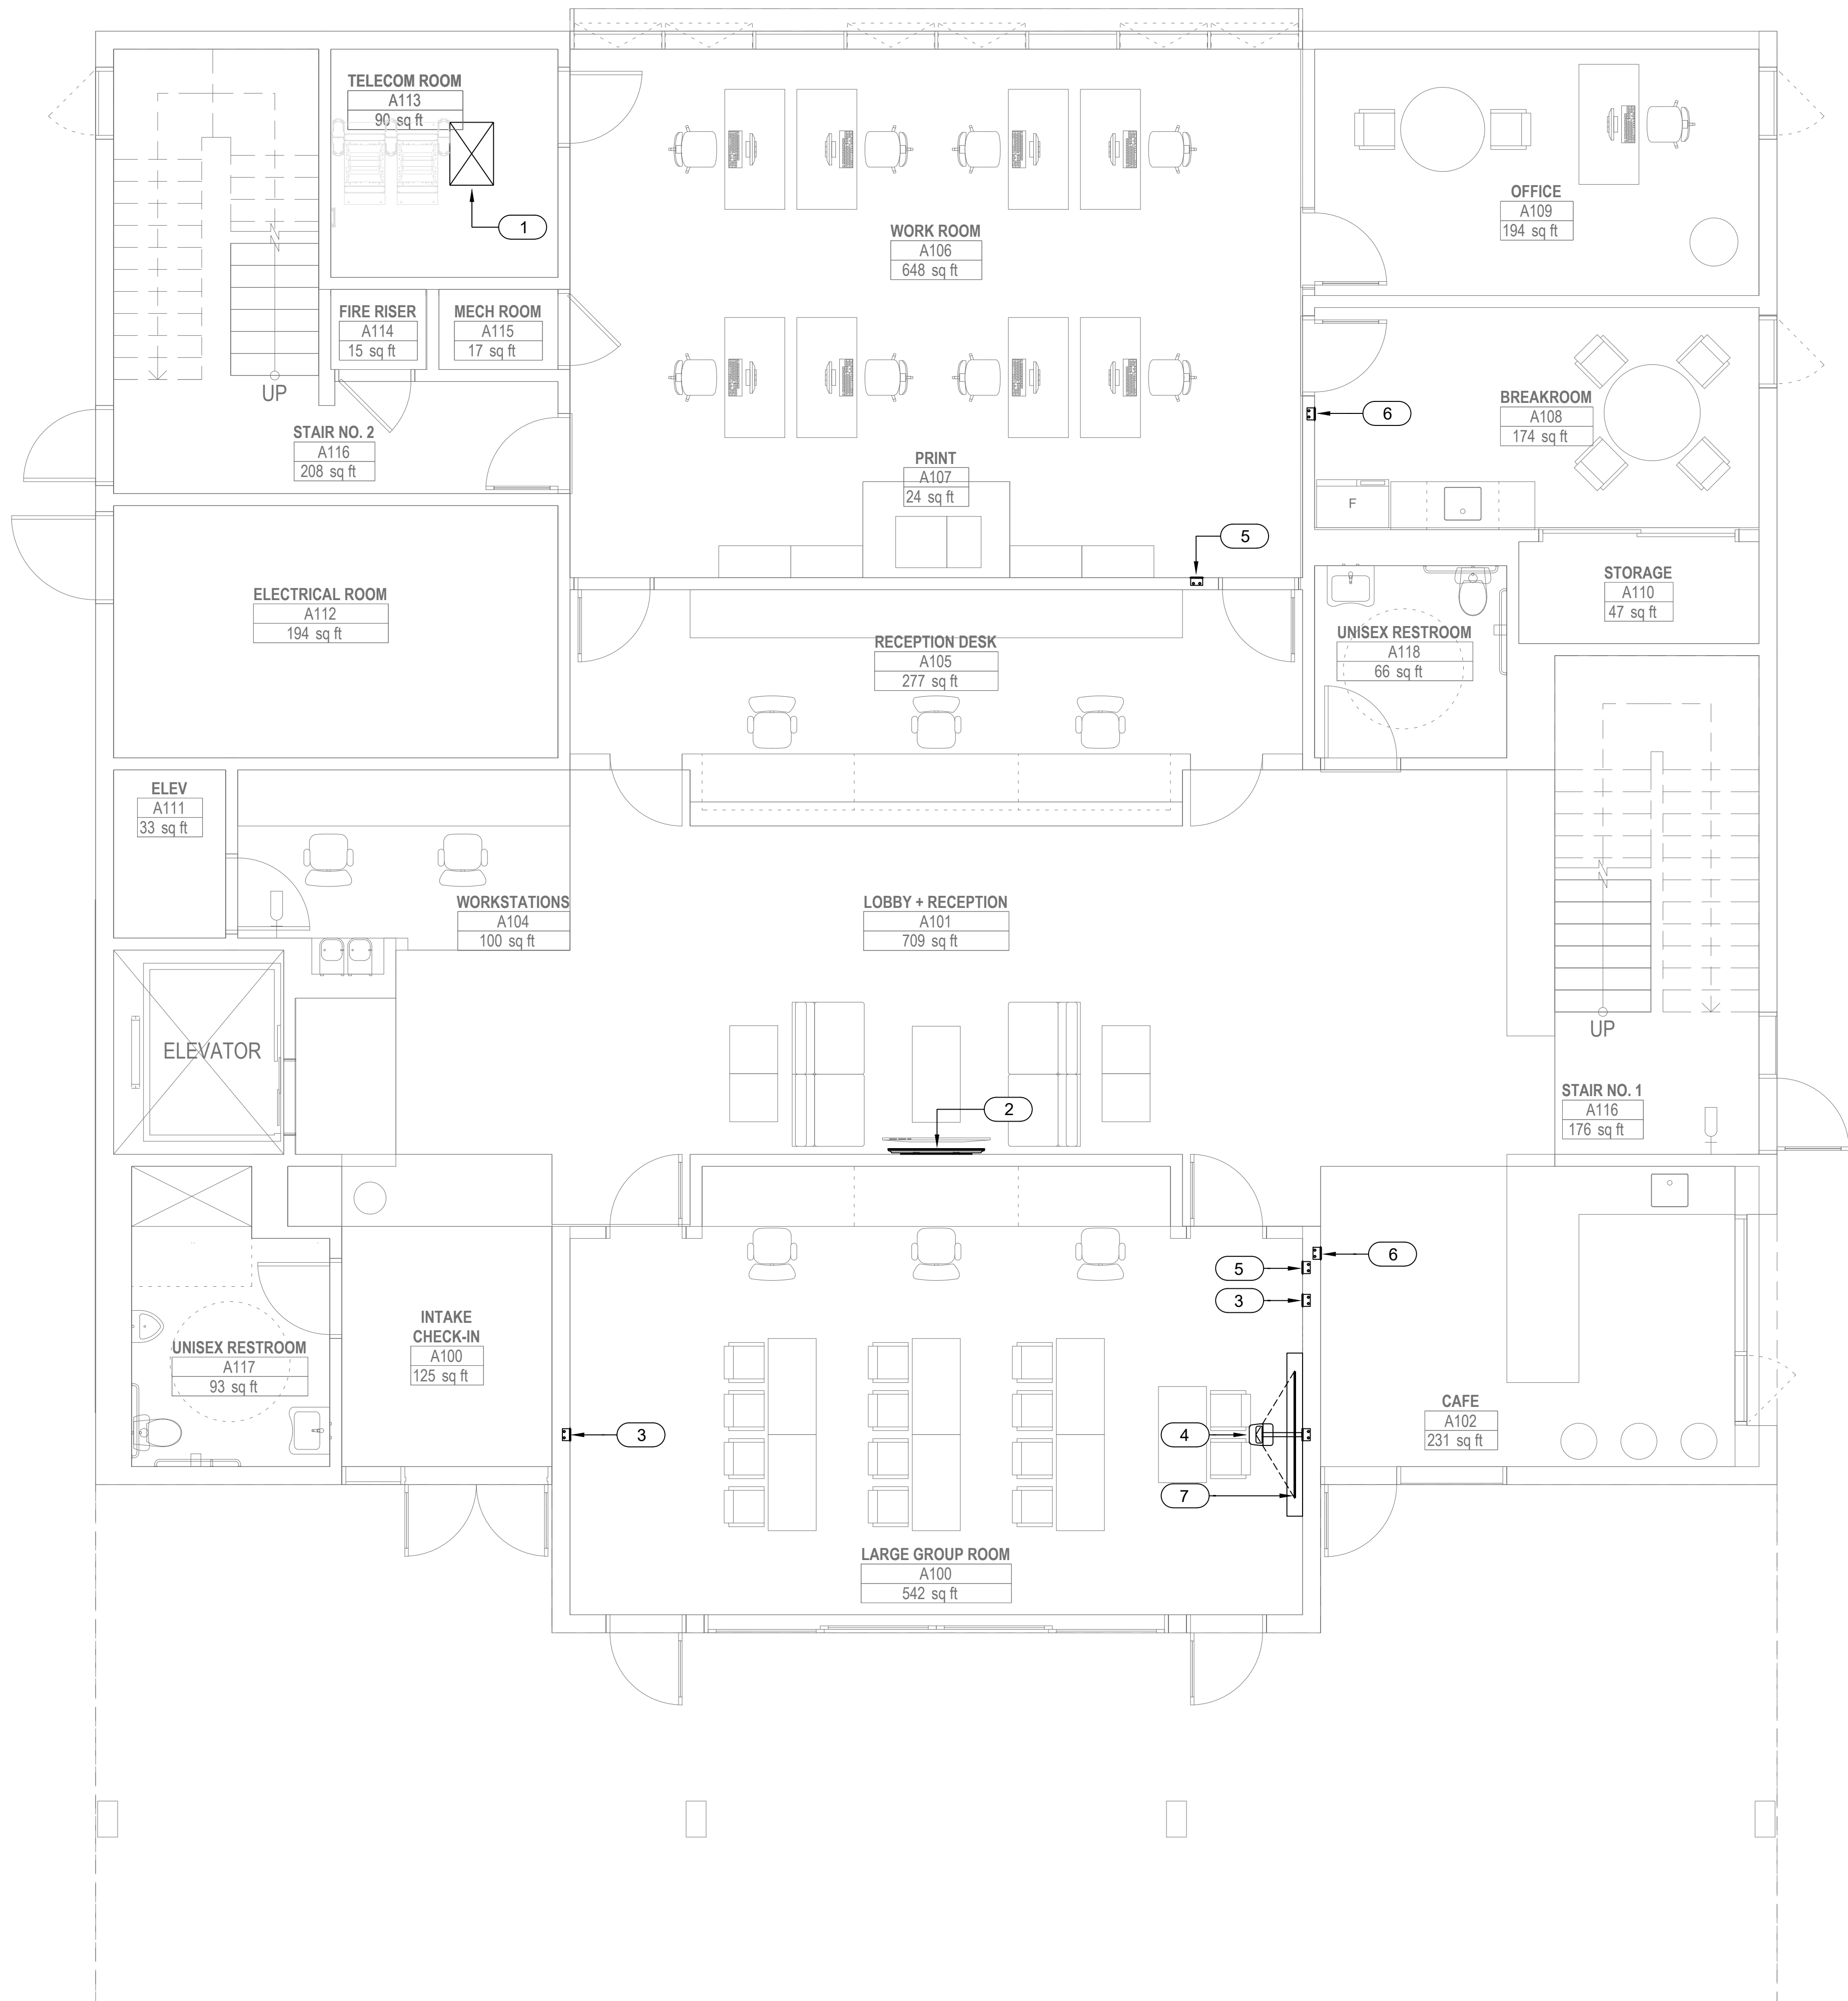
COMPLY WITH ALL APPLICABLE CODES AND ORDINANCES. REFER TO NATIONAL ELECTRICAL CODE SECTION 250.

  - BOND RACEWAY AND RELATED BOXES, PANELS, ENCLOSURES AND CABINETS AS REQUIRED BY APPLICABLE CODE AND DIVISION 26.
  - MAKE RACEWAY CONNECTIONS TO EQUIPMENT RACKS AND SIMILAR EQUIPMENT ENCLOSURES CONTAINING POWERED EQUIPMENT WITH ISOLATED FITTINGS.
  - GROUND AND BOND EQUIPMENT RACKS AND SIMILAR EQUIPMENT ENCLOSURES CONTAINING POWERED EQUIPMENT EXCLUSIVELY VIA THE ISOLATED EQUIPMENT GROUNDING CONDUCTORS PROVIDED UNDER DIVISION 26. SIZE SUCH CONDUCTORS ACCORDING TO APPLICABLE CODE. FOR EACH TECHNICAL BRANCH CIRCUIT, THE ISOLATED EQUIPMENT GROUNDING CONDUCTOR SHALL BE COPPER OF THE SAME GAUGE AS SUPPLY AND NEUTRAL CONDUCTORS. MAIN ISOLATED EQUIPMENT GROUNDING CONDUCTOR TO EACH ENSEMBLE OF EQUIPMENT RACKS SHALL BE COPPER, SIZED AS REQUIRED BY APPLICABLE CODE.
  - D.C. RESISTANCE BETWEEN THE ISOLATED EQUIPMENT GROUNDING BUS AT EQUIPMENT ROOM TECHNICAL POWER PANELS AND THE MAIN PROJECT GROUND FIELD SHALL NOT EXCEED 0.15 OHMS.
  - FOR COMMUNITY ANTENNA TELEVISION AND MASTER ANTENNA TELEVISION SYSTEMS AND RELATED PROVISIONS, COMPLY WITH ARTICLE 800, NATIONAL ELECTRICAL CODE.
- CABLE AND WIRE
  - ALL LOW VOLTAGE CABLE AND WIRE BY AUDIO-VISUAL CONTRACTOR.
  - USE PLENUM RATED WIRE WHERE REQUIRED BY CODE.
  - CABLE SPLICING NOT ALLOWED IN ANY PULLBOXES.
- GENERAL
  - IN THE EVENT THAT THESE PLANS, NOTES OR DETAILS OR ANY PART OR PORTION THEREOF ARE USED BY ANY THIRD-PARTY WITHOUT THE EXPRESS AUTHORIZED PERMISSION OF VENEKLASEN ASSOCIATES, THE UNAUTHORIZED USER AND ANYONE BENEFITING THEREFROM, SHALL DEFEND, INDEMNIFY AND HOLD HARMLESS VENEKLASEN ASSOCIATES AND ITS AGENTS, PRINCIPALS, EMPLOYEES AND CONSULTANTS FROM AND AGAINST ANY AND ALL CLAIMS, INCLUDING ATTORNEYS' FEES ARISING OUT OF SAID UNAUTHORIZED USE.
  - FURTHERMORE, THE UNAUTHORIZED USE OF THESE PLANS, NOTES, DETAILS OR ANY PART OR PORTION THEREFORE IS EXPRESSLY PROHIBITED AND VENEKLASEN ASSOCIATES RETAINS A COPYRIGHT OVER ANY AND ALL DOCUMENTS PREPARED BY VENEKLASEN ASSOCIATES.
  - IN THE EVENT THAT THE INSTALLER DEVIATES FROM THE PLANS AND SPECIFICATIONS PREPARED BY VENEKLASEN ASSOCIATES WHICH RESULTS IN DAMAGE TO PERSONS OR PROPERTY OF ANY KIND, INSTALLER HEREBY AGREES TO DEFEND, INDEMNIFY AND HOLD HARMLESS VENEKLASEN ASSOCIATES, ITS AGENTS, PRINCIPALS, EMPLOYEES AND CONSULTANTS FROM AND AGAINST ANY AND ALL CLAIMS, INCLUDING ATTORNEYS' FEES CAUSED BY SUCH FAILURE TO FOLLOW THE PLANS AND SPECIFICATIONS PREPARED BY VENEKLASEN ASSOCIATES, EXCEPTING ONLY THE DAMAGES TO PERSONS OR PROPERTY WHICH ARE CAUSED BY THE SOLE NEGLIGENCE OR WILLFUL MISCONDUCT OF VENEKLASEN ASSOCIATES.
  - DRAWINGS ARE DIAGRAMMATIC AND ARE INTENDED TO CONVEY SCOPE OF WORK AND TO INDICATE GENERAL ARRANGEMENT. THERE ARE NOT INTENDED TO SHOW EVERY DETAIL INCLUDING OFFSET OR FITTING OR EVERY STRUCTURAL DIFFICULTY THAT MAY BE ENCOUNTERED DURING THE WORK. EXCEPT AS OTHERWISE INDICATED, LOCATIONS OF ITEMS ARE APPROXIMATE ONLY. EXACT LOCATIONS NECESSARY TO SECURE PROPER CONDITIONS AND RESULTS MUST BE DETERMINED AT PROJECT SITE AND MUST BE APPROVED BY THE OWNER'S REPRESENTATIVE.
  - EXCEPT AS OTHERWISE INDICATED, MAKE REASONABLE MODIFICATIONS IN LAYOUT AS NEEDED TO PREVENT CONFLICT WITH OTHER WORK OR PROPER EXECUTION OF WORK.
  - INCLUDE WORK NOT USUALLY SHOWN OR SPECIFIED, BUT NECESSARY FOR PROPER INSTALLATION AND OPERATION OF A SYSTEM OR PIECE OF EQUIPMENT IN WORK.

SHEET INDEX

		100% PRELIMINARY DESIGN SUBMITTAL - 02/28/2024
Sheet Index		
Sheet Number	Sheet Title	
AV001	AV GENERAL NOTES AND SHEET INDEX	X
AV101EQ	AV FIRST FLOOR EQUIPMENT PLAN	X
AV102EQ	AV SECOND FLOOR EQUIPMENT PLAN	X
AV201EQ	AV FIRST FLOOR REFLECTED CEILING PLAN	X
AV202EQ	AV SECOND FLOOR REFLECTED CEILING PLAN	X





- NOTES:
- 1 AV EQUIPMENT RACK
  - 2 55" VIDEO DISPLAY
  - 3 AV PANEL  
\*LAPTOP CONNECTIVITY (HDMI INPUT)
  - 4 SHORT THROW VIDEO PROJECTOR
  - 5 AUDIO INPUT / VOLUME CONTROL  
/ SOURCE SELECT PANEL  
\*BACKGROUND MUSIC SELECT  
\*VOLUME UP, DOWN, MUTE  
\*AUDIO INPUT  
\*BLUETOOTH AUDIO
  - 6 VOLUME CONTROL / SOURCE SELECT PANEL  
\*BACKGROUND MUSIC SELECT  
\*VOLUME UP, DOWN, MUTE  
\*BLUETOOTH AUDIO
  - 7 PROJECTION SCREEN - 100" DIAGONAL

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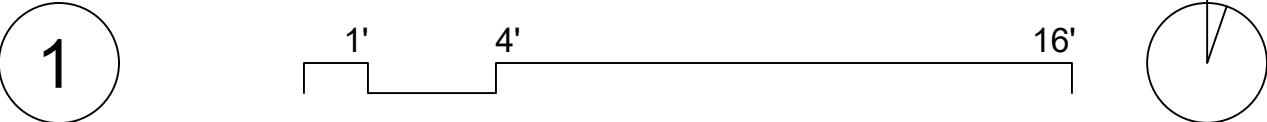
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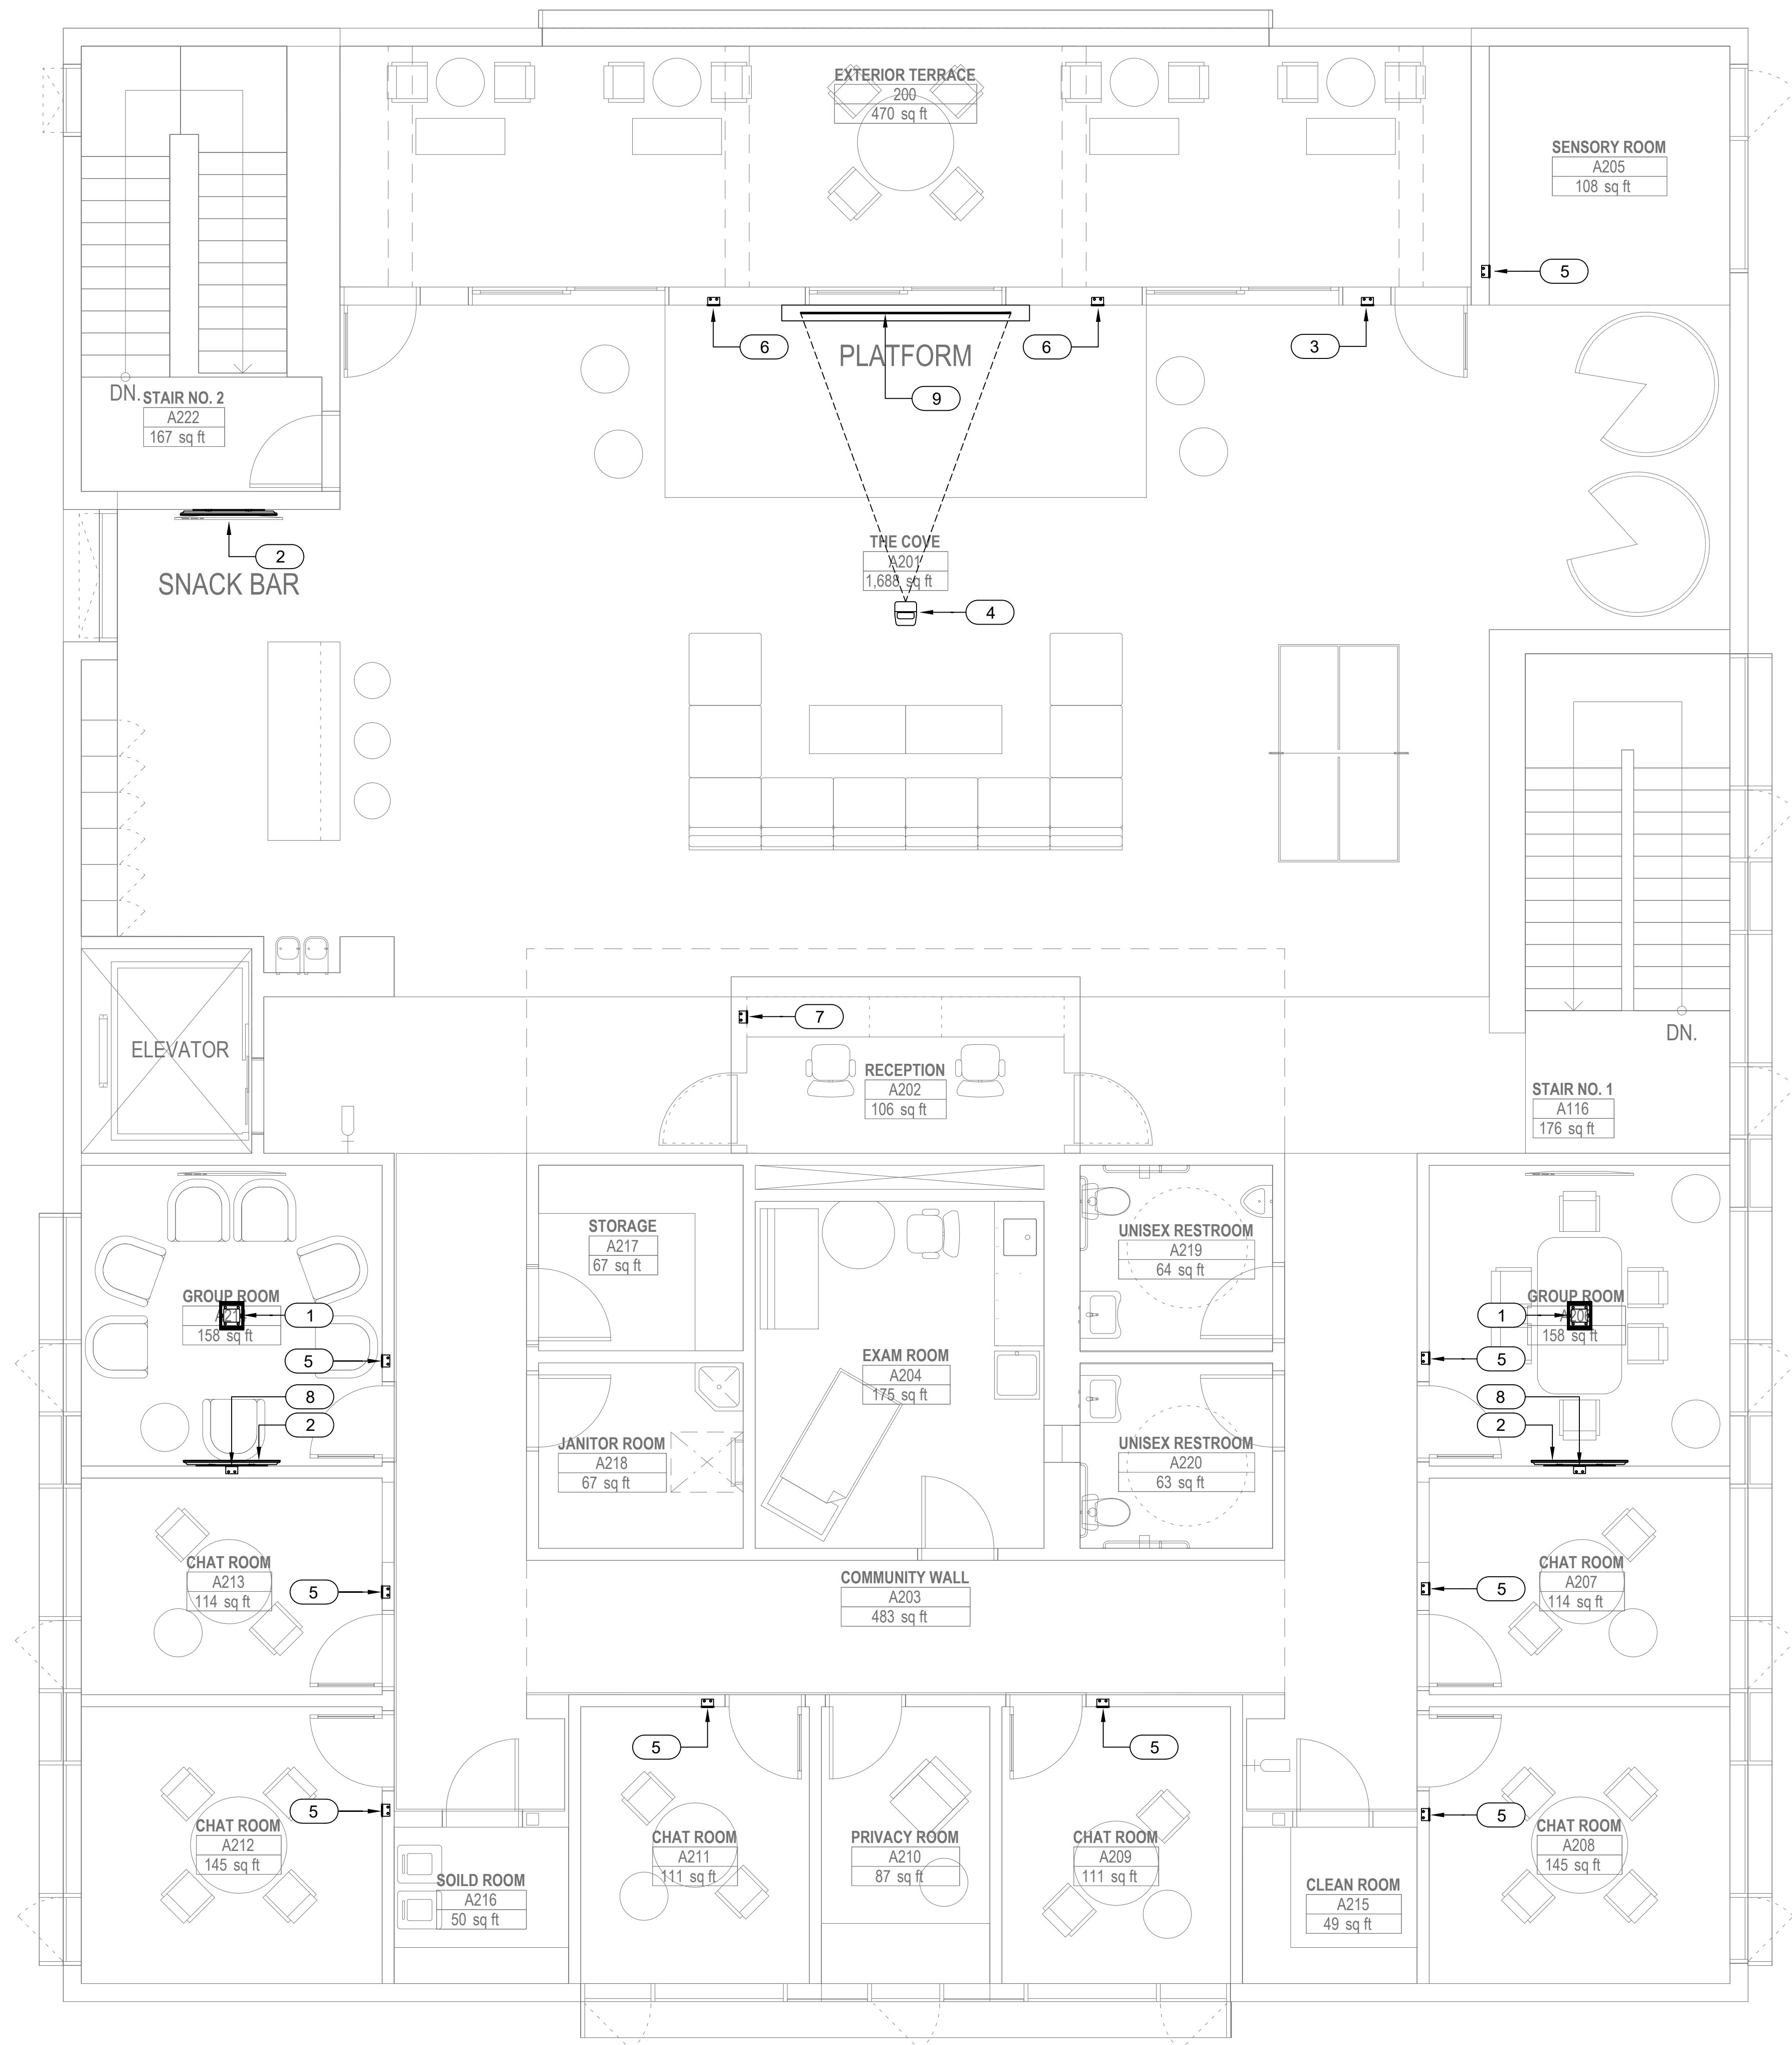
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<b>allcove</b> BEACH CITIES HEALTH DISTRICT		
<b>100% PRELIMINARY DESIGN SUBMITTAL</b>		
PMA PROJECT NO. 23007		
DRAWING TITLE AV FIRST FLOOR EQUIPMENT PLAN		
SCALE AS NOTED		
DATE 02/28/2024		
DRAWN JB		CHECKED PA
SHEET NO. AV101EQ		

AV FIRST FLOOR EQUIPMENT PLAN

SCALE: 1/4" = 1'-0"







- NOTES:
- 1 AV FLOOR BOX  
\*HDMI INPUT
  - 2 55" VIDEO DISPLAY
  - 3 TOUCH PANEL (AV CONTROL)
  - 4 VIDEO PROJECTOR
  - 5 AUDIO INPUT / VOLUME CONTROL  
/ SOURCE SELECT PANEL  
\*BACKGROUND MUSIC SELECT  
\*VOLUME UP, DOWN, MUTE  
\*AUDIO INPUT  
\*BLUETOOTH AUDIO
  - 6 AV PANEL 1  
\*(2) MIC/LINE INPUTS  
\*(1) AUDIO TIE LINES  
\*(1) VIDEO (HDBASE-T)  
\*(1) CAT6 TIE
  - 7 AV PANEL 2  
\*(1) MIC/LINE INPUTS  
\*(1) AUDIO TIE LINES  
\*(1) AV CONTROL CONNECTIVITY  
\*(1) CAT6 TIE
  - 8 FACILITY PANEL  
\*HDMI INPUT
  - 9 PROJECTION SCREEN - 120" DIAGONAL

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PMA PROJECT NO.  
23007

DRAWING TITLE  
AV SECOND FLOOR  
EQUIPMENT PLAN

SCALE  
AS NOTED

DATE  
02/28/2024

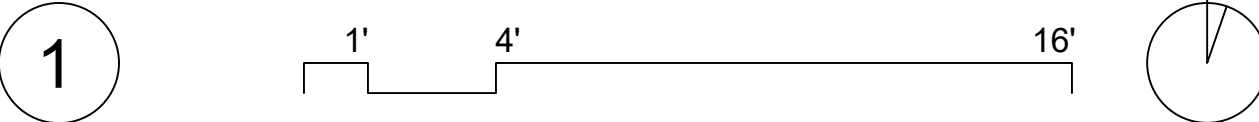
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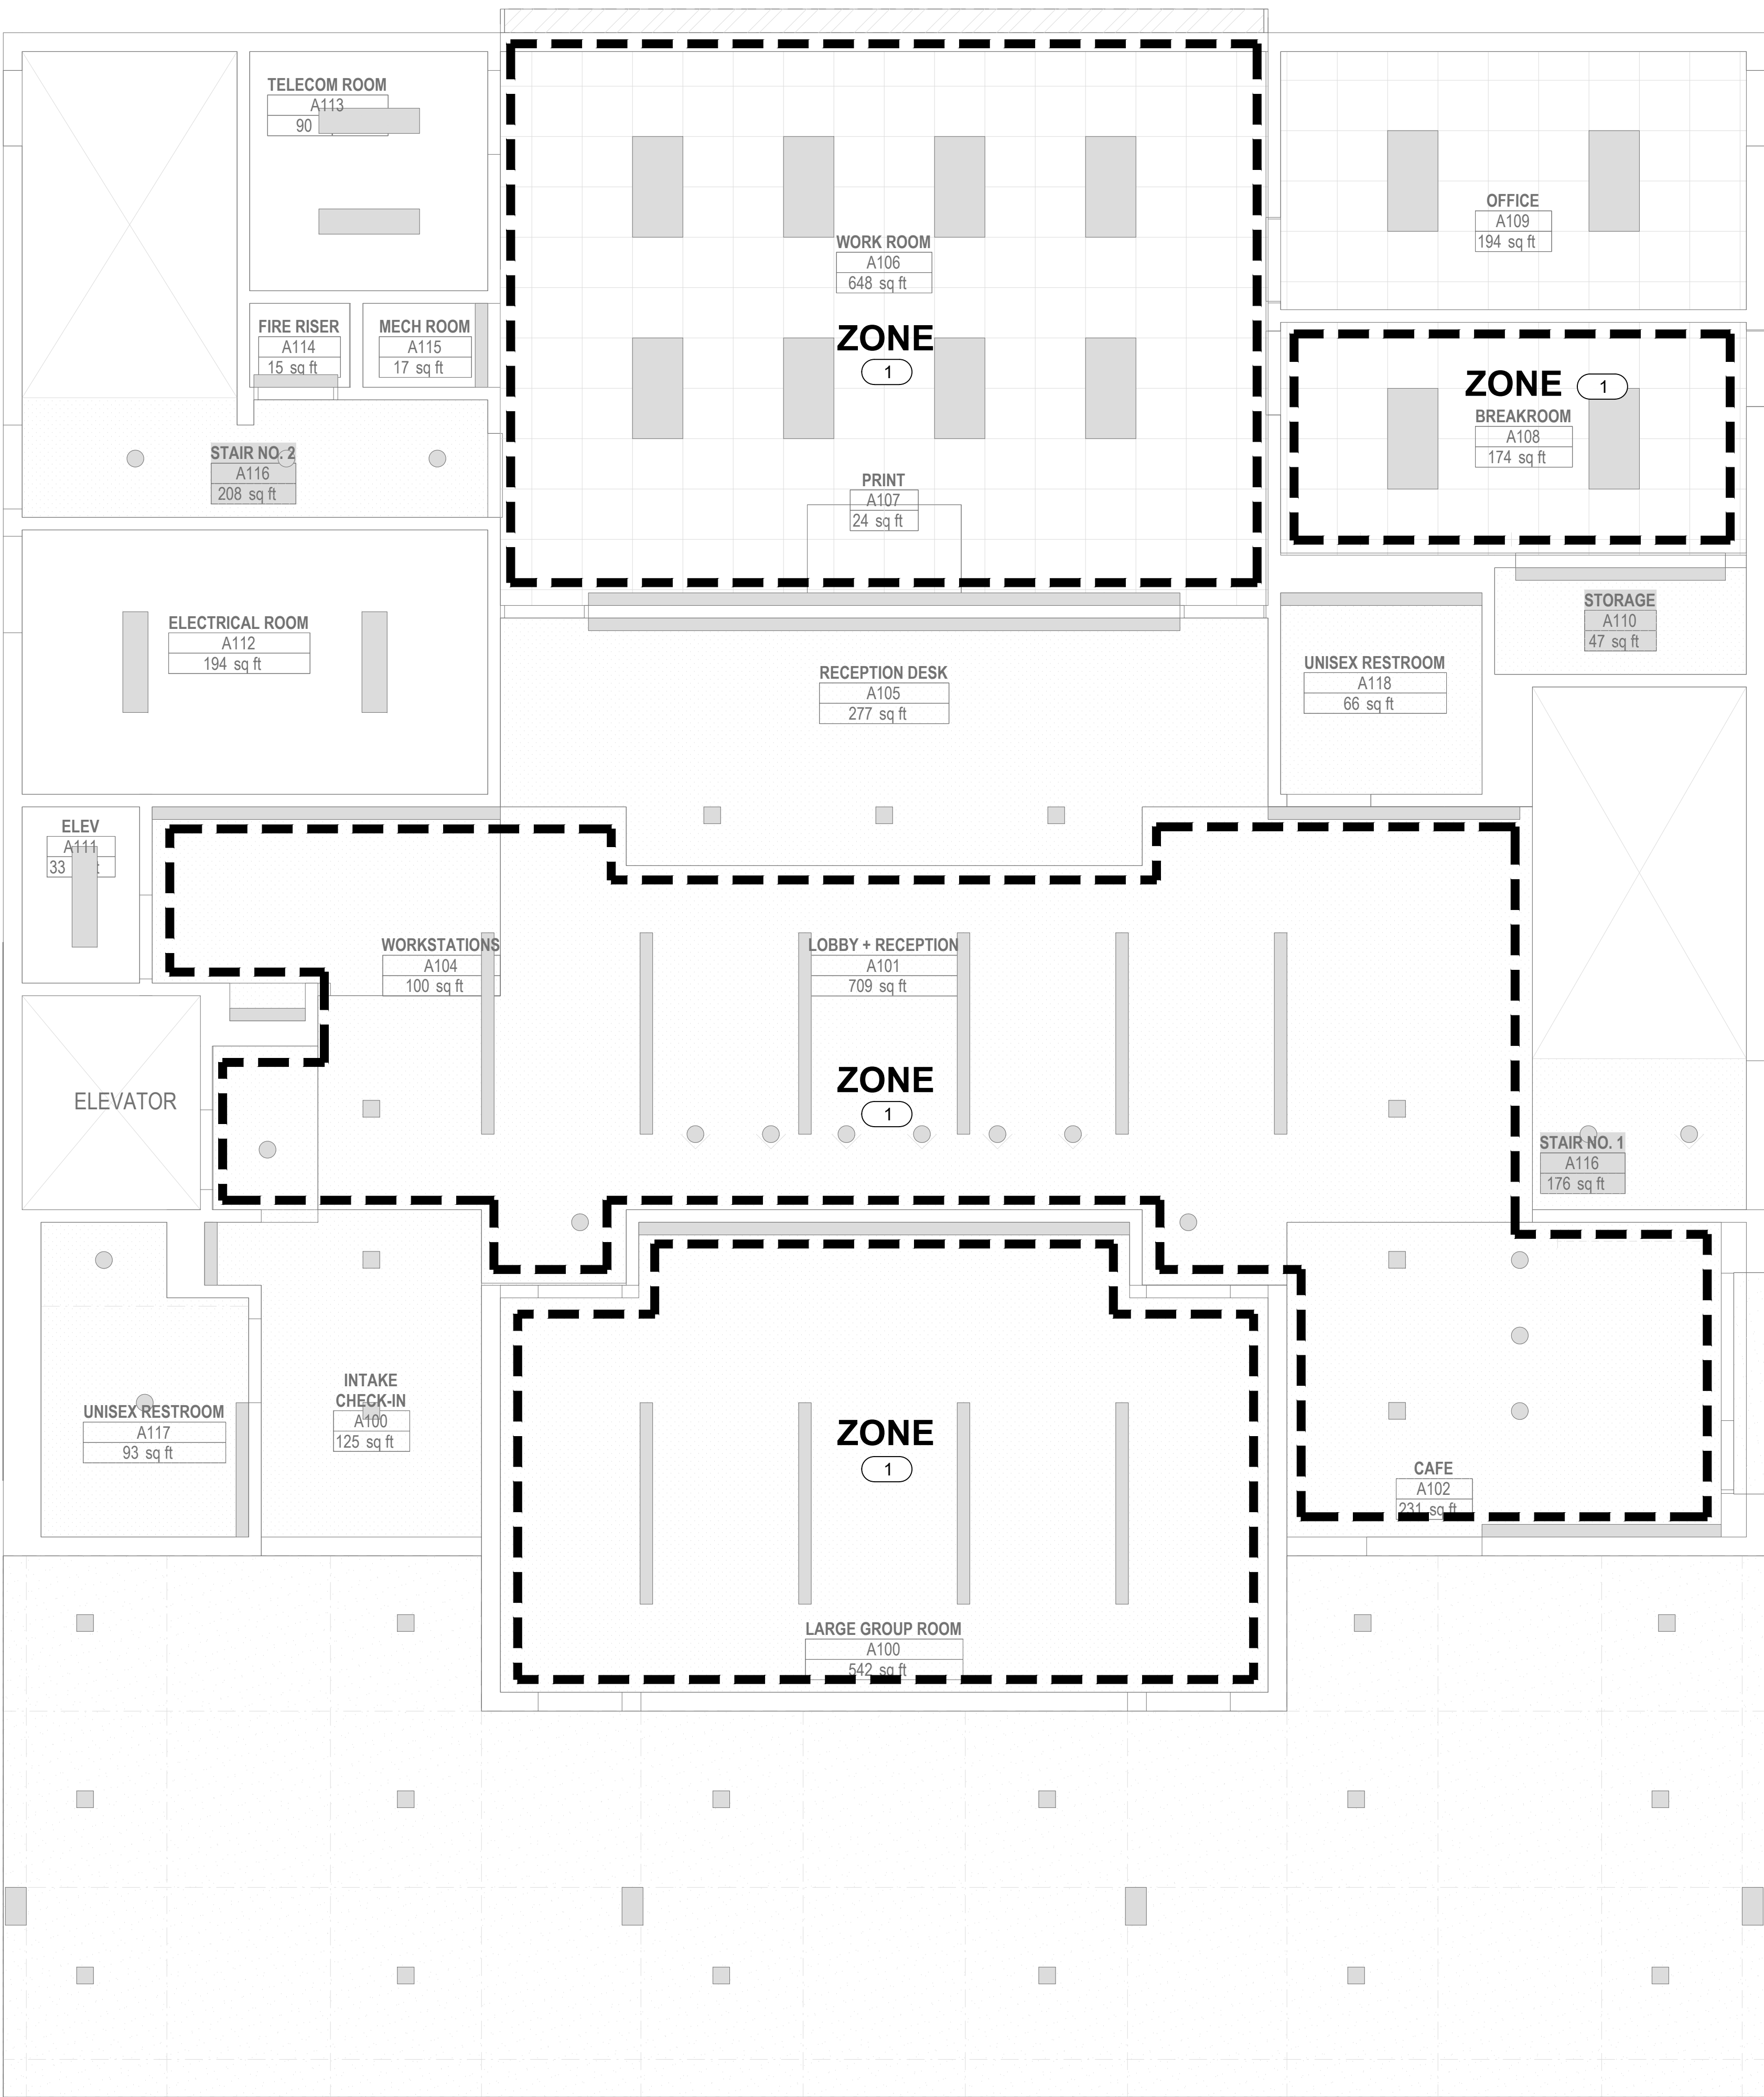
SHEET NO.  
AV102EQ

AV SECOND FLOOR EQUIPMENT PLAN

SCALE: 1/4" = 1'-0"







NOTES:


1 SPEAKER ZONE



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BEACH CITIES  
HEALTH DISTRICT

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PMA PROJECT NO.  
23007

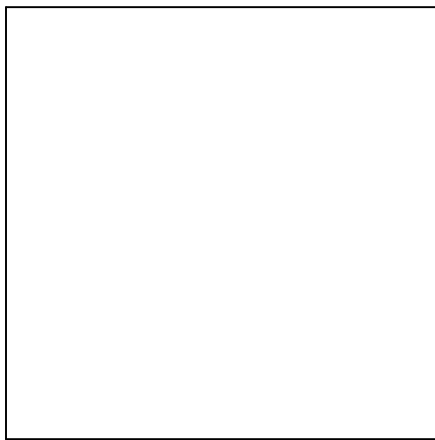DRAWING TITLE  
**AV FIRST FLOOR  
REFLECTED  
CEILING PLAN**

SCALE  
AS NOTED

DATE  
02/28/2024

DRAWN  
JB

CHECKED  
PA


SHEET NO.  
**AV201EQ**

AV FIRST FLOOR REFLECTED CEILING PLAN

SCALE: 1/4" = 1'-0"

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1' 4' 16'



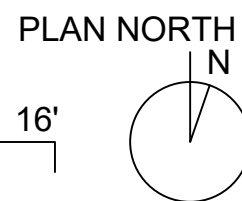

NOTES:

1 SPEAKER ZONE



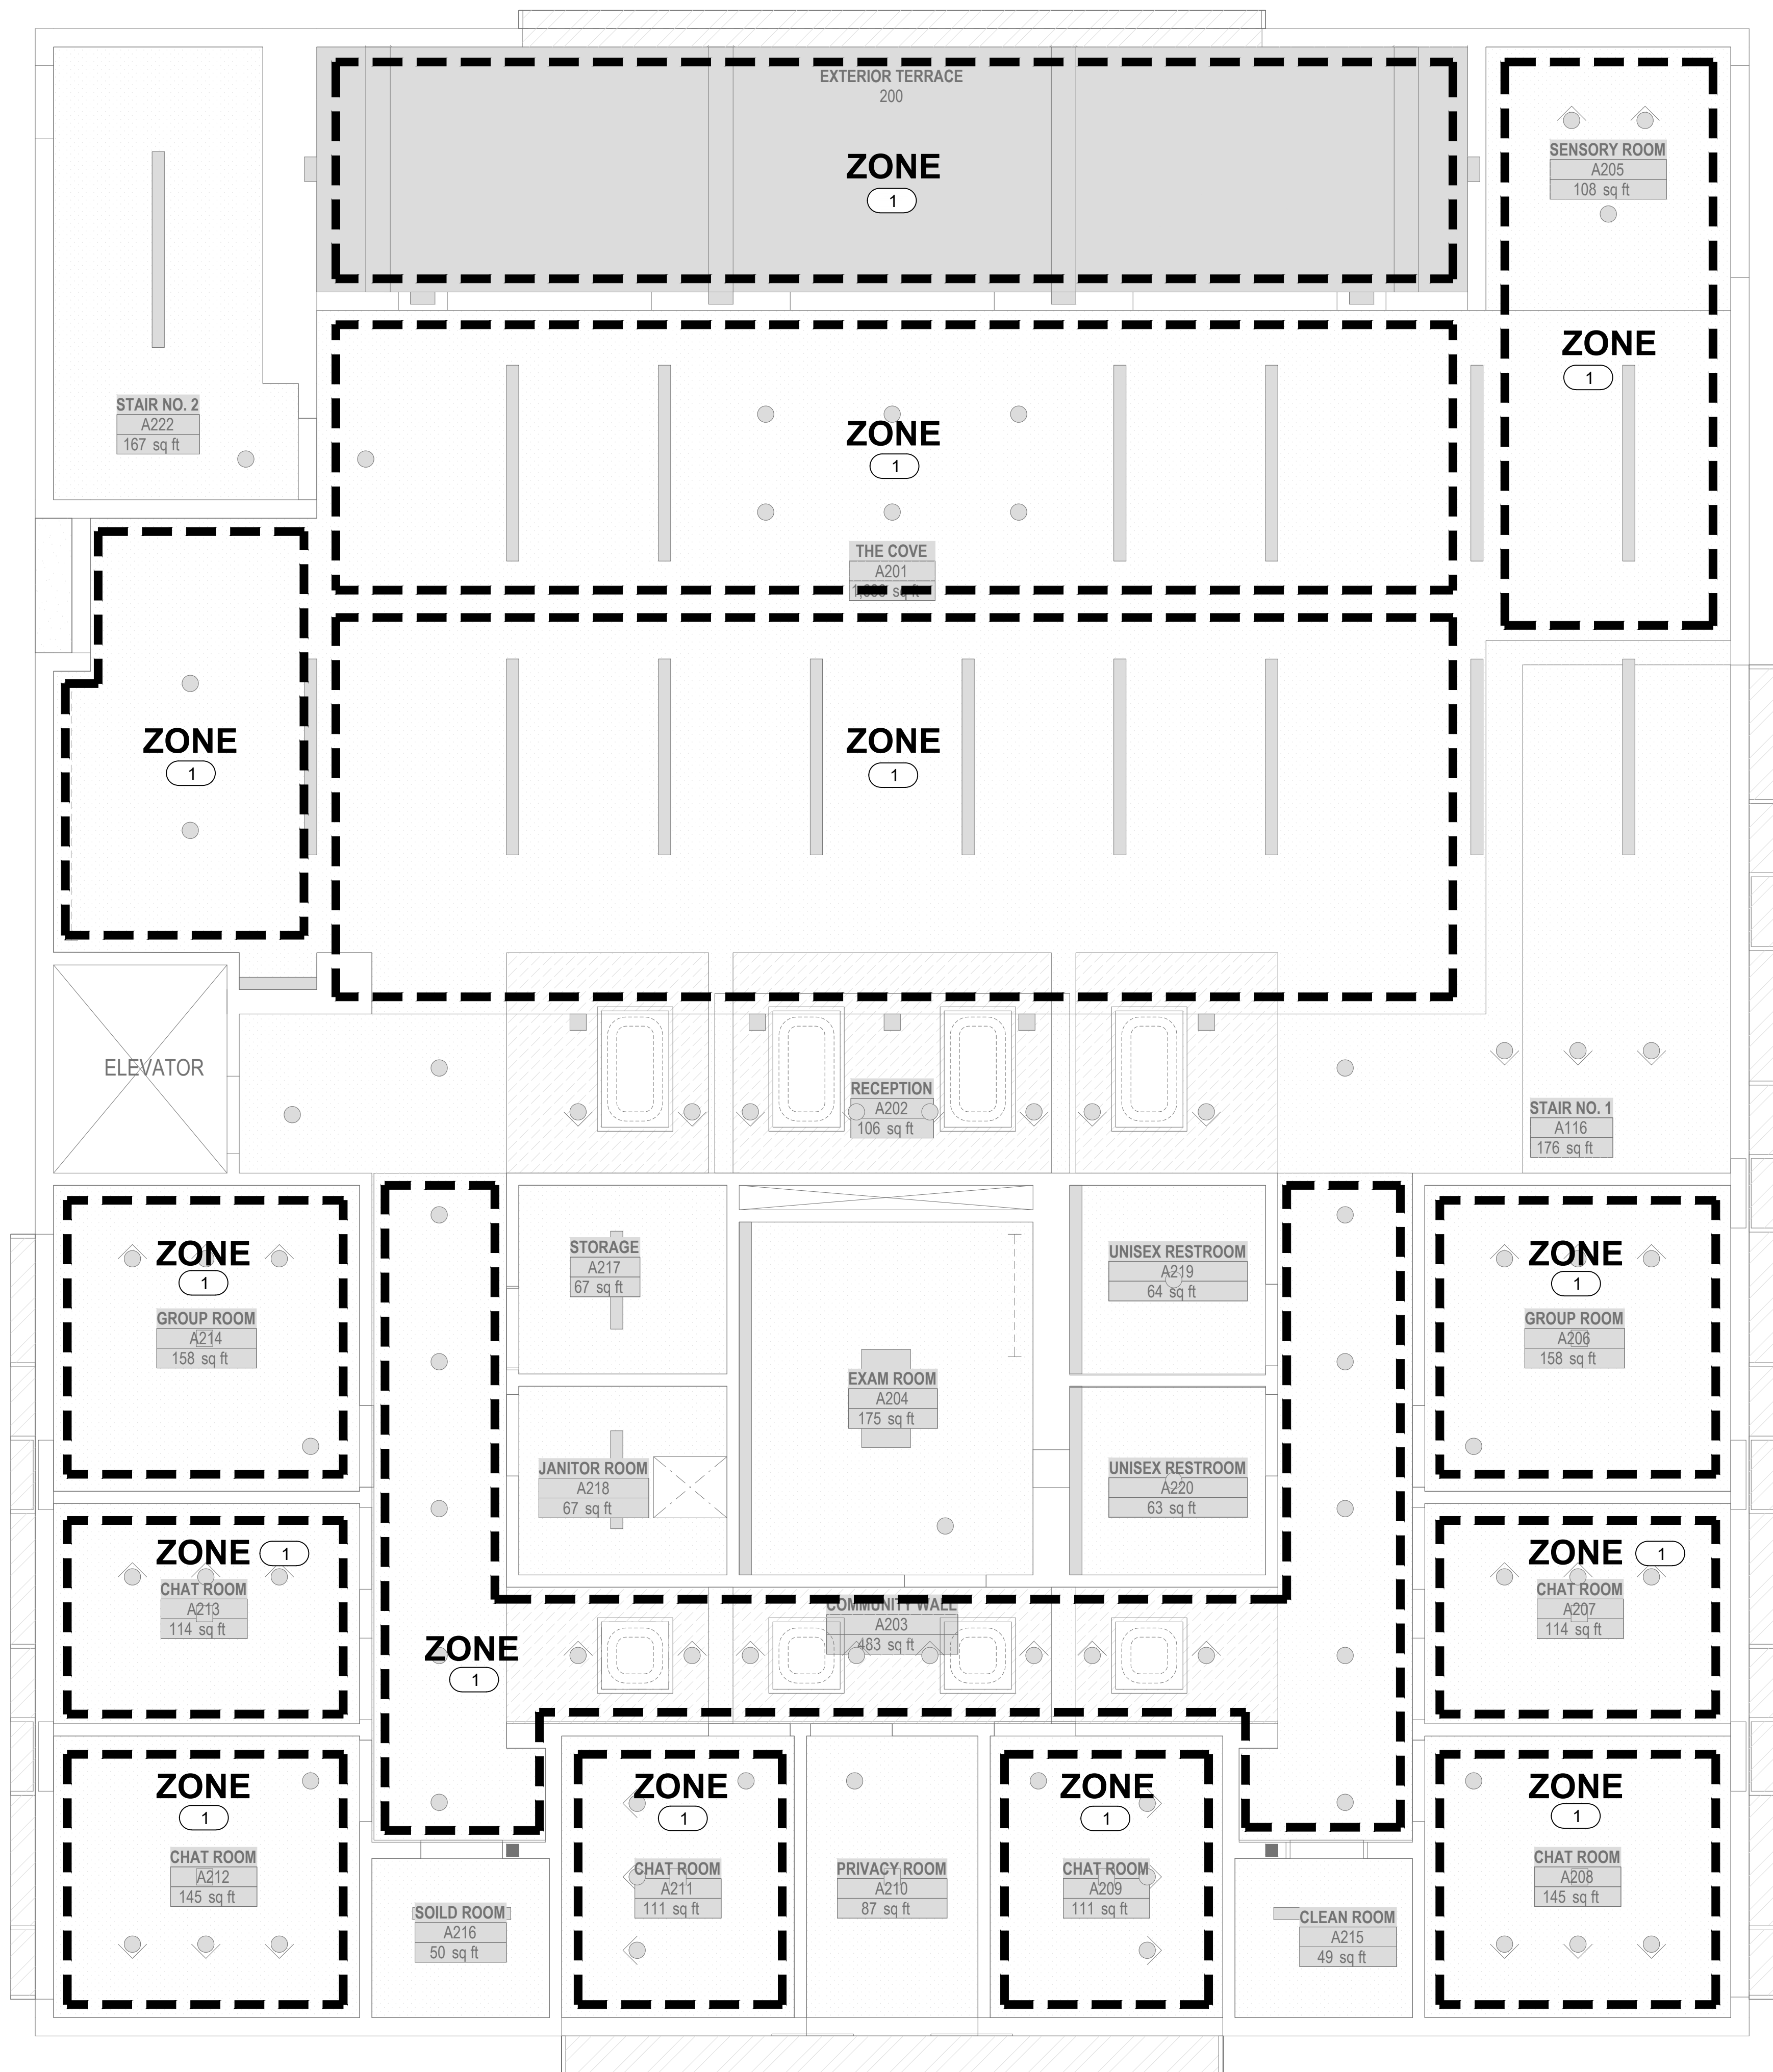
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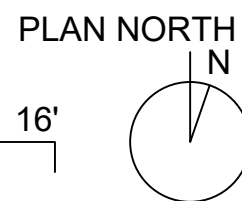


AV SECOND FLOOR REFLECTED CEILING PLAN

SCALE: 1/4" = 1'-0"

1

1' 4' 16'



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SHEET NO.

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BEACH CITIES HEALTH DISTRICT  
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REDONDO BEACH, CA

GENERAL NOTES

REFER TO SPECIFICATIONS FOR COMPLETE REQUIREMENTS.

1. **SECURITY**
- A. SECURITY SYSTEM CONSISTS OF BUT ARE NOT LIMITED TO:
- B. PROVIDE ALL LABOR, MATERIALS, TRANSPORTATION AND EQUIPMENT TO COMPLETE THE FURNISHING, INSTALLATION, ASSEMBLY, SET UP, AND TESTING OF THE SECURITY SYSTEM WORK INDICATED ON THE REQUEST FOR PROPOSAL (RFP) AND SPECIFIED HEREIN. NOT WITHSTANDING ANY DETAILED INFORMATION IN THIS SECTION, PROVIDE COMPLETE, WORKING SYSTEMS. GENERAL SCOPE OF WORK FOR THIS PROJECT IS OUTLINED ON THE RFP AND DESCRIBED IN THE SPECIFICATION.
- C. ALL COMPONENTS SHALL BE PROVIDED / INSTALLED BY CONTRACTOR PER DRAWINGS. PROGRAMMING CONTRACTOR IS RESPONSIBLE FOR ALL NECESSARY COMPONENTS, CABLE, HARDWARE, ETC. TO FURNISH COMPLETE AND OPERATIONAL SYSTEM.
- D. CONTRACTOR IS RESPONSIBLE FOR PROVIDING TRAINING TO OPERATOR PERSONNEL AS REQUIRED TO ENSURE PERSONNEL ARE FAMILIAR WITH OPERATING AND PROGRAMMING OF SECURITY SYSTEM.
- E. TRAINING SESSIONS TO BE COORDINATED WITH OWNER / OPERATOR PRIOR TO COMPLETION OF SYSTEM INSTALLATION.
- F. ALL CONDUITS, JUNCTION BOXES, FLOOR BOXES, BACK BOXES, PULL STRING AND POWER OUTLETS BY DIVISION 26 CONTRACTOR AS REQUIRED

2. **ELECTRICAL AND MECHANICAL NOTES**

- A. ALL WORK SHALL BE IN ACCORDANCE WITH THE LATEST EDITION OF THE NATIONAL ELECTRICAL CODE AND ALL APPLICABLE LOCAL CODES. THE CONTRACTOR SHALL NOT INTERMIX ANY LINE VOLTAGE POWER WIRES (120VAC) WITH ANY LOW VOLTAGE SIGNAL OR CONTROL WIRES IN ANY CONDUIT.
- B. ALL NEW ELECTRICAL POWER SUPPLIED TO SECURITY EQUIPMENT OR DEVICES SHALL BE ON A AN EMERGENCY SYSTEM INCLUDING UPS WHERE AVAILABLE. ALL CONDUCTORS AND CIRCUIT BREAKERS SHALL BE SIZED IN ACCORDANCE WITH THEIR CONNECTED LOADS (20 AMP MINIMUM). ALL CIRCUITS SHALL BE DEDICATED. A GROUND CONDUCTOR SHALL ALWAYS BE INSTALLED IN ANY POWER WIRING. ALL SECURITY EQUIPMENT UTILIZING ELECTRICAL POWER SHALL ALSO BE ADEQUATELY GROUNDED.
- C. ESTIMATED HEAT LOADS ARE SHOWN FOR REFERENCE ONLY. THEY ARE INTENDED FOR INCORPORATION IN THE PROJECT AS PART OF THE MECHANICAL DESIGN.
- D. ALL IDF, MDF, AND AV ROOMS TO MAINTAIN 70°F (MAX) AND 50% RH (RELATIVE HUMIDITY)

3. **COORDINATE**

- A. COORDINATE WITH THE WORK OF ALL SECTIONS. COORDINATE THE LOCATION OF BLOCKING AND BACKING REQUIRED BY THIS SECTION. MAKE REASONABLE MINOR ADJUSTMENTS TO PRESERVE ARCHITECTURAL SYMMETRY AND ALIGNMENT WITH ADJACENT FEATURES AT NO CLAIM FOR ADDITIONAL COST OR TIME. PRESENT CONFLICTS IN TIMELY MANNER FOR RESOLUTION.
- B. RELOCATION, REVISION OR CORRECTION CAUSED BY FAILURE OF THE CONTRACTOR TO COORDINATE THE WORK SHALL NOT BE SUBJECT TO CLAIM FOR ADDITIONAL COST OR TIME.
- C. POWER RECEPTACLES SHOWN ON THE SECURITY DRAWINGS OUTSIDE OF EQUIPMENT RACKS ARE SHOWN FOR COORDINATION INFORMATION ONLY. REFER TO DIVISION 26 DOCUMENTS FOR CONSTRUCTION.
- D. THESE DRAWINGS SHOW SCOPE. THE EXACT LOCATION & ELEVATIONS OF CEILING AND WALL MOUNTED SECURITY DEVICES MUST BE COORDINATED WITH THE ARCHITECTURAL DRAWINGS.
- E. CABLE TRAY, CONDUIT, DEVICE BOX, BACK BOXES AND PULL BOXES SUPPLIED AND INSTALLED BY ELECTRICAL CONTRACTOR UNDER SUPERVISION OF SECURITY CONTRACTOR.
- F. GENERAL CONTRACTOR SHALL COORDINATE THE CONDUIT, DEVICES, PATHWAYS, CONTROL PANELS, AND JUNCTION BOXES FOR THE SECURITY SYSTEM WITH OTHER TRADE TO AVOID ANY CONFLICTS. ALL BOX OPENINGS SHALL BE ACCESSIBLE.
- G. DOOR LOCKS AND HARDWARE ARE PROVIDED BY DIVISION 8. WITH CONNECTION TO THIS HARDWARE BY SECURITY CONTRACTOR (DIVISION 260500).

4. **LOCATIONS AND DIMENSIONS**

- A. LOCATIONS AND DIMENSIONS SHOWN ON ARCHITECTURAL DRAWINGS TAKE PRECEDENCE OVER THE SECURITY DRAWINGS. IN CASE OF APPARENT CONFLICT OR AMBIGUITY, SUBMIT TO THE ARCHITECT IN TIMELY MANNER FOR RESOLUTION.
- B. DIMENSIONS TAKE PRECEDENCE OVER SCALE. LARGE SCALE DRAWINGS TAKE PRECEDENCE OVER SMALL. REPORT ALL CONFLICTS BEFORE INSTALLATION.
- C. UNLESS OTHERWISE NOTED, DIMENSIONS ARE SHOWN HEIGHT X WIDTH X DEPTH.
- D. VERIFY ALL DIMENSIONS, LOCATIONS AND CONDITIONS IN THE FIELD PRIOR TO STARTING WORK. NOTIFY ARCHITECT OF ANY APPARENT DISCREPANCIES.

5. **PATHWAYS AND SUPPORT**
- A. PROVIDE ALL BLOCKING, BRIDGING, TIES, FASTENERS AND RELATED SUPPORT PROVISIONS FOR ALL WORK OF THIS SECTION. COMPLY WITH APPLICABLE CODE REQUIREMENTS FOR MEANS OF SUPPORT OF ELECTRICAL EQUIPMENT OF THE SAME WEIGHT UNDER THE SAME MOUNTING CONDITIONS. DO NOT APPLY ANY LOAD TO BUILDING STRUCTURE WITHOUT FIRST OBTAINING WRITTEN APPROVAL OF THE PROJECT STRUCTURAL ENGINEER. OBTAIN PER PROJECT PROCEDURES.
- B. ANY CABLING PATHWAYS SHOWN REPRESENT A POTENTIAL ROUTE AS DETERMINED AT THE TIME OF DESIGN AND MAY NOT NECESSARILY BE THE OPTIMAL PATHWAY. DEPENDING UPON THE ACTUAL FIELD CONDITIONS ALL CABLING PATHWAYS MUST BE FIELD VERIFIED. IT IS ULTIMATELY THE RESPONSIBILITY OF THE CONTRACTOR TO DETERMINE THE OPTIMAL CABLING PATHWAYS BASED UPON FIELD CONDITIONS, CODE COMPLIANCE AND COORDINATED WITH OTHER TRADES. IT IS IMPERATIVE THAT THE CONTRACTOR VERIFIES ALL CABLING PATHWAYS PRIOR TO SUBMITTING THEIR BID. THE OWNER WILL NOT BE RESPONSIBLE FOR TIME ASSOCIATED WITH FIELD VERIFICATION EFFORTS FOR DETERMINING MOST VIABLE CABLING PATHWAYS.
- C. PROVIDE SEPARATE PATHWAYS FOR EACH SECURITY SYSTEM (CCTV, ACCESS CONTROL, INTRUSION DETECTION, VIDEO INTERCOM).

6. **BOX, PANEL AND ENCLOSURE INSTALLATION**

- A. COORDINATE THE LOCATION OF ALL BOXES, PANELS, ENCLOSURES AND RELATED RACEWAY WITH THE WORK OF OTHER SECTIONS.
- B. VERIFY ACCESS TO BOXES, PANELS AND ENCLOSURES COMPLY WITH APPLICABLE CODE.
- C. INSTALL BOXES, PANELS AND ENCLOSURES SQUARE AND PLUMB. SET FLUSH MOUNTED UNITS SO THAT THE FACE OF THE COVER, BEZEL OR ESCUTCHEON, IS IN THE SAME PLANE AS THE ADJACENT FINISHED SURFACE. MOUNT BOXES, PANELS AND TRIM SO THAT THERE ARE NO GAPS, CRACKS OR OBVIOUS LINES BETWEEN THE TRIM AND THE ADJACENT FINISHED SURFACE. THIS APPLIES TO ALL HORIZONTAL AND VERTICAL SURFACES. PULLBOX LOCATED IN THE CEILING SPACE SHALL BE ACCESSIBLE. IN CASE A PULLBOX HAS TO BE LOCATED IN A DRY WALL OR INACCESSIBLE CEILING, THE CONTRACTOR SHALL COORDINATE WITH THE ARCHITECT THE INSTALL OF CEILING HATCH.
- D. UNLESS OTHERWISE NOTED, PROVIDE STEEL BOXES, PANELS AND ENCLOSURES. COMPLY WITH DIVISION 26 REQUIREMENTS AND APPLICABLE CODE.
- E. UNLESS OTHERWISE NOTED, BOXES AND ENCLOSURES SHALL BE NOT LESS THAN 2-1/8 INCHES DEEP. PROVIDE THE LARGER OF THE SIZE REQUIRED BY APPLICABLE CODE OR AS SHOWN ON DRAWINGS. COORDINATE WIRE AND CABLE BEND RADIUS WITH BOX AND ENCLOSURE SIZE.
- F. PULL BOXES: PROVIDE AS REQUIRED BY THE MOST RESTRICTIVE OF APPLICABLE CODE OR THE PROVISIONS OF DIVISION 16. COORDINATE WITH WIRE AND CABLE BEND RADIUS.
- G. PULLBOXES SHALL NOT BE USED IN LIEU OF CONDUIT BEND.

7. **RACEWAY**

- A. RACEWAY FOR ALL WORK IN THIS SECTION SHALL BE EMT.
- B. CCTV RACEWAY SHALL BE 1" DIAMETER TRADE SIZE UNLESS OTHERWISE NOTED. ACCESS CONTROL AND INTRUSION DETECTION RACEWAY SHALL BE 3/4" DIAMETER TRADE SIZE UNLESS OTHERWISE NOTED.
- C. CONDUIT WITH FIBER OPTIC CABLE INSTALLED, MUST CONFORM TO THE MINIMUM BEND RADIUS AS SPECIFIED BY THE MANUFACTURER OF THE CABLE. DIVISION 26 CONTRACTOR IS TO APPLY RADIUS BENDS WHERE NEEDED. FIBER BEND RADIUS SHALL BE A MINIMUM LONG-TERM LOW-STRESS RADIUS NOT LESS THAN 20 TIMES THE CABLE DIAMETER.
- D. KEEP A MINIMUM OF 12" CLEAR BETWEEN ELECTRICAL CONDUIT AND LOW VOLTAGE CONDUIT.
- E. PVC CONDUITS ARE NOT ACCEPTABLE FOR SECURITY SYSTEM INSTALLATION

8. **GROUNDDING AND BONDING**

- COMPLY WITH ALL APPLICABLE CODES AND ORDINANCES. REFER TO 2019 CALIFORNIA BUILDING CODE, 2019 CALIFORNIA ELECTRICAL CODE.
- A. BOND RACEWAY AND RELATED BOXES, PANELS, ENCLOSURES AND CABINETS AS REQUIRED BY APPLICABLE CODE AND DIVISION 26.
- B. MAKE RACEWAY CONNECTIONS TO EQUIPMENT RACKS AND SIMILAR EQUIPMENT ENCLOSURES CONTAINING POWERED EQUIPMENT WITH ISOLATED FITTING.
- C. GROUND AND BOND EQUIPMENT RACKS AND SIMILAR EQUIPMENT ENCLOSURES CONTAINING POWERED EQUIPMENT EXCLUSIVELY VIA THE ISOLATED EQUIPMENT GROUNDING CONDUCTORS PROVIDED UNDER DIVISION 16. SIZE SUCH CONDUCTORS ACCORDING TO APPLICABLE CODE.
- D. D.C. RESISTANCE BETWEEN THE ISOLATED EQUIPMENT GROUNDING BUS AT EQUIPMENT ROOM TECHNICAL POWER PANELS AND THE MAIN PROJECT GROUND FIELD SHALL NOT EXCEED 0.15 OHMS.

9. **CABLE AND WIRE**

- A. USE PLENUM RATED WIRE WHERE REQUIRED BY CODE.
- B. ALL WIRE DISTRIBUTION TO EQUIPMENT RACK TO BE PLENUM RATED AS NEEDED.
- C. CABLE SPLICING NOT ALLOWED IN ANY PULLBOXES.

GENERAL CONTRACTOR - RESPONSIBILITY MATRIX

ELECTRICAL CONTRACTOR TO PROVIDE:	CABLING CONTRACTOR TO PROVIDE:	SECURITY CONTRACTOR TO PROVIDE:
<ul style="list-style-type: none"><li>• BACK BOXES</li><li>• SINGLE GANG MUD RING</li><li>• CONDUITS</li><li>• SLEEVES</li><li>• FIRESTOPPING</li><li>• PULL STRING</li><li>• KNOX BOX</li><li>• MISC. PANELS, MOUNTING HARDWARE, LADDER RACK, ETC. AND ANY OTHER RELATED COMPONENT TO DELIVER A COMPLETE SYSTEM TO THE CLIENT.</li></ul>	<ul style="list-style-type: none"><li>• CAT 6A CABLES</li><li>• CAT 6A JACKS</li><li>• CAT6A FIELD TERMINATED PLUG</li><li>• COAX CABLES</li><li>• FACE PLATE</li><li>• PATCH PANEL</li><li>• WALL MOUNT RACK</li><li>• WIRE MANAGER</li><li>• COMPRESSION CONNECTOR</li><li>• J-HOOKS</li><li>• MISC. PANELS, CABLE MOUNTING HARDWARE, JACKS, ETC. AND ANY OTHER RELATED COMPONENT TO DELIVER A COMPLETE SYSTEM TO THE CLIENT.</li></ul>	<ul style="list-style-type: none"><li>• INTRUSION DETECTION EQUIPMENT AND DEVICES</li><li>• ACCESS CONTROL EQUIPMENT AND DEVICES</li><li>• DOOR CONTACTS</li><li>• SECURITY SYSTEM</li><li>• ALL CABLES FOR SECURITY SYSTEM</li><li>• CCTV CAMERAS</li><li>• CCTV CAMERA MOUNTS</li><li>• SECURITY PSE SWITCH</li><li>• TAMPER SWITCH</li><li>• MISC. PANELS, CABLE MOUNTING HARDWARE, SOFTWARE, JACKS, LADDER RACK, ETC. AND ANY OTHER RELATED COMPONENT TO DELIVER A COMPLETE SYSTEM TO THE CLIENT.</li></ul>

SHEET INDEX

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SC002	SECURITY ABBREVIATIONS NOTES AND SYMBOLS	X
SC100	SECURITY SITE PLAN	X
SC111	SECURITY FIRST FLOOR PLAN	X
SC112	SECURITY SECOND FLOOR PLAN	X
SC401	SECURITY RISER DIAGRAM	X
SC601	SECURITY DETAILS	X
SC602	SECURITY DETAILS	X


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DRAWING TITLE

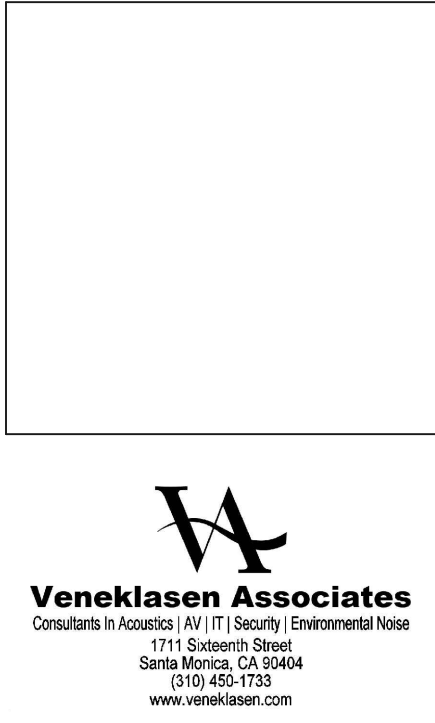SECURITY GENERAL  
NOTES AND SHEET  
INDEX

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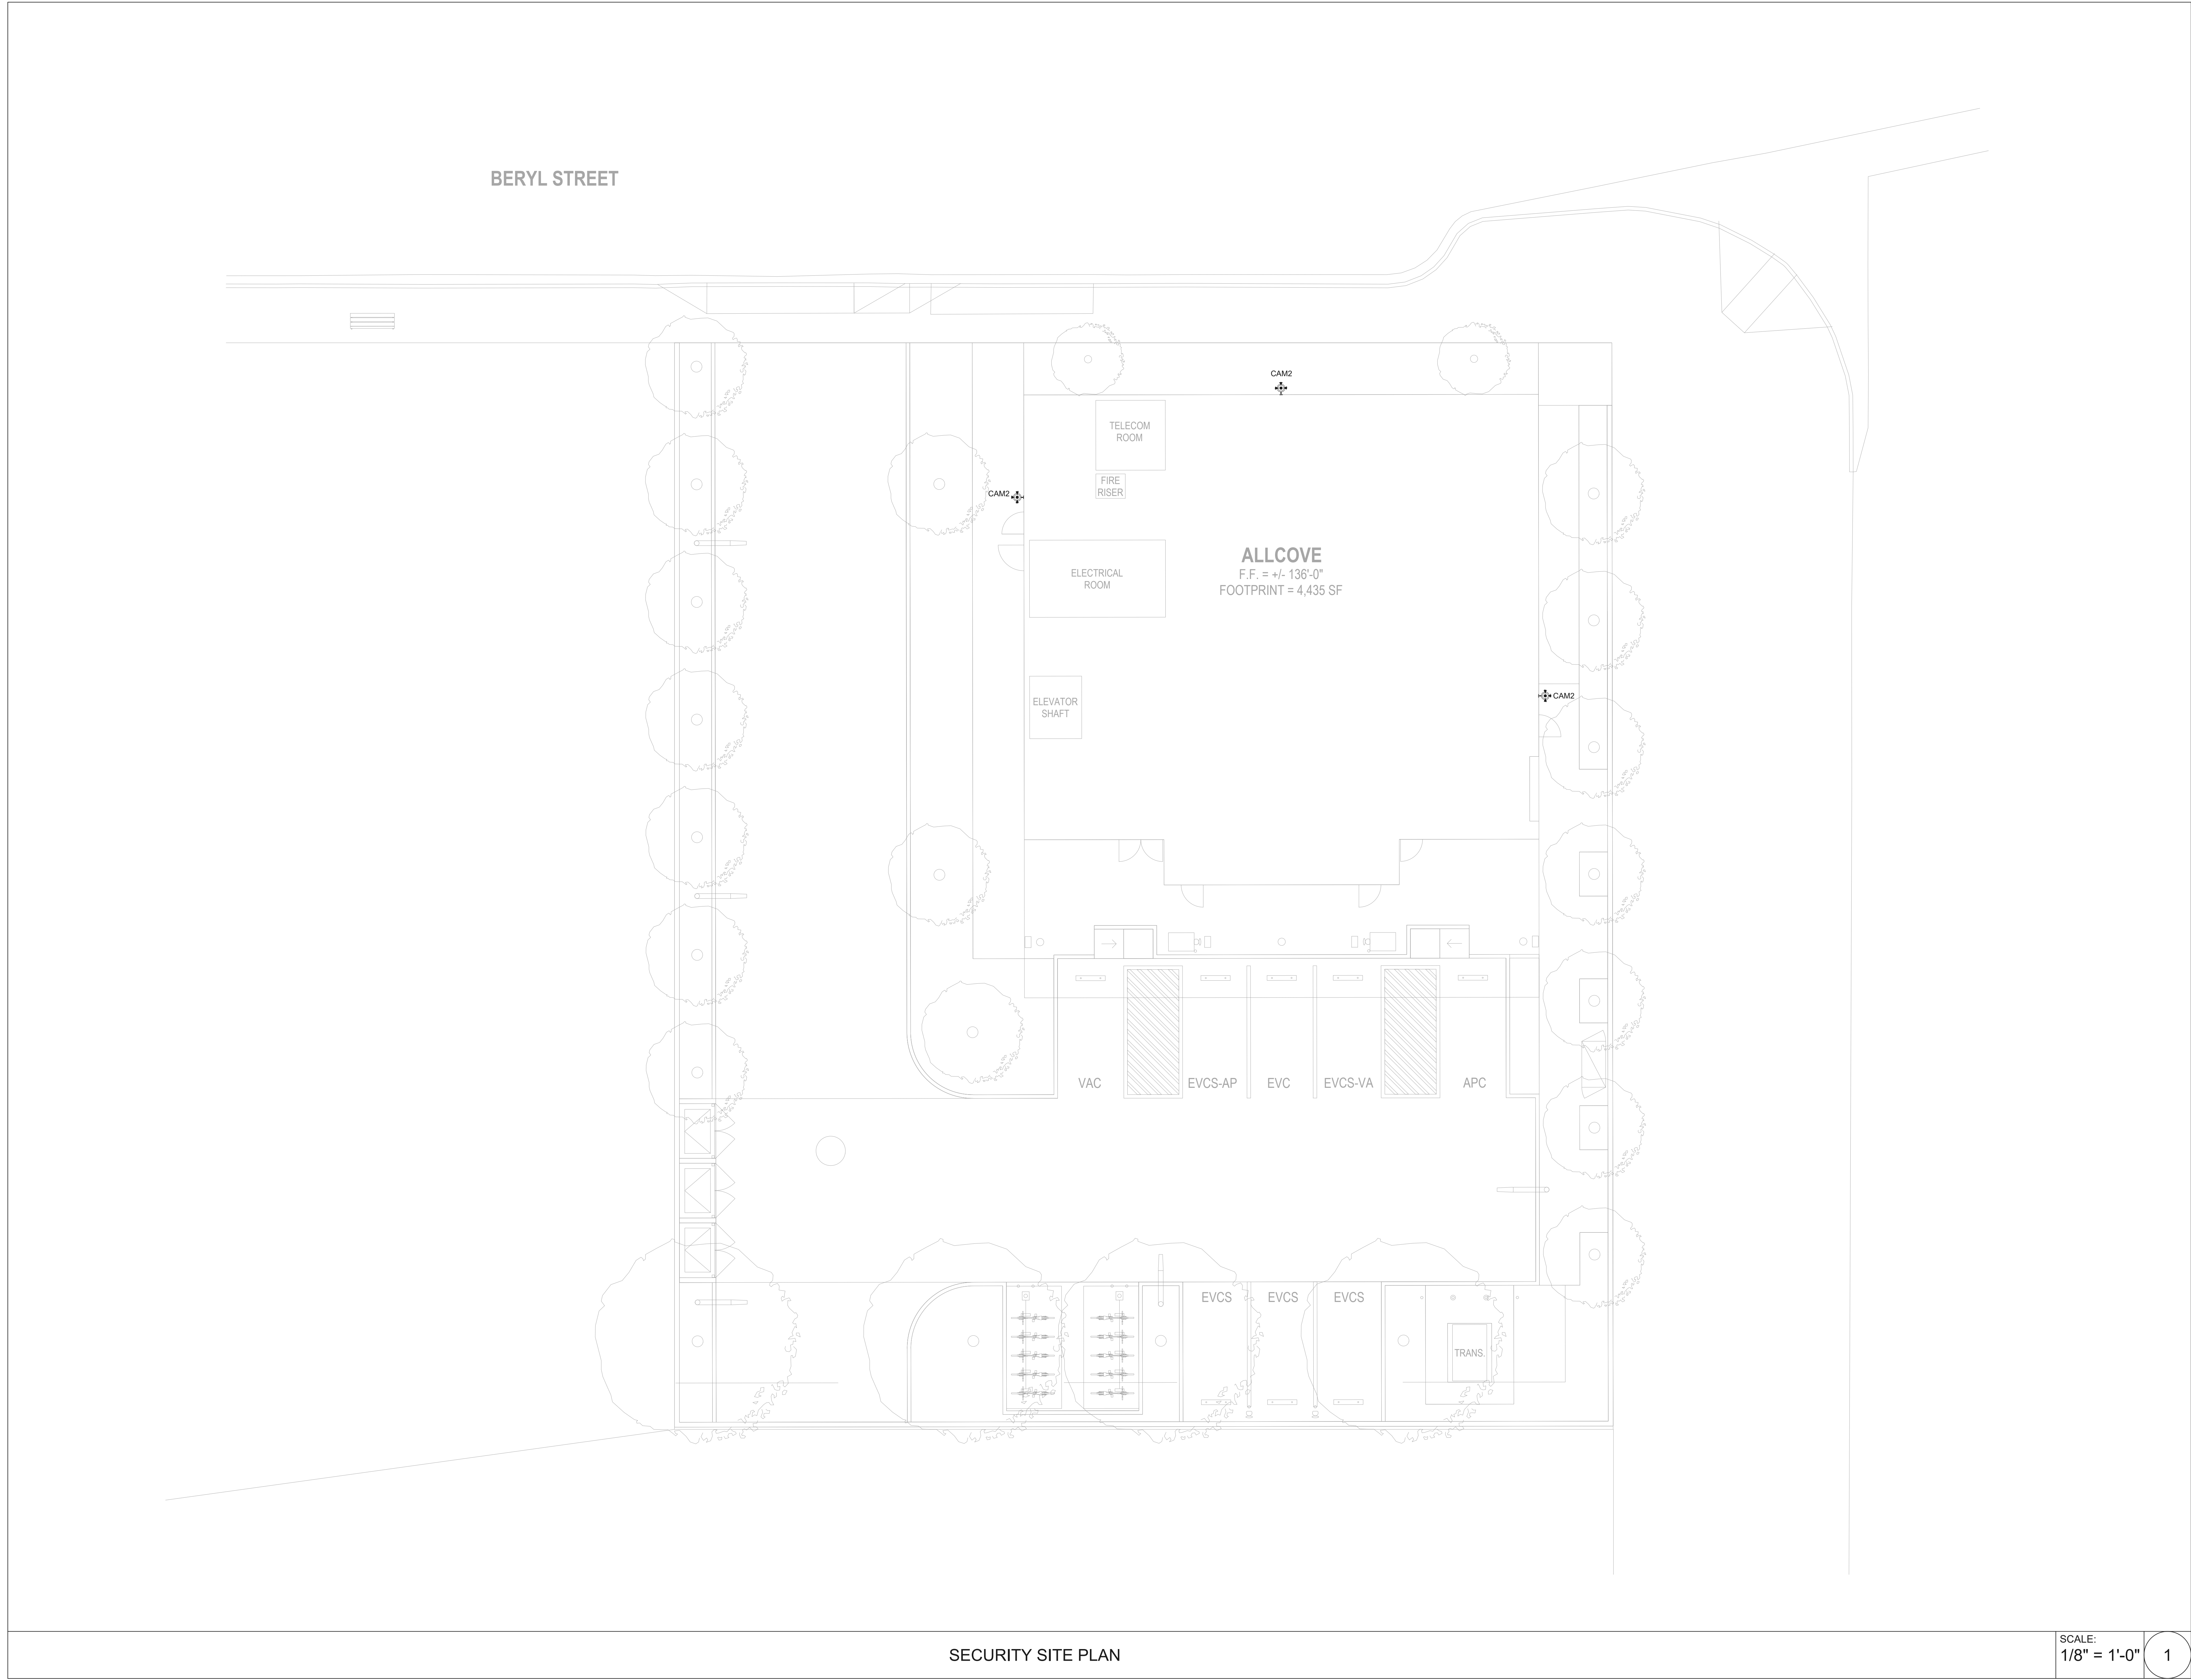
SC001



TYPICAL SECURITY DEVICE ID ABBREVIATIONS			
CARD READERS (CR)	COMMUNICATION SYSTEMS (CS)	ACCESS CONTROL SYSTEMS (ACS)	INTRUSION DETECTION SYSTEMS (IDS)
CR1 - CONTACTLESS SMART CAR READER	ECB - EMERGENCY CALL BOX	ACP - ACCESS CONTROL PANEL	AS - ALARM SOUNDER
CR2 - CONTACTLESS SMART CAR READER WITH KEYPAD	EP - EMERGENCY PHONE	AD - ACCESS CONTROL DOOR CONTROLLER	DP - DOOR POSITION SWITCH
CR3 - MULLION CONTACTLESS SMART CAR READER	IC - INTERCOM	ADO - AUTOMATIC DOOR OPENER	DB - DURESS BUTTON
EPB - ELECTRIFIED PANIC BAR	GT - GUARD TOUR	BGS - BADGING SYSTEM	GB - GLASS BREAK
PB - NON-ELECTRIFIED PANIC BAR	VI - VIDEO INTERCOM DOOR STATION SURFACE MOUNT	BD - BIOMETRIC DEVICE	MD - MOTION DETECTOR
	VM - VIDEO INTERCOM MASTER STATION	CR - CARD READER	
		DO - DOOR OPERATOR	
		DP - DOOR POSITION SWITCH	
		EC - ELEVATOR CONTROL UNIT	
		EIP - ELEVATOR INTERFACE PANEL	
		EL - ELECTRIFIED LOCK - SHOWN FOR COORDINATION, SEE DIVISION 8	
		HB - HANDICAP PUSH BUTTON	
		KFR - KEYFOB READER	
		KP - KEYPAD	
		LPS - ACCESS CONTROL LOCKING POWER SUPPLY	
		MFC - MULTI FLOOR ELEVATOR CONTROLLER	
		ML - MAGNETIC LOCK	
		PS - POWER SUPPLY	
		RAR - REMOTE ACCESS READER	
		REX - REQUEST TO EXIT	
		RR - REMOTE RELEASE	
		WL - WIRELESS LOCK	
		WT - WIRELESS LOCK TRANSCEIVER	








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SECURITY FLOOR PLAN - FIRST FLOOR
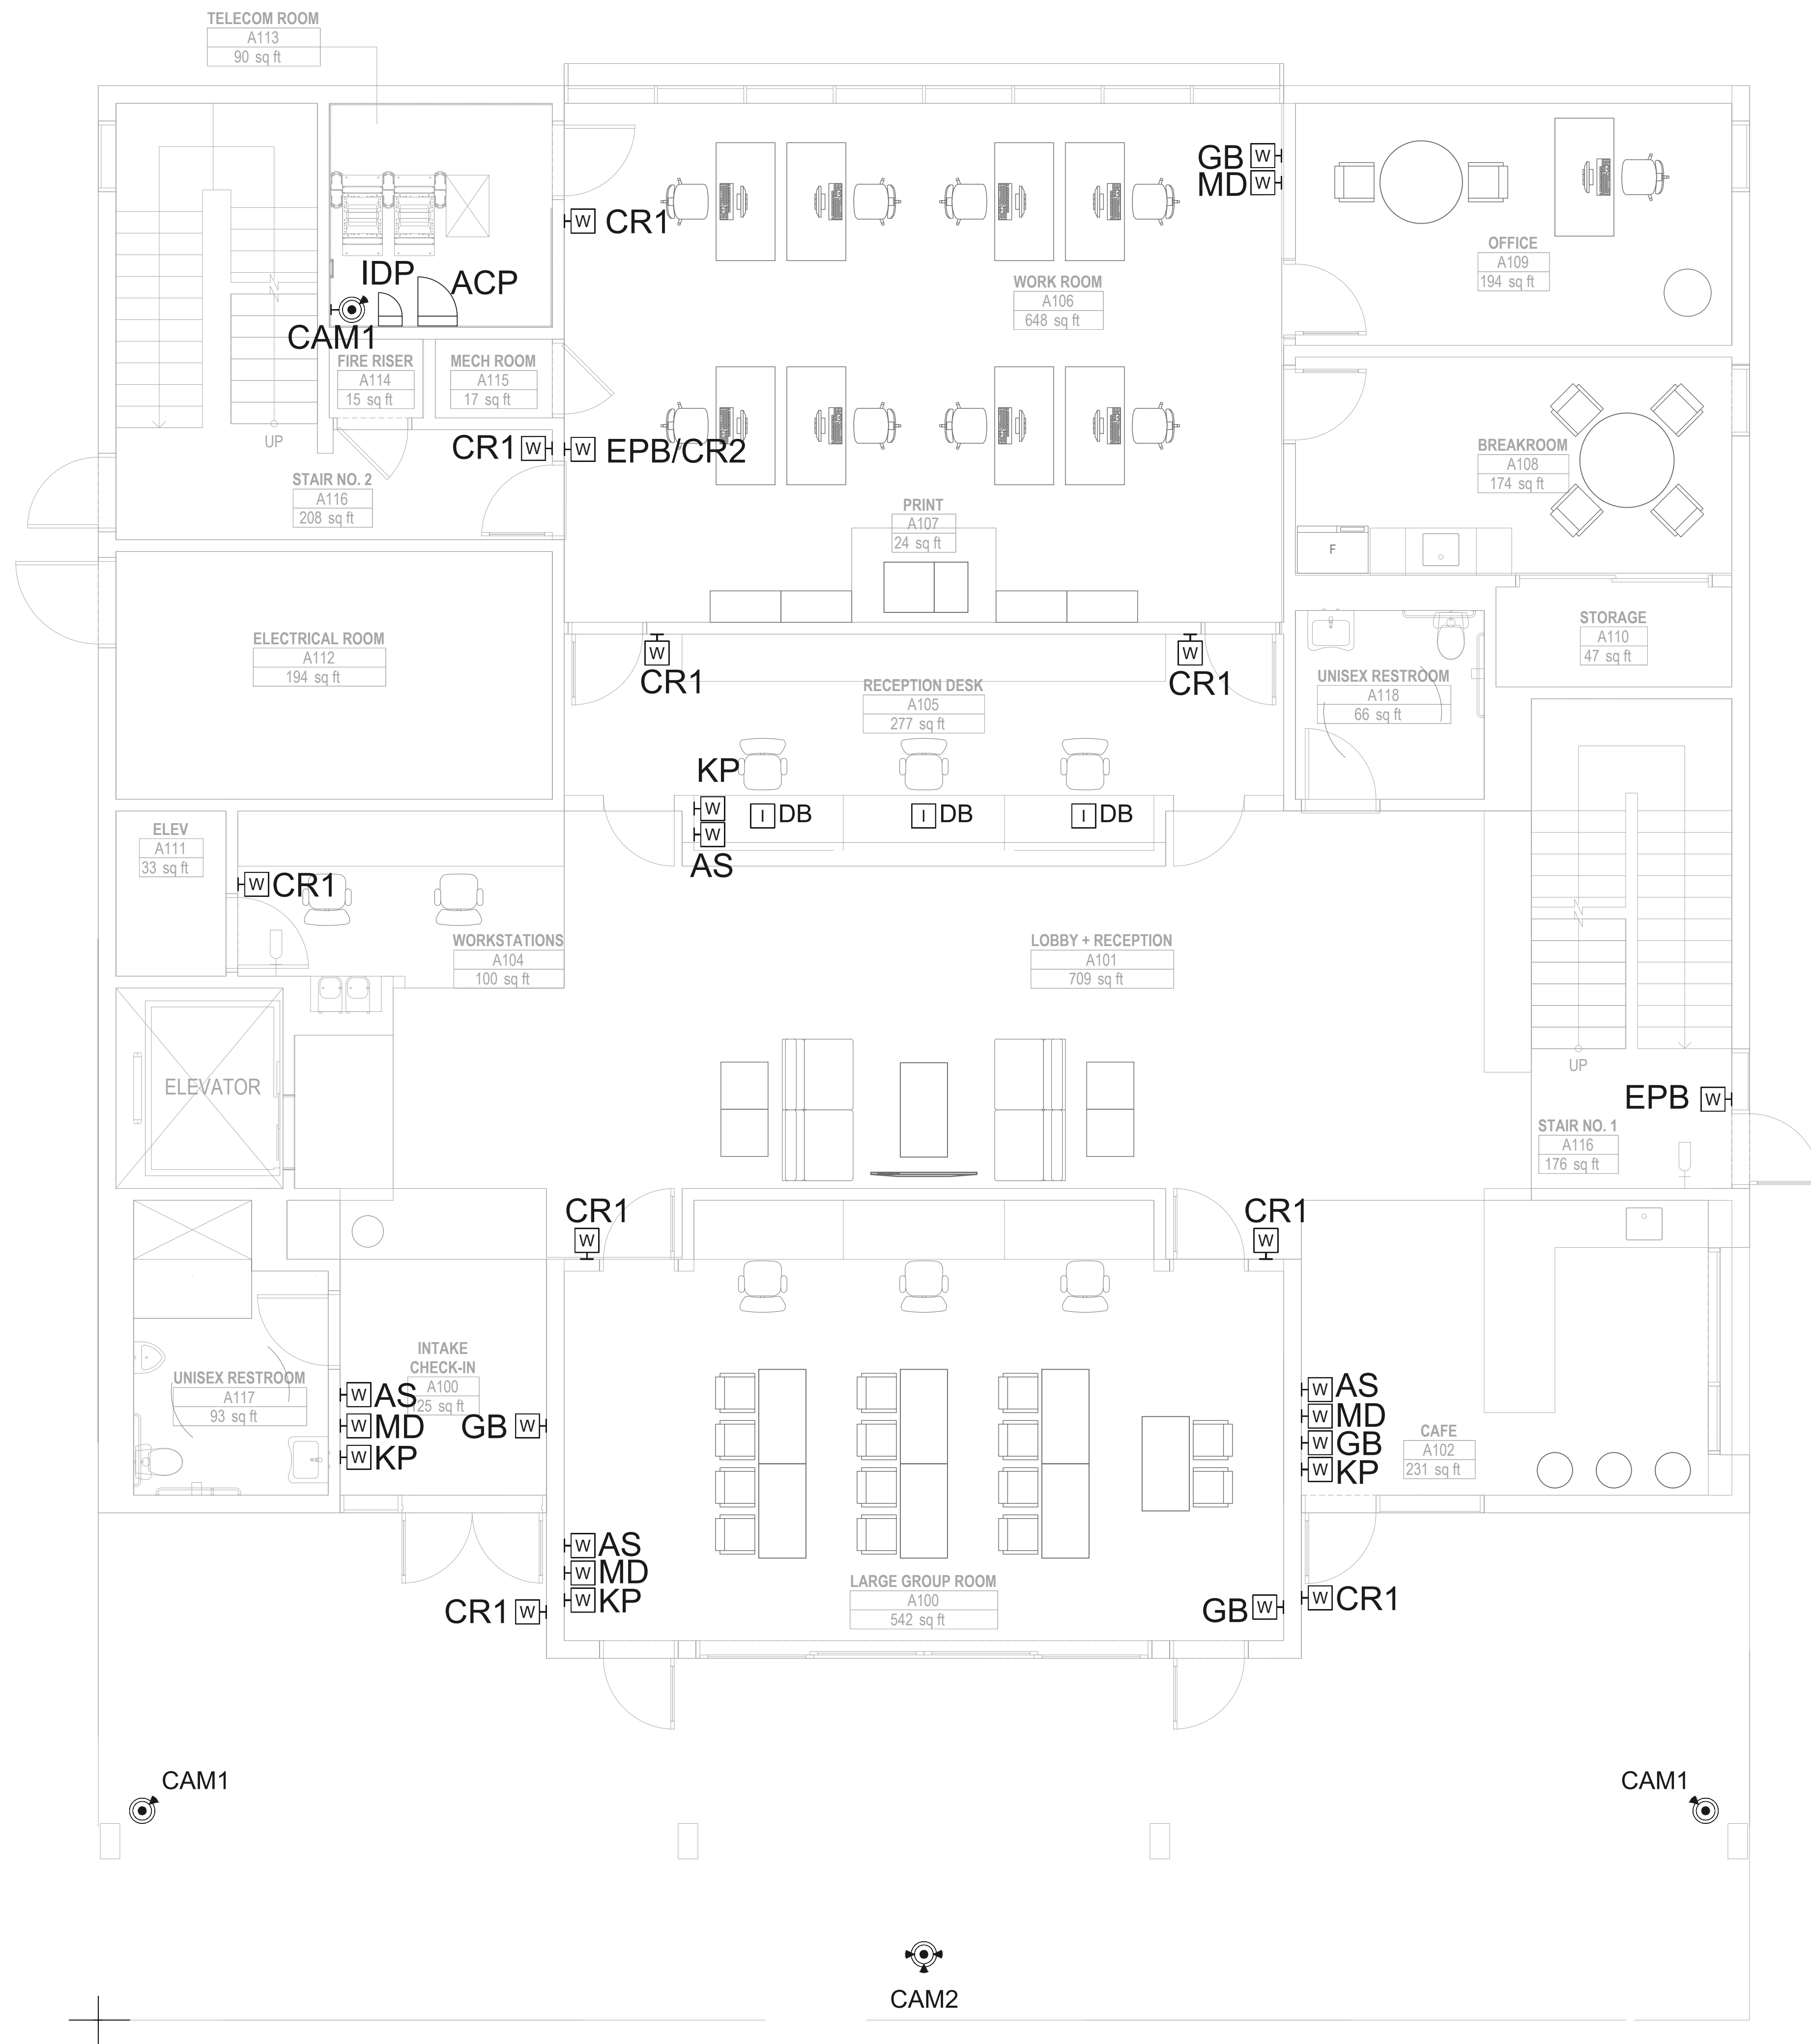
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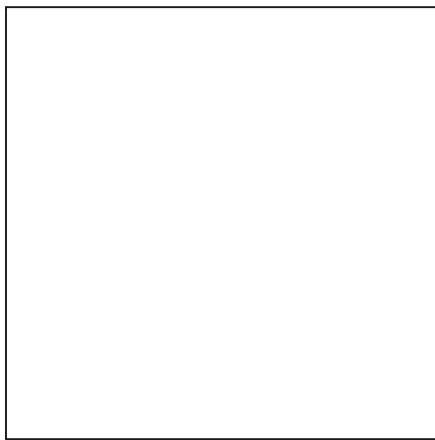
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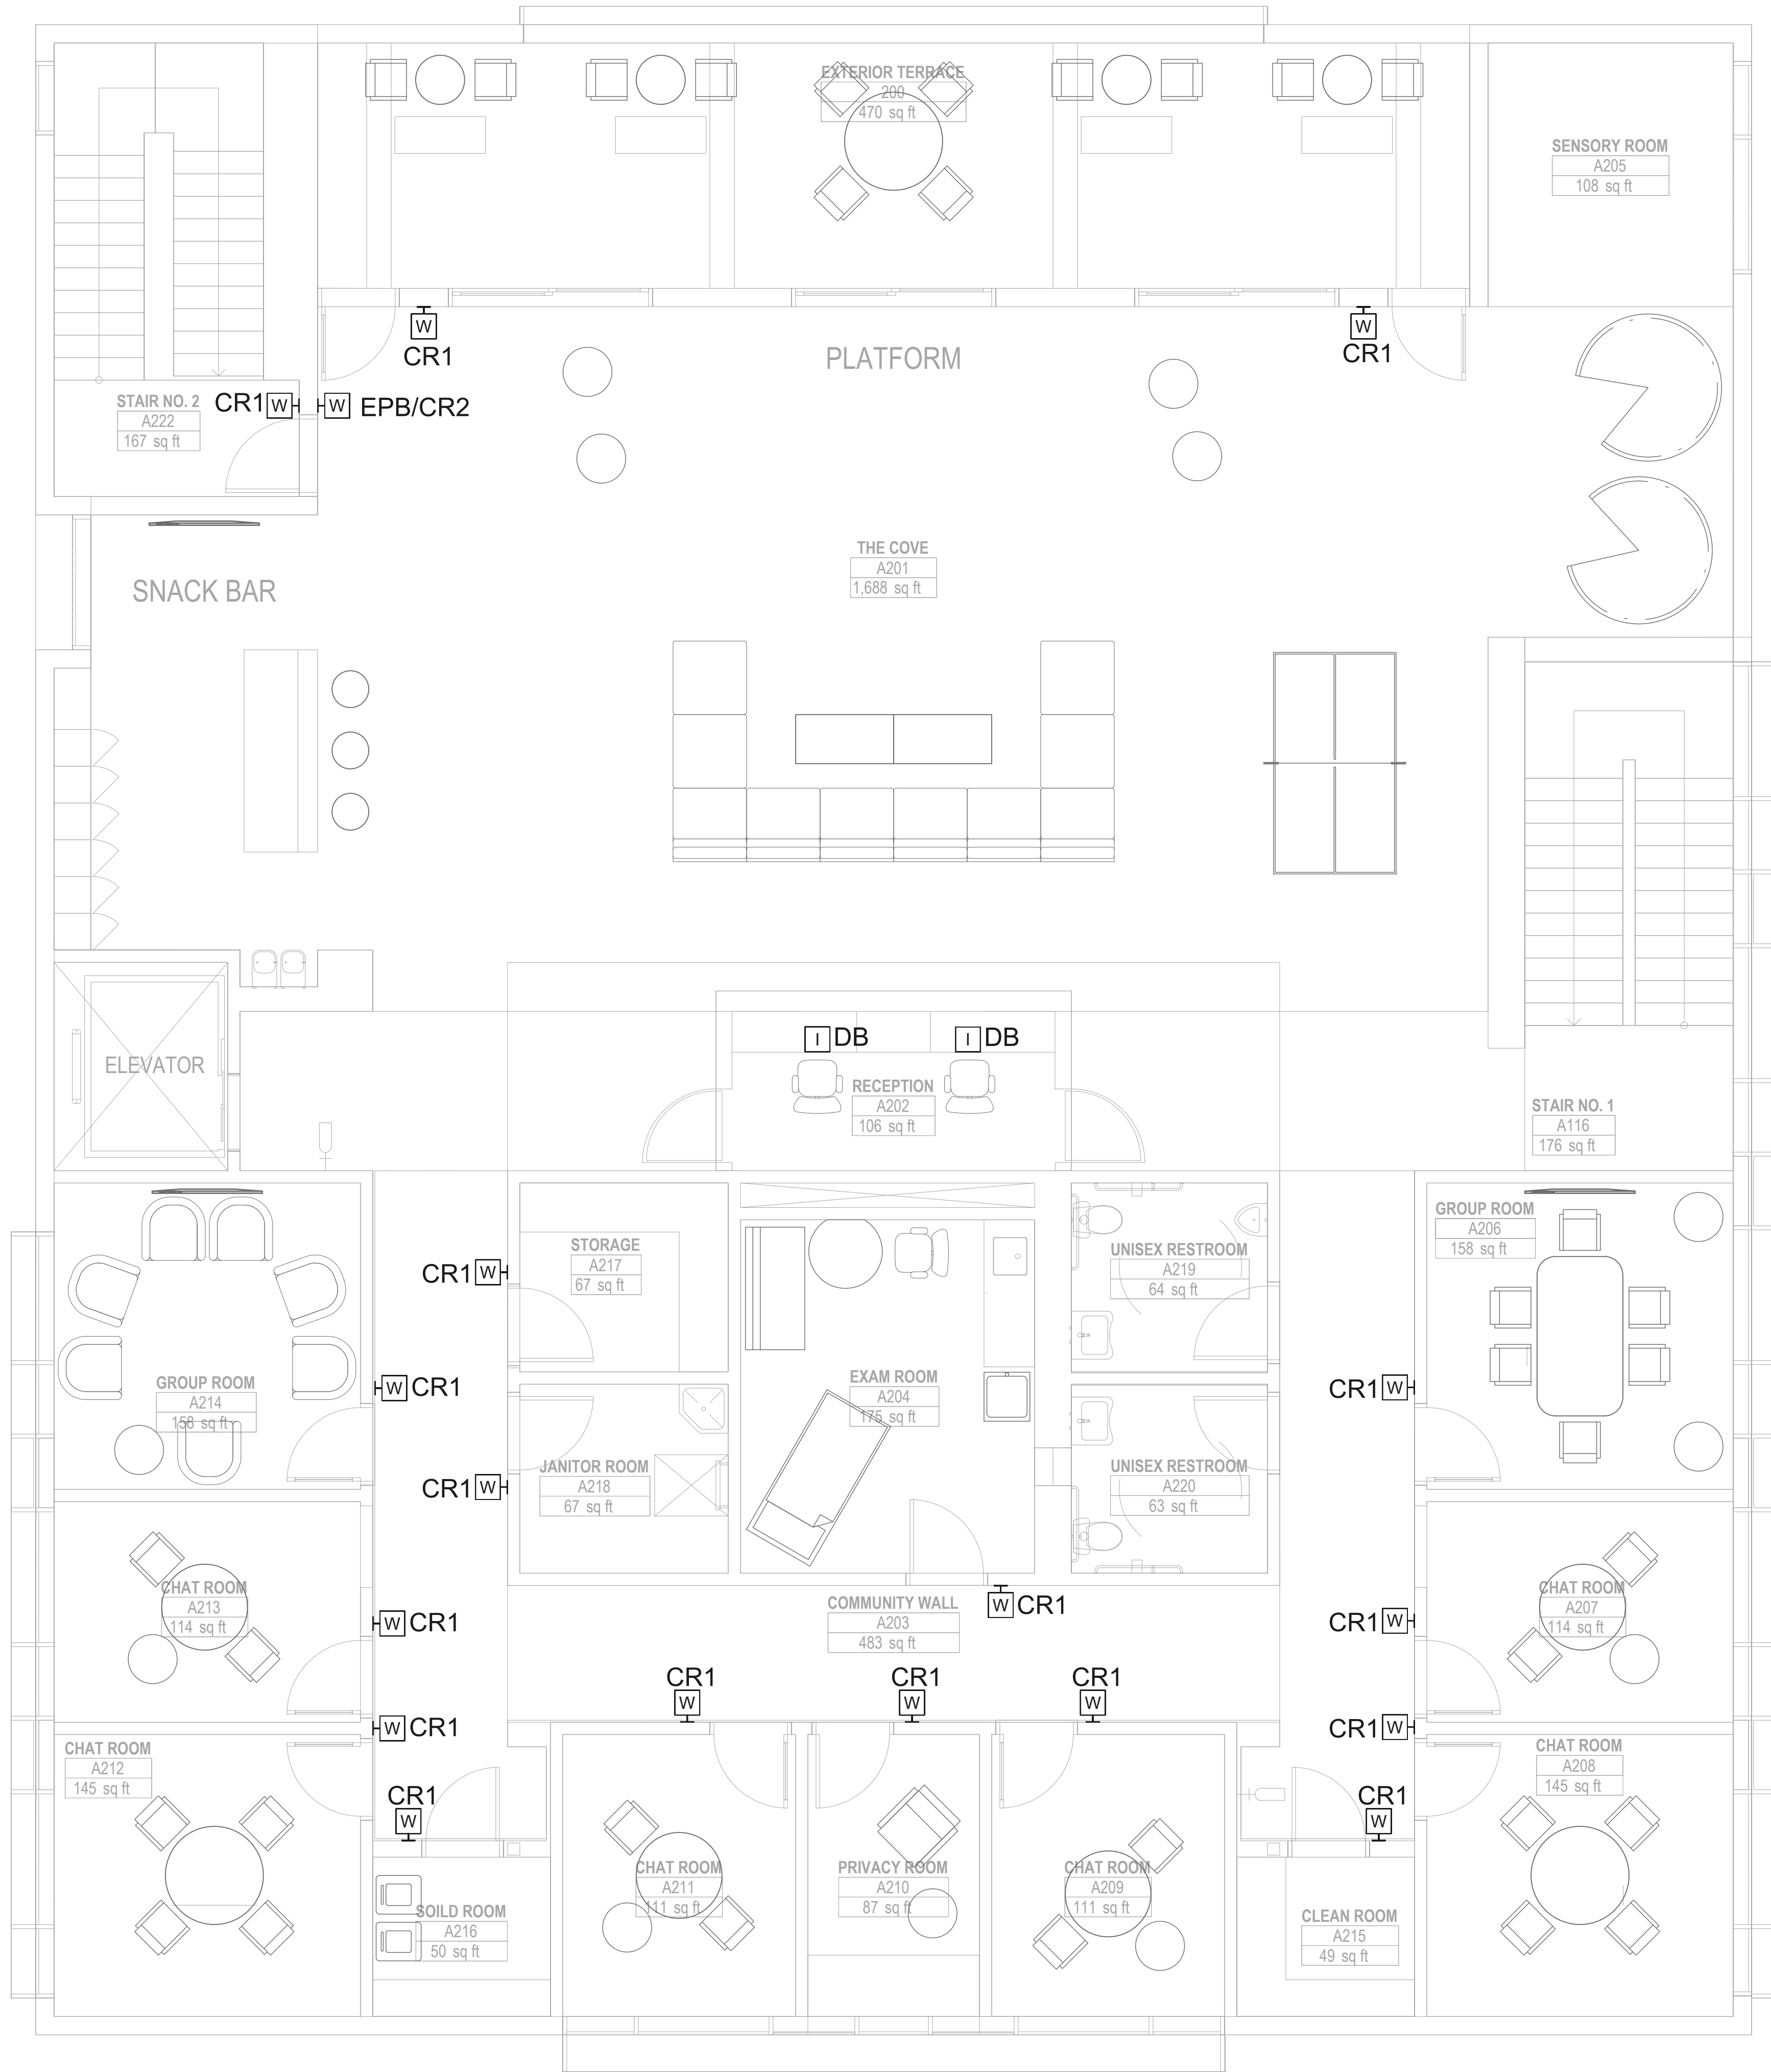
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SECURITY FLOOR PLAN - SECOND FLOOR

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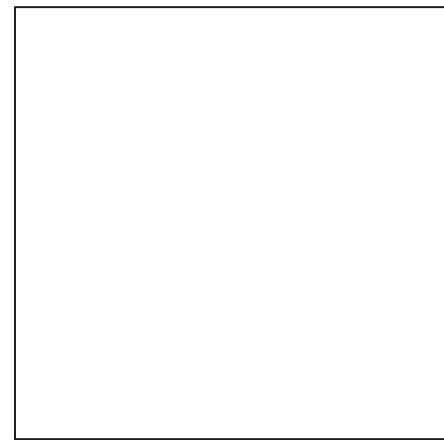
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**SECURITY SECOND  
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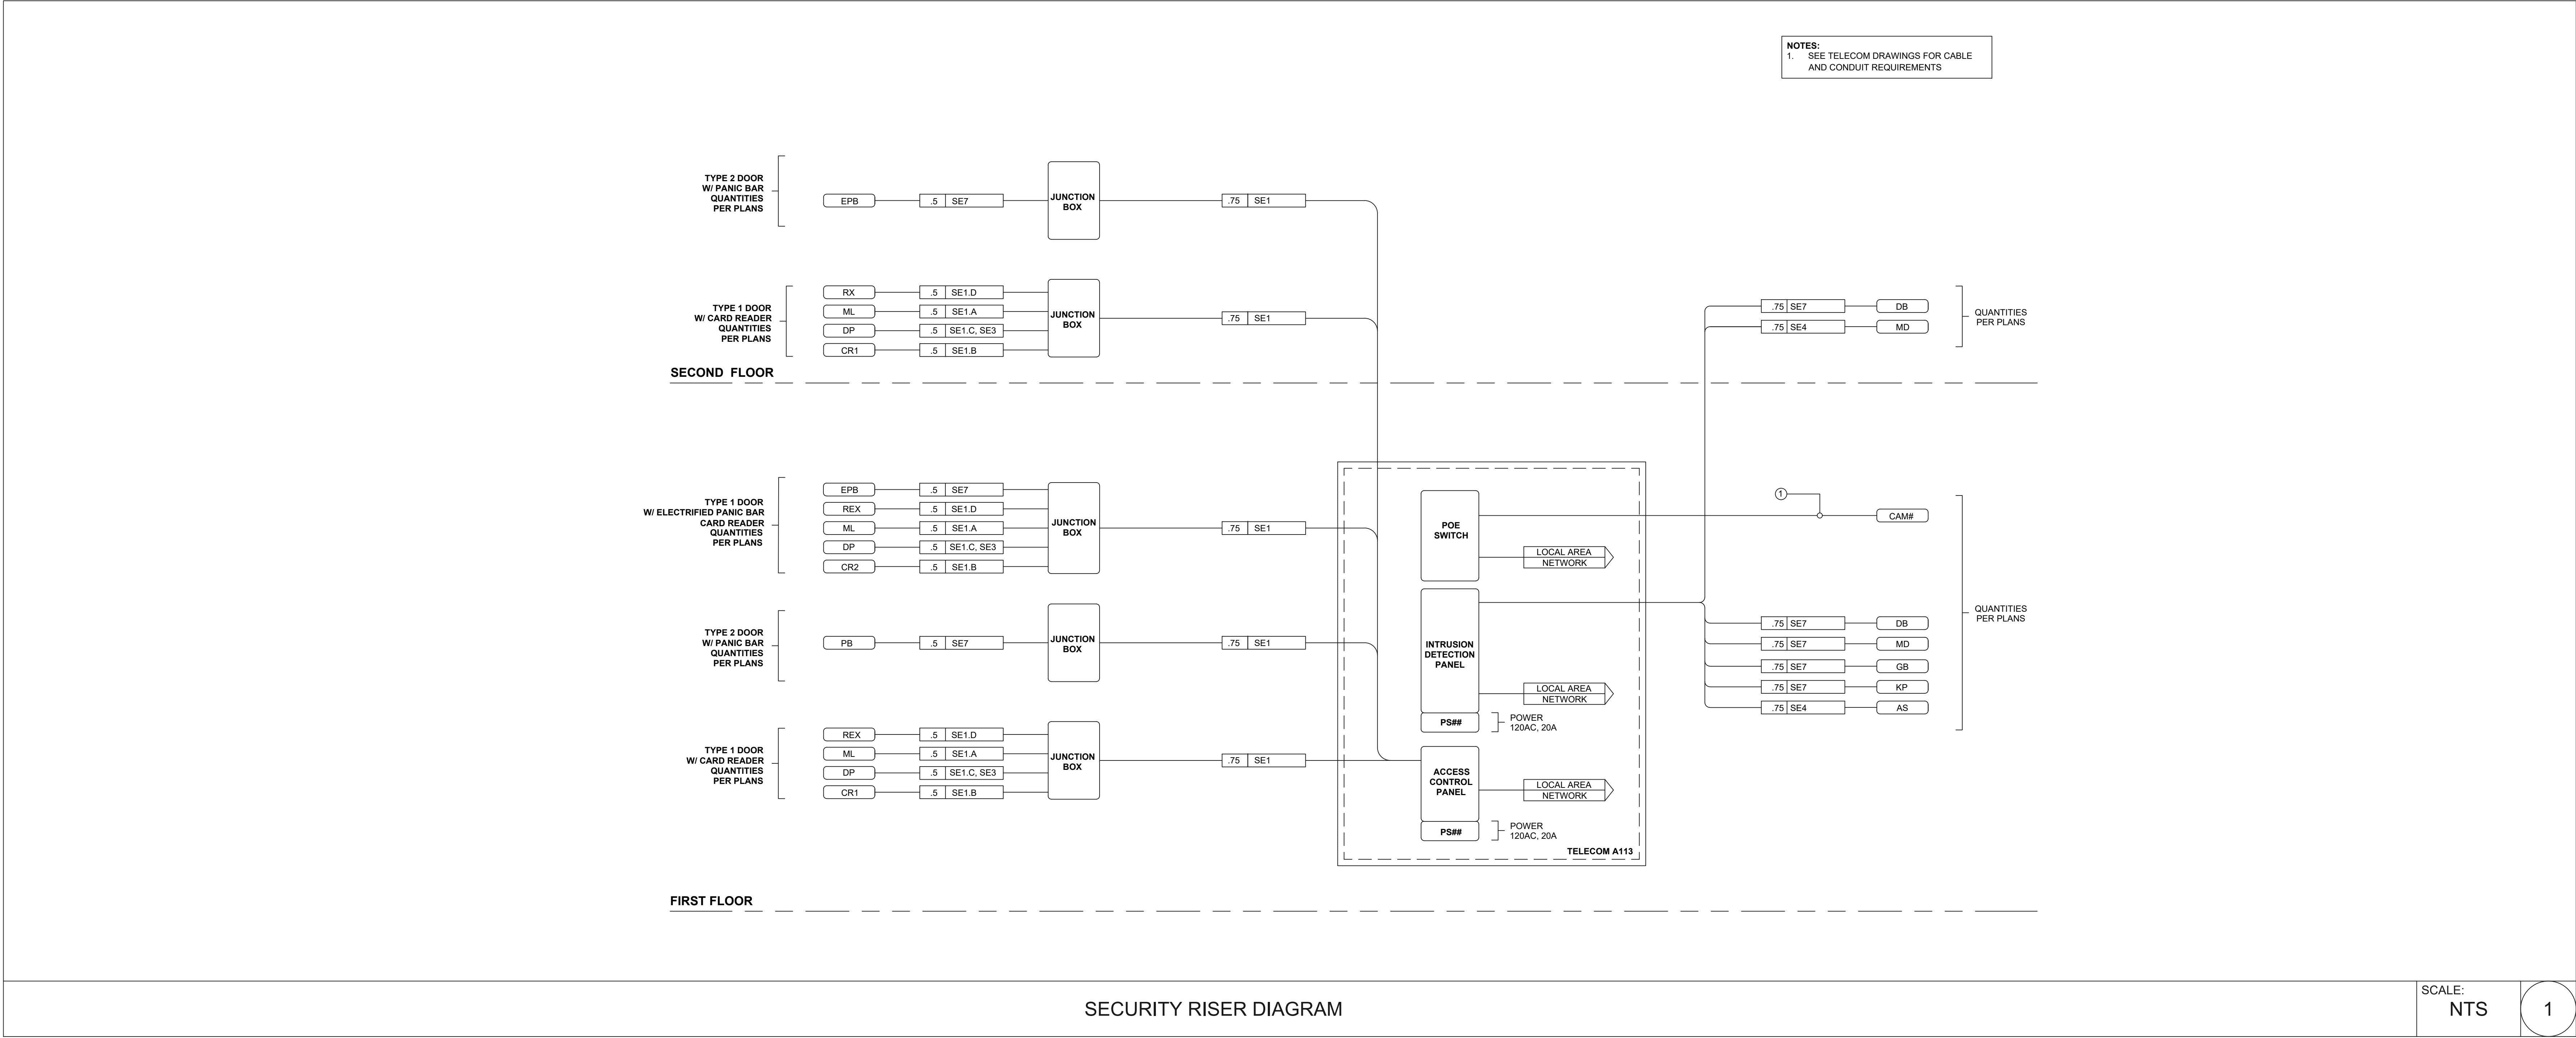
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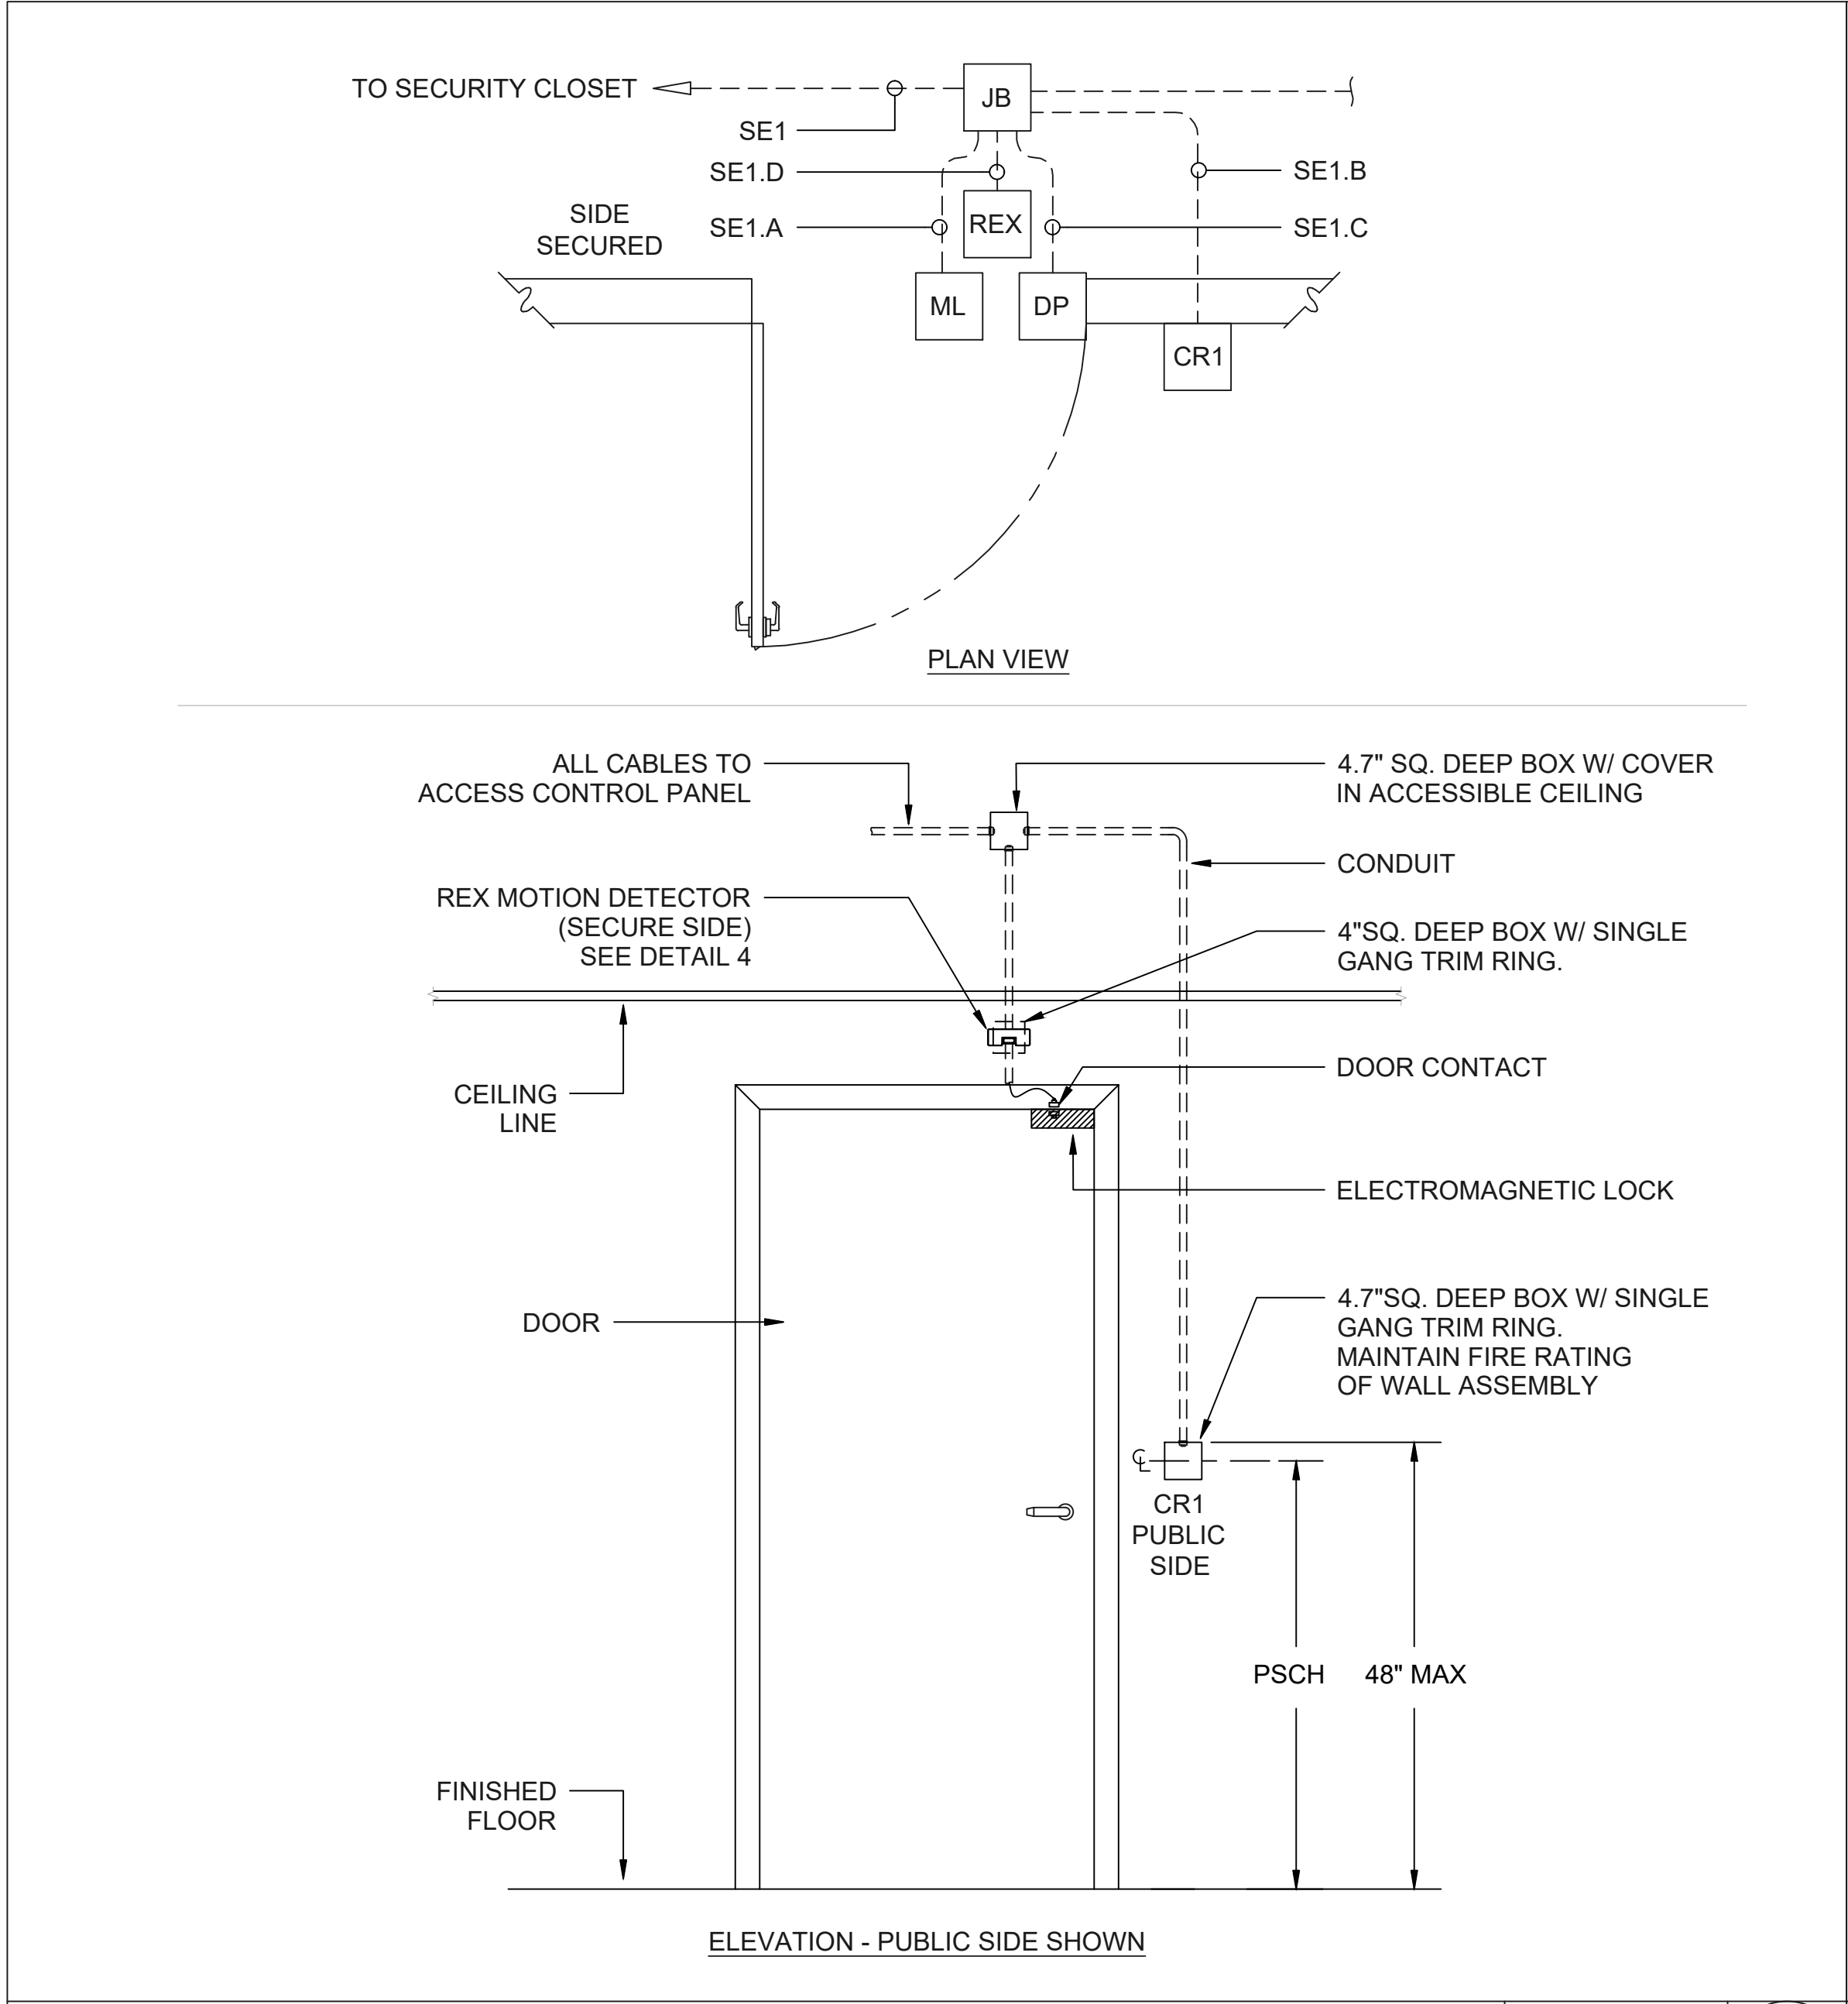
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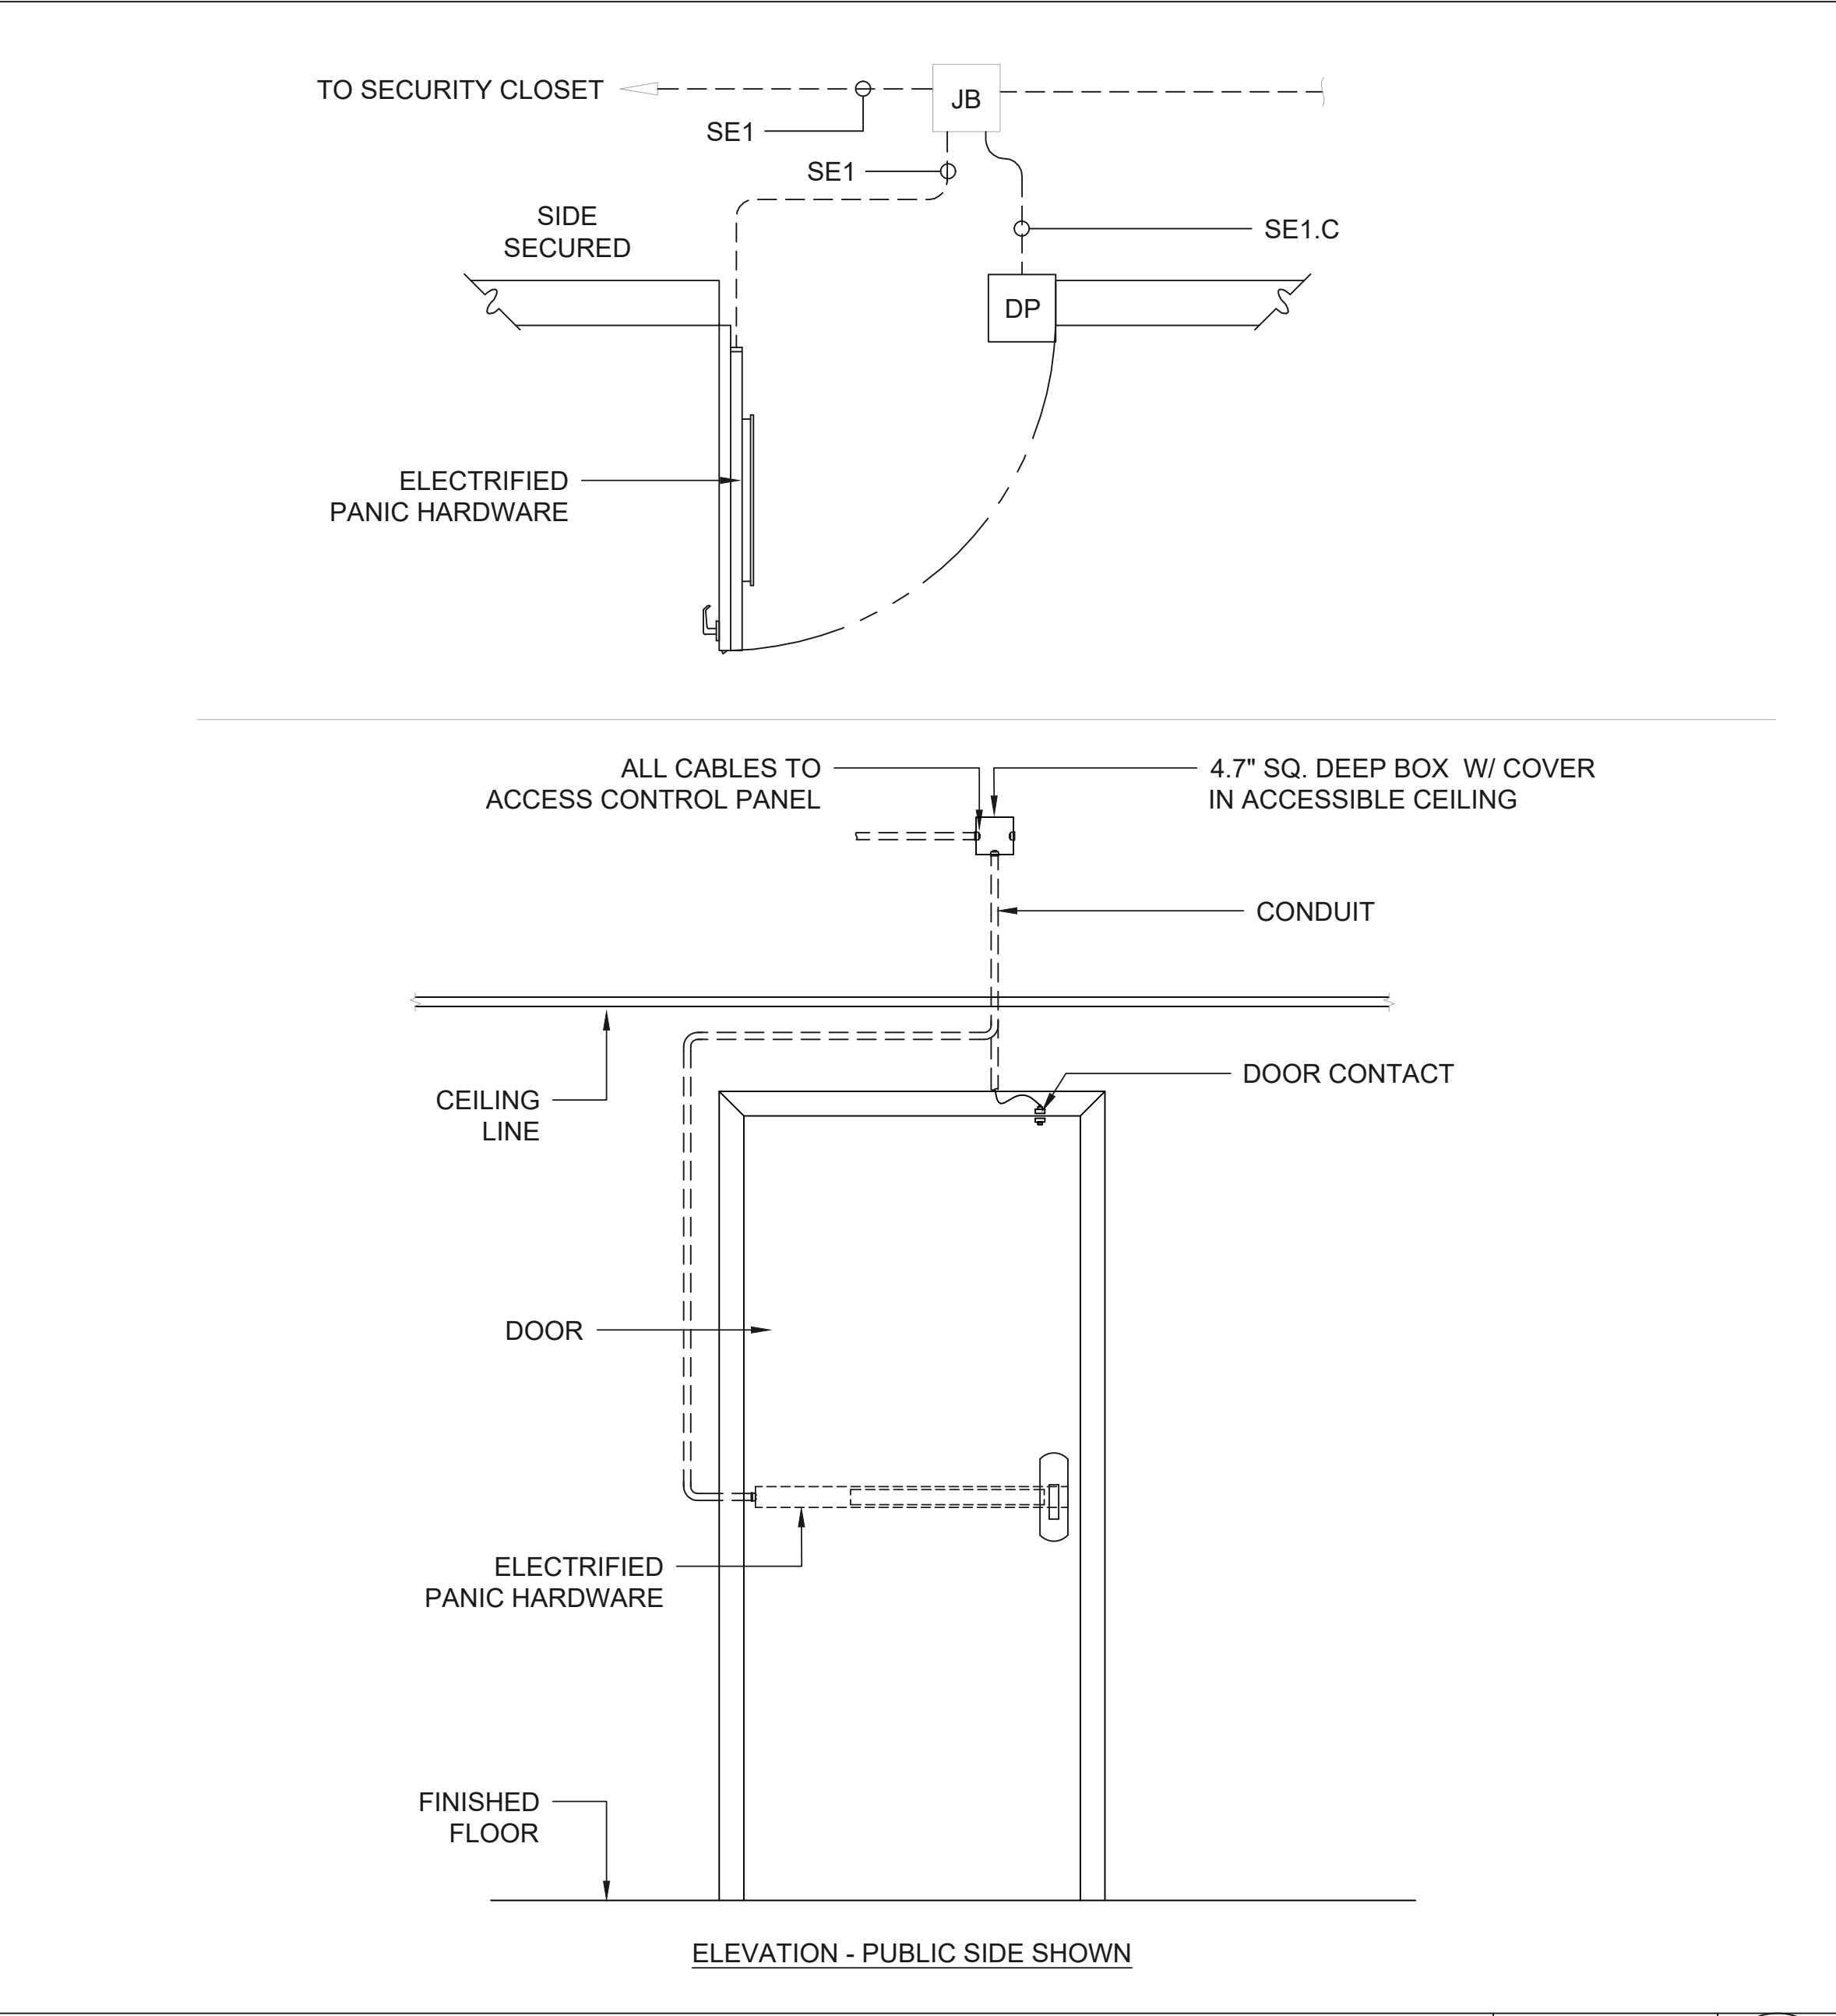







TYPICAL "CR1" DOOR TYPE DETAIL

SCALE: NTS 1




TYPICAL "EPB" DOOR TYPE DETAIL

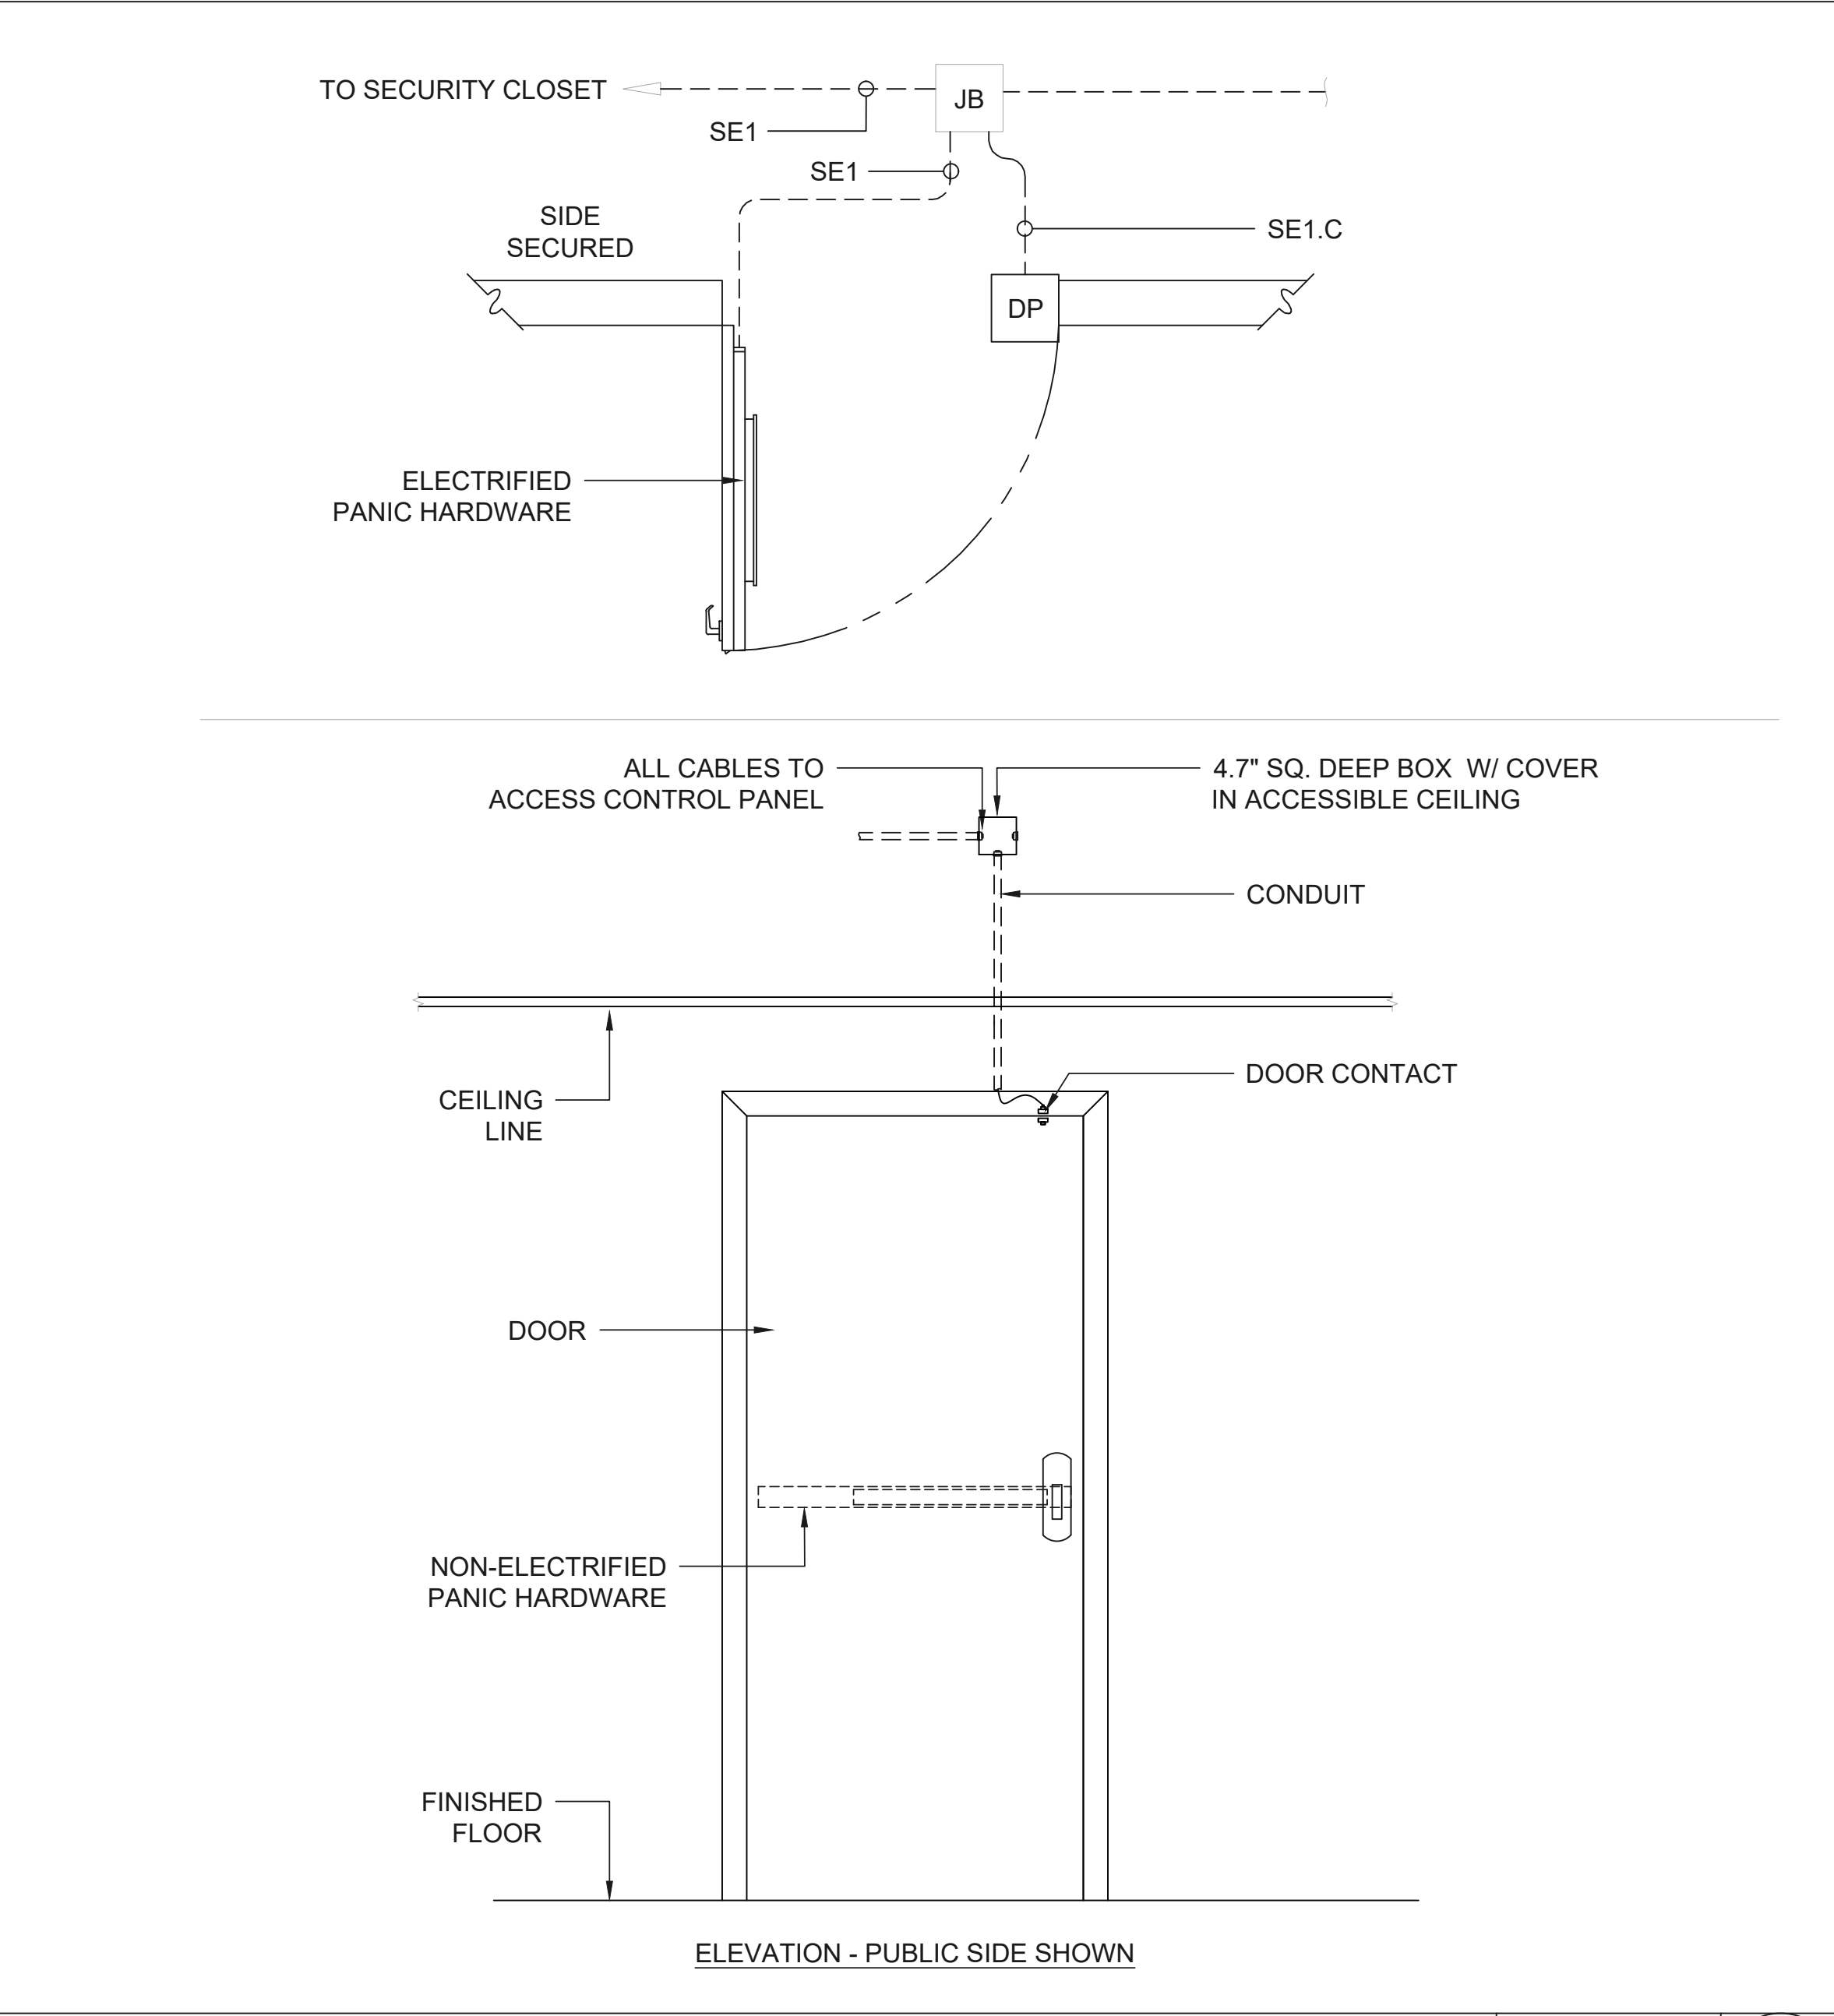SCALE: NTS 2



TYPICAL "PB" DOOR TYPE DETAIL

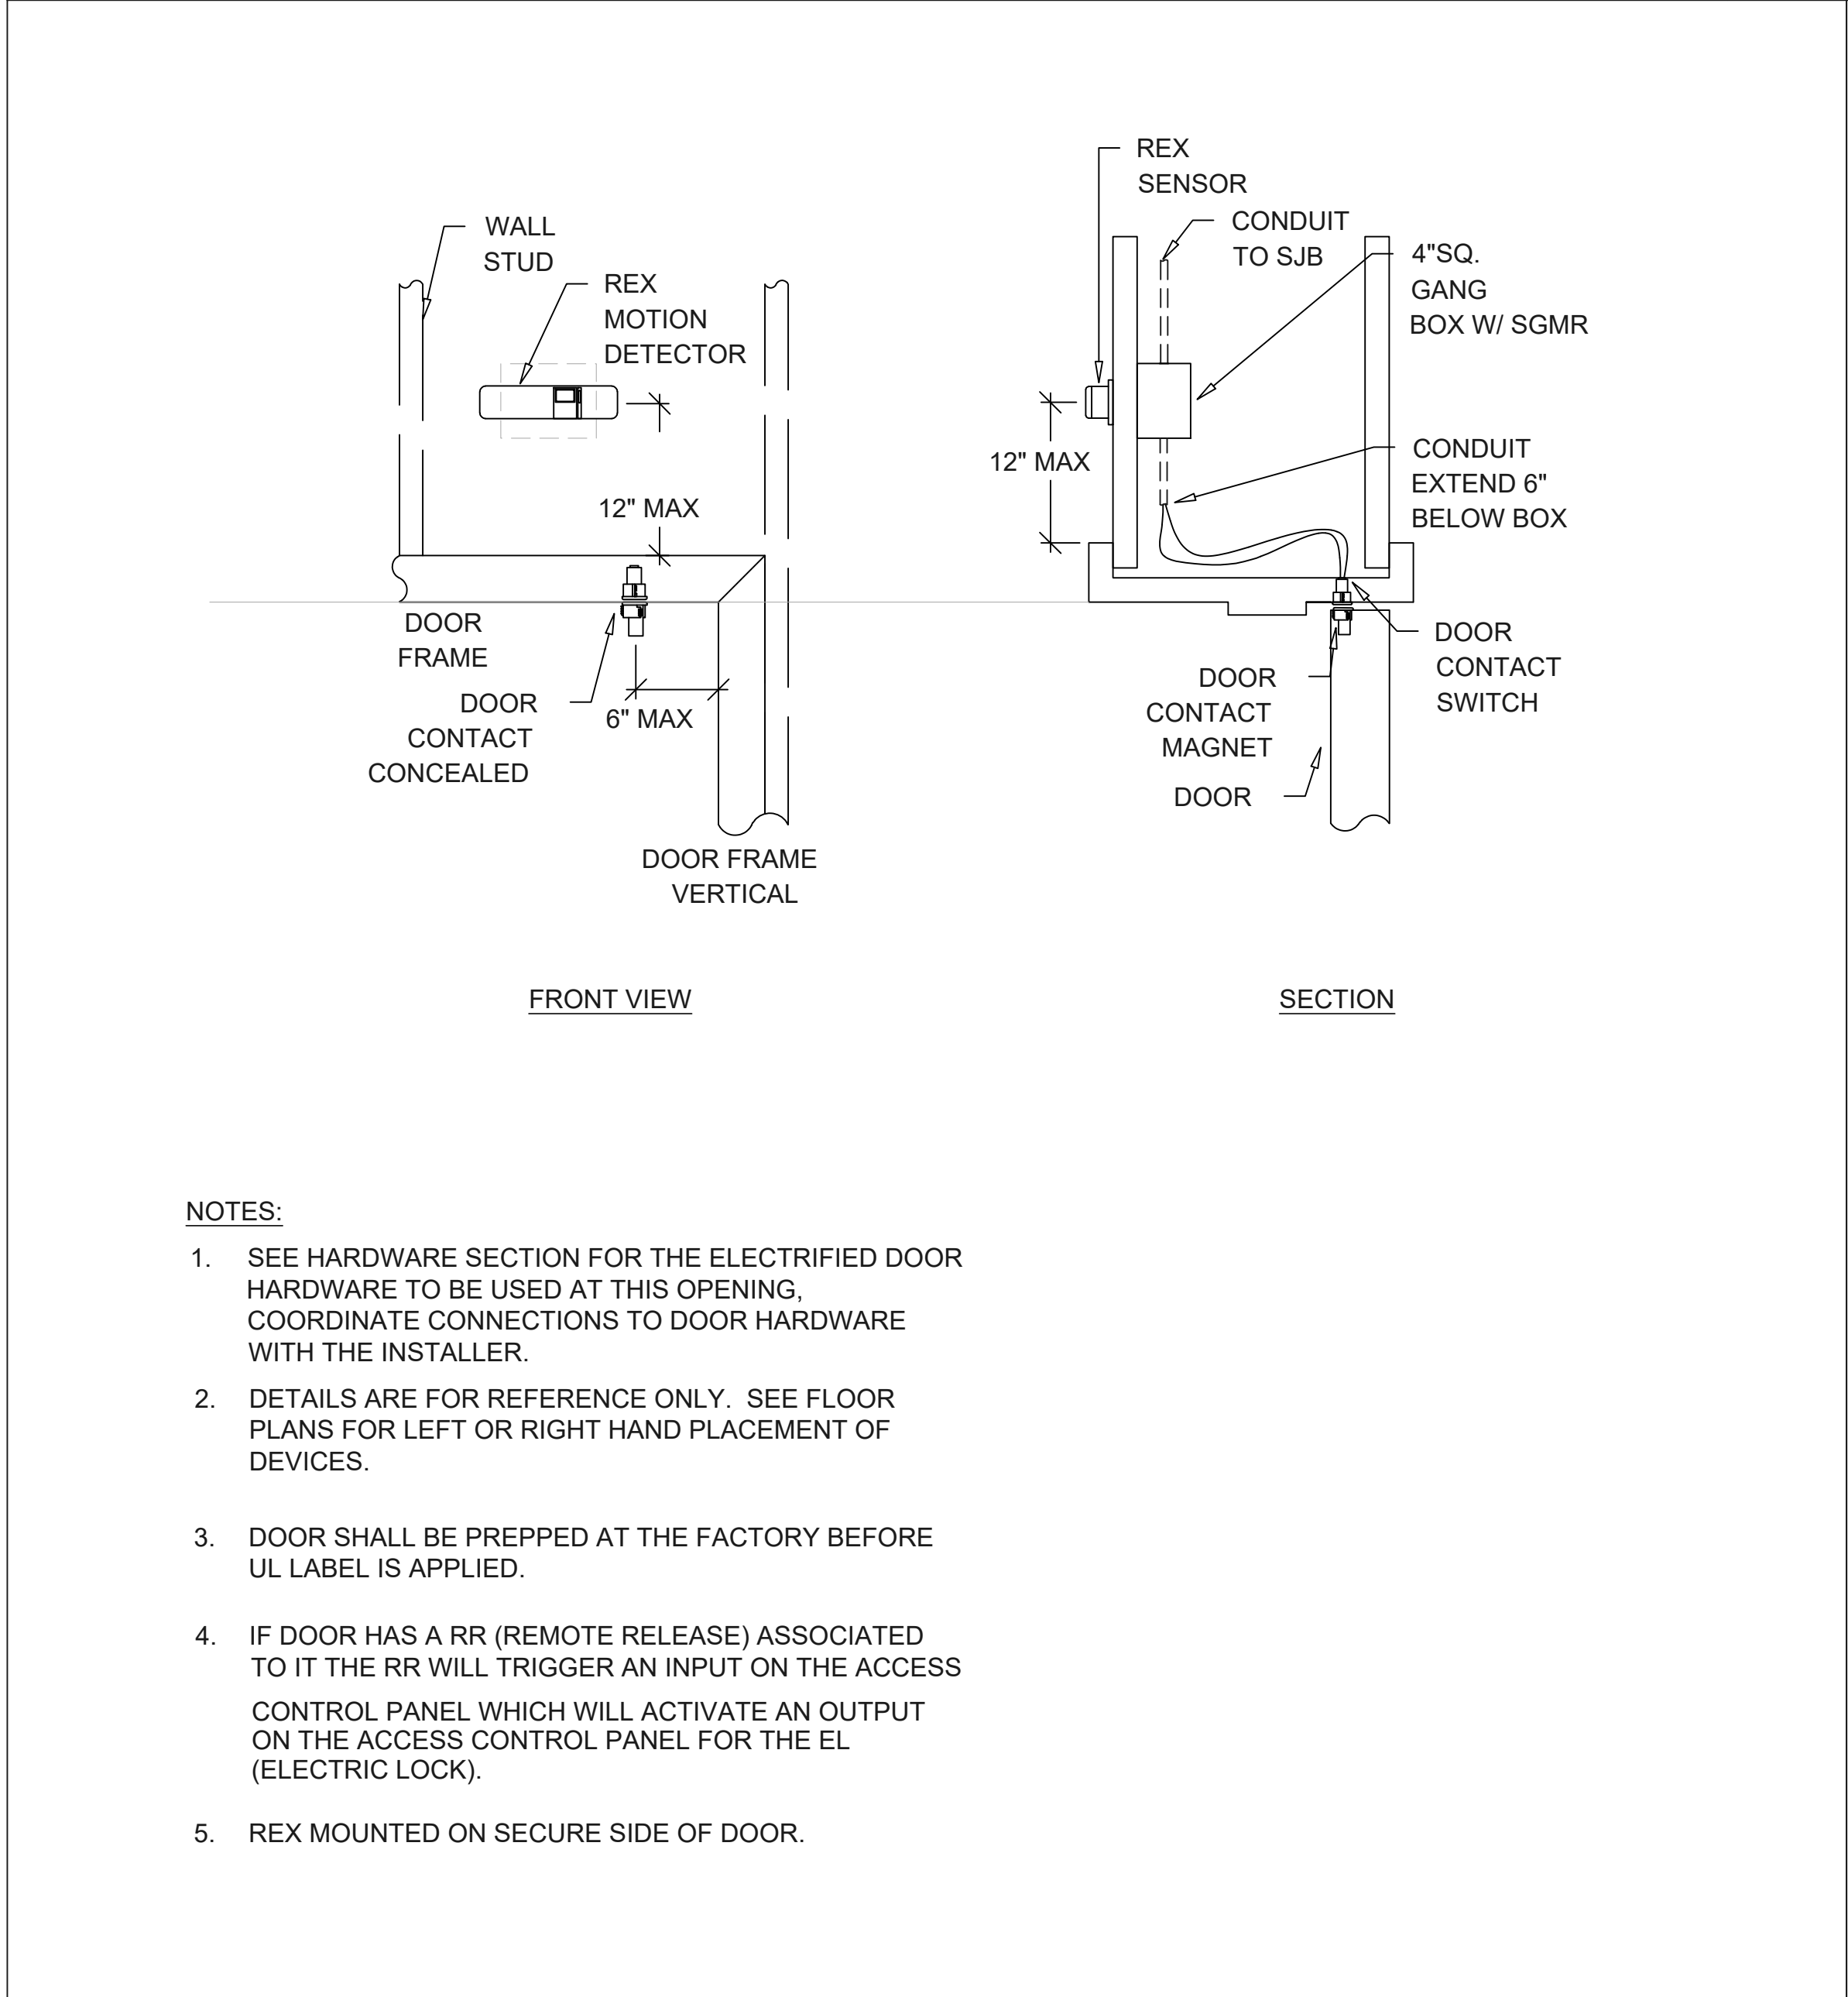
SCALE: NTS 3



- NOTES:
- SEE HARDWARE SECTION FOR THE ELECTRIFIED DOOR HARDWARE TO BE USED AT THIS OPENING. COORDINATE CONNECTIONS TO DOOR HARDWARE WITH THE INSTALLER.
  - DETAILS ARE FOR REFERENCE ONLY. SEE FLOOR PLANS FOR LEFT OR RIGHT HAND PLACEMENT OF DEVICES.
  - DOOR SHALL BE PREPPED AT THE FACTORY BEFORE UL LABEL IS APPLIED.
  - IF DOOR HAS A RR (REMOTE RELEASE) ASSOCIATED TO IT THE RR WILL TRIGGER AN INPUT ON THE ACCESS CONTROL PANEL WHICH WILL ACTIVATE AN OUTPUT ON THE ACCESS CONTROL PANEL FOR THE EL (ELECTRIC LOCK).
  - REX MOUNTED ON SECURE SIDE OF DOOR.


TYPICAL REX AND DOOR CONTACT ENLARGED DETAIL

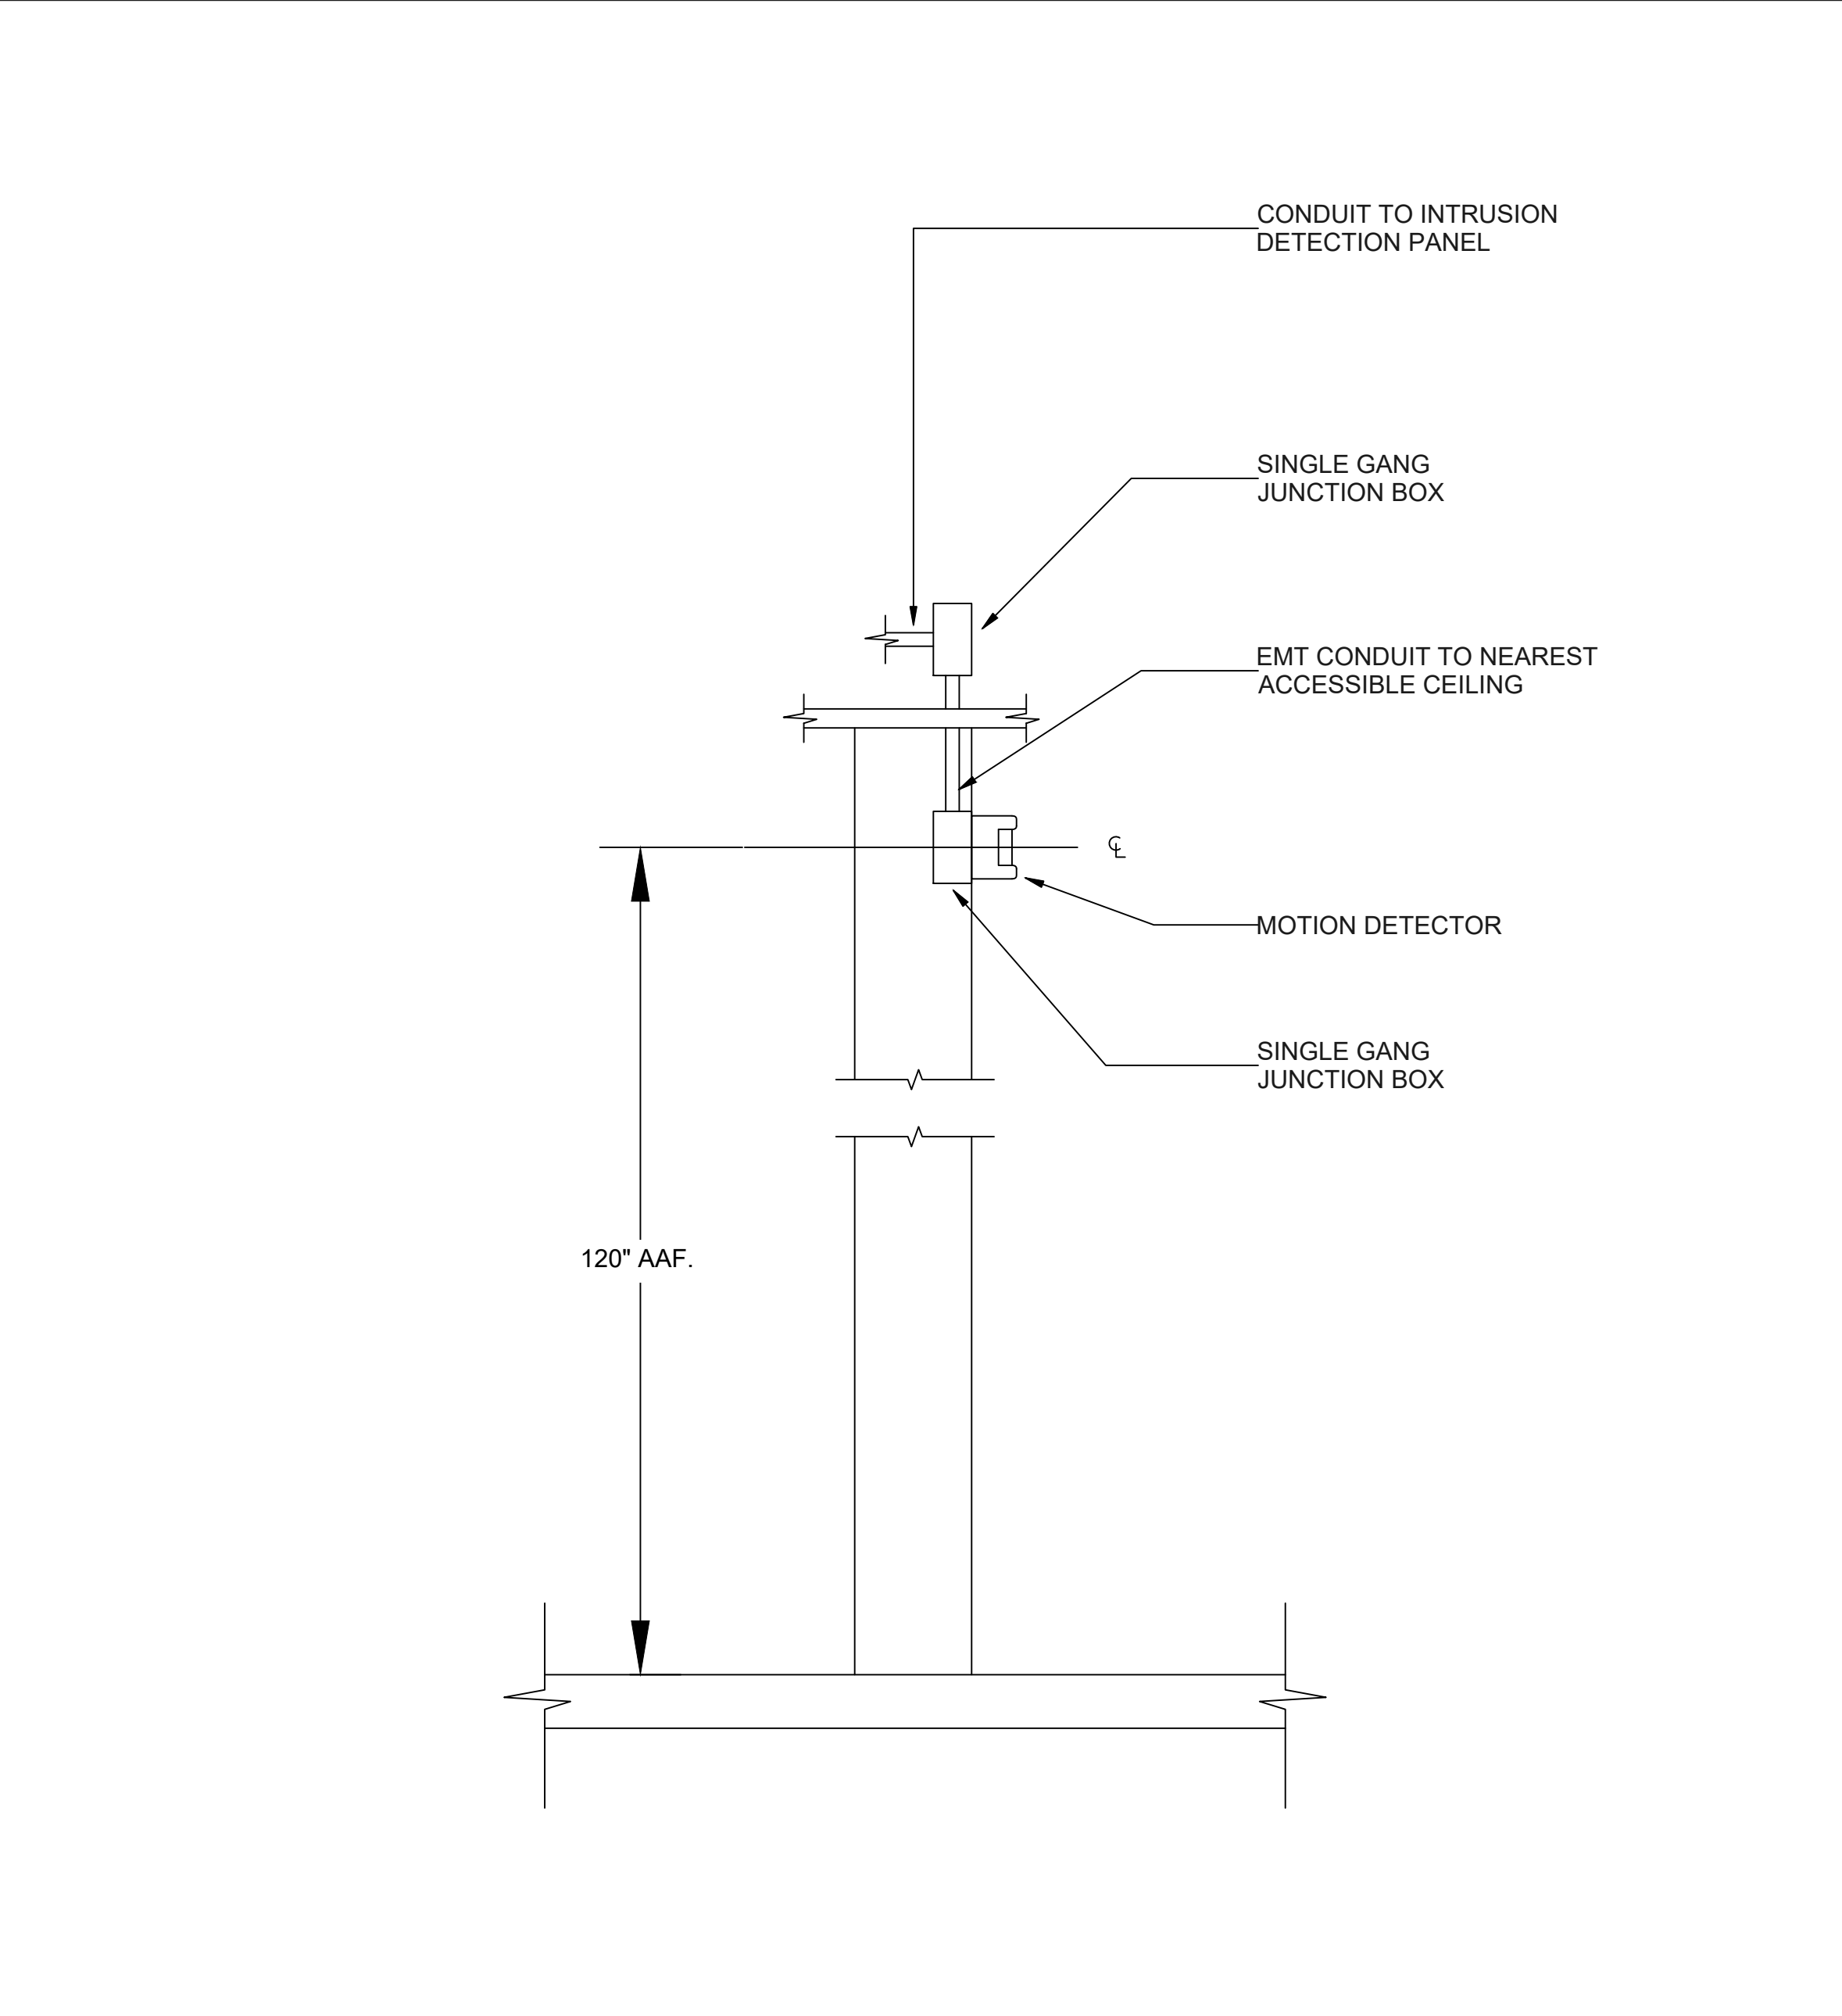SCALE: NTS 4



TYPICAL MOTION DETECTOR 'MD' DETAIL

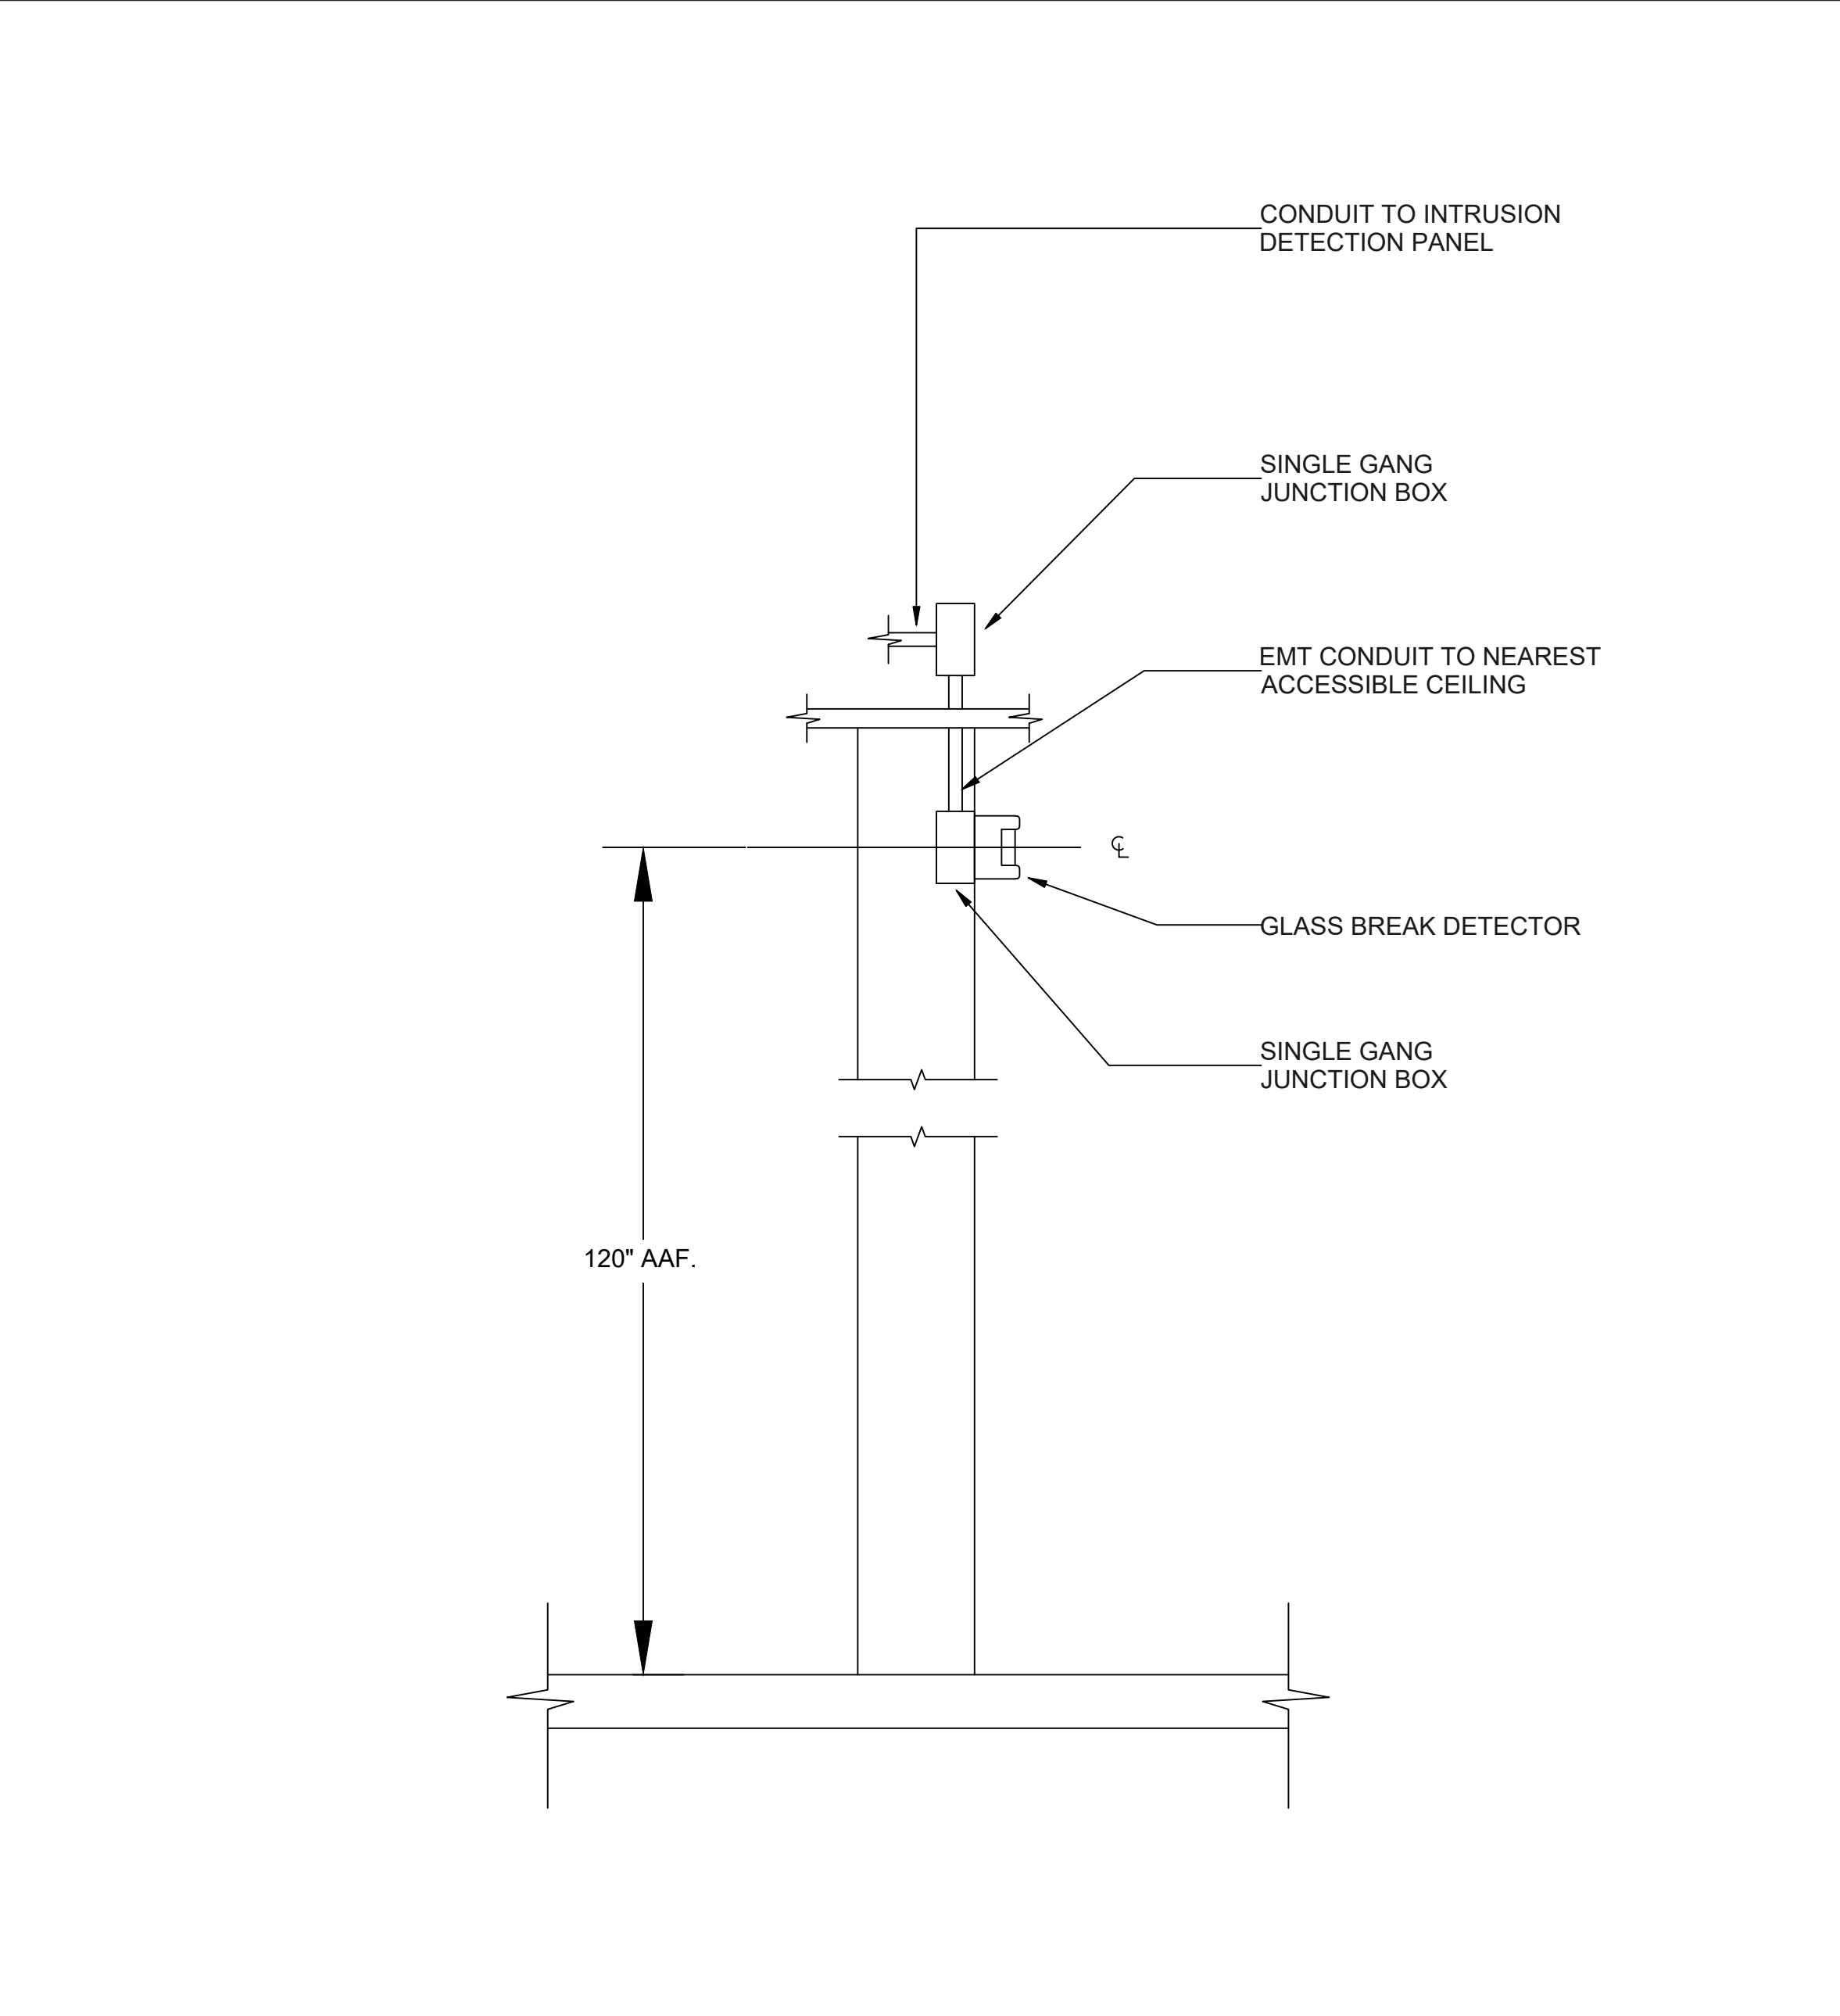SCALE: NTS 5



TYPICAL GLASS BREAK DETECTOR 'GB' DETAIL

SCALE: NTS 6

PAUL MURDOCH ARCHITECTS

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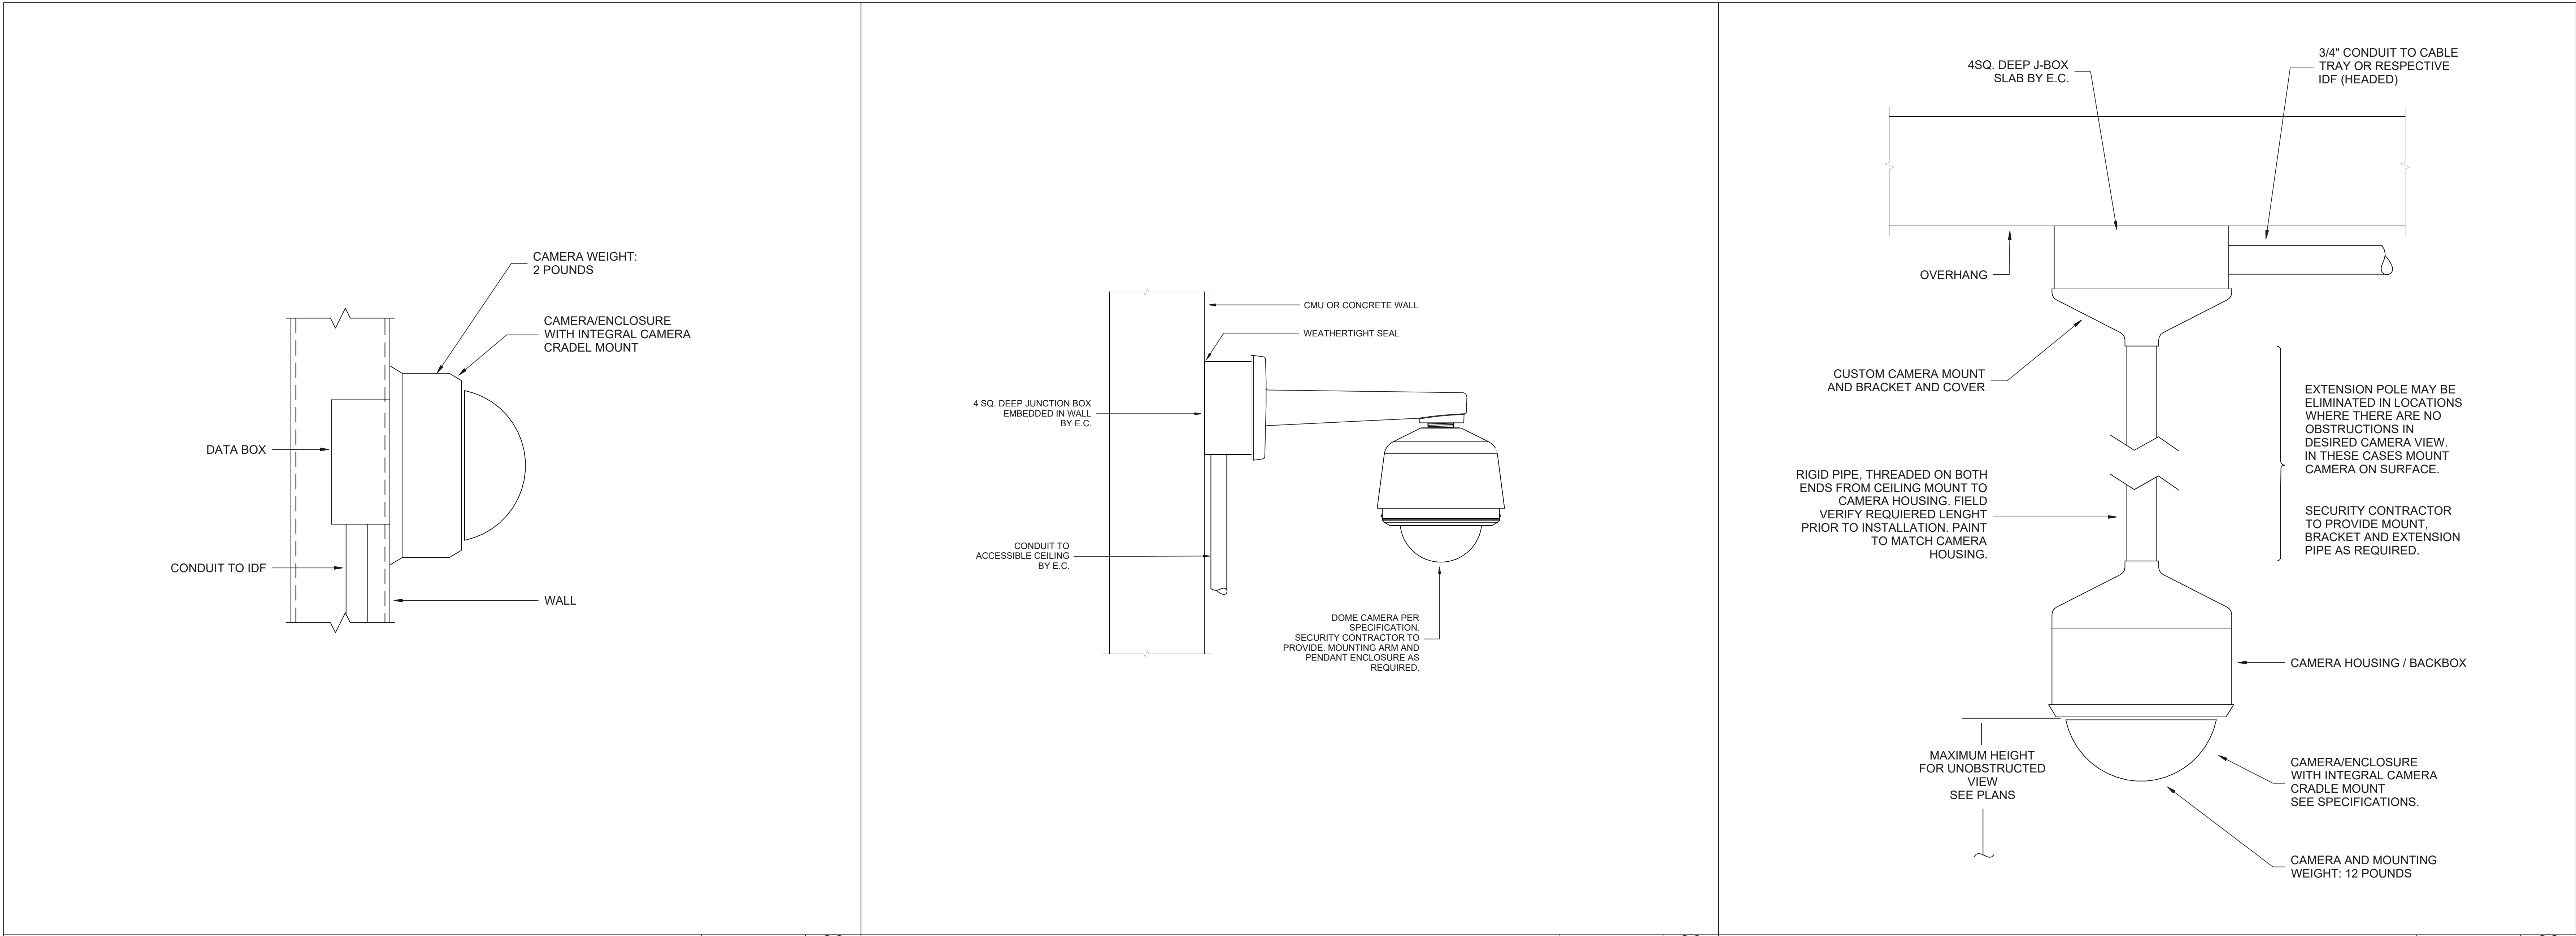
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VENEKLASEN ASSOCIATES


17711 SHERMAN STREET  
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SC601		





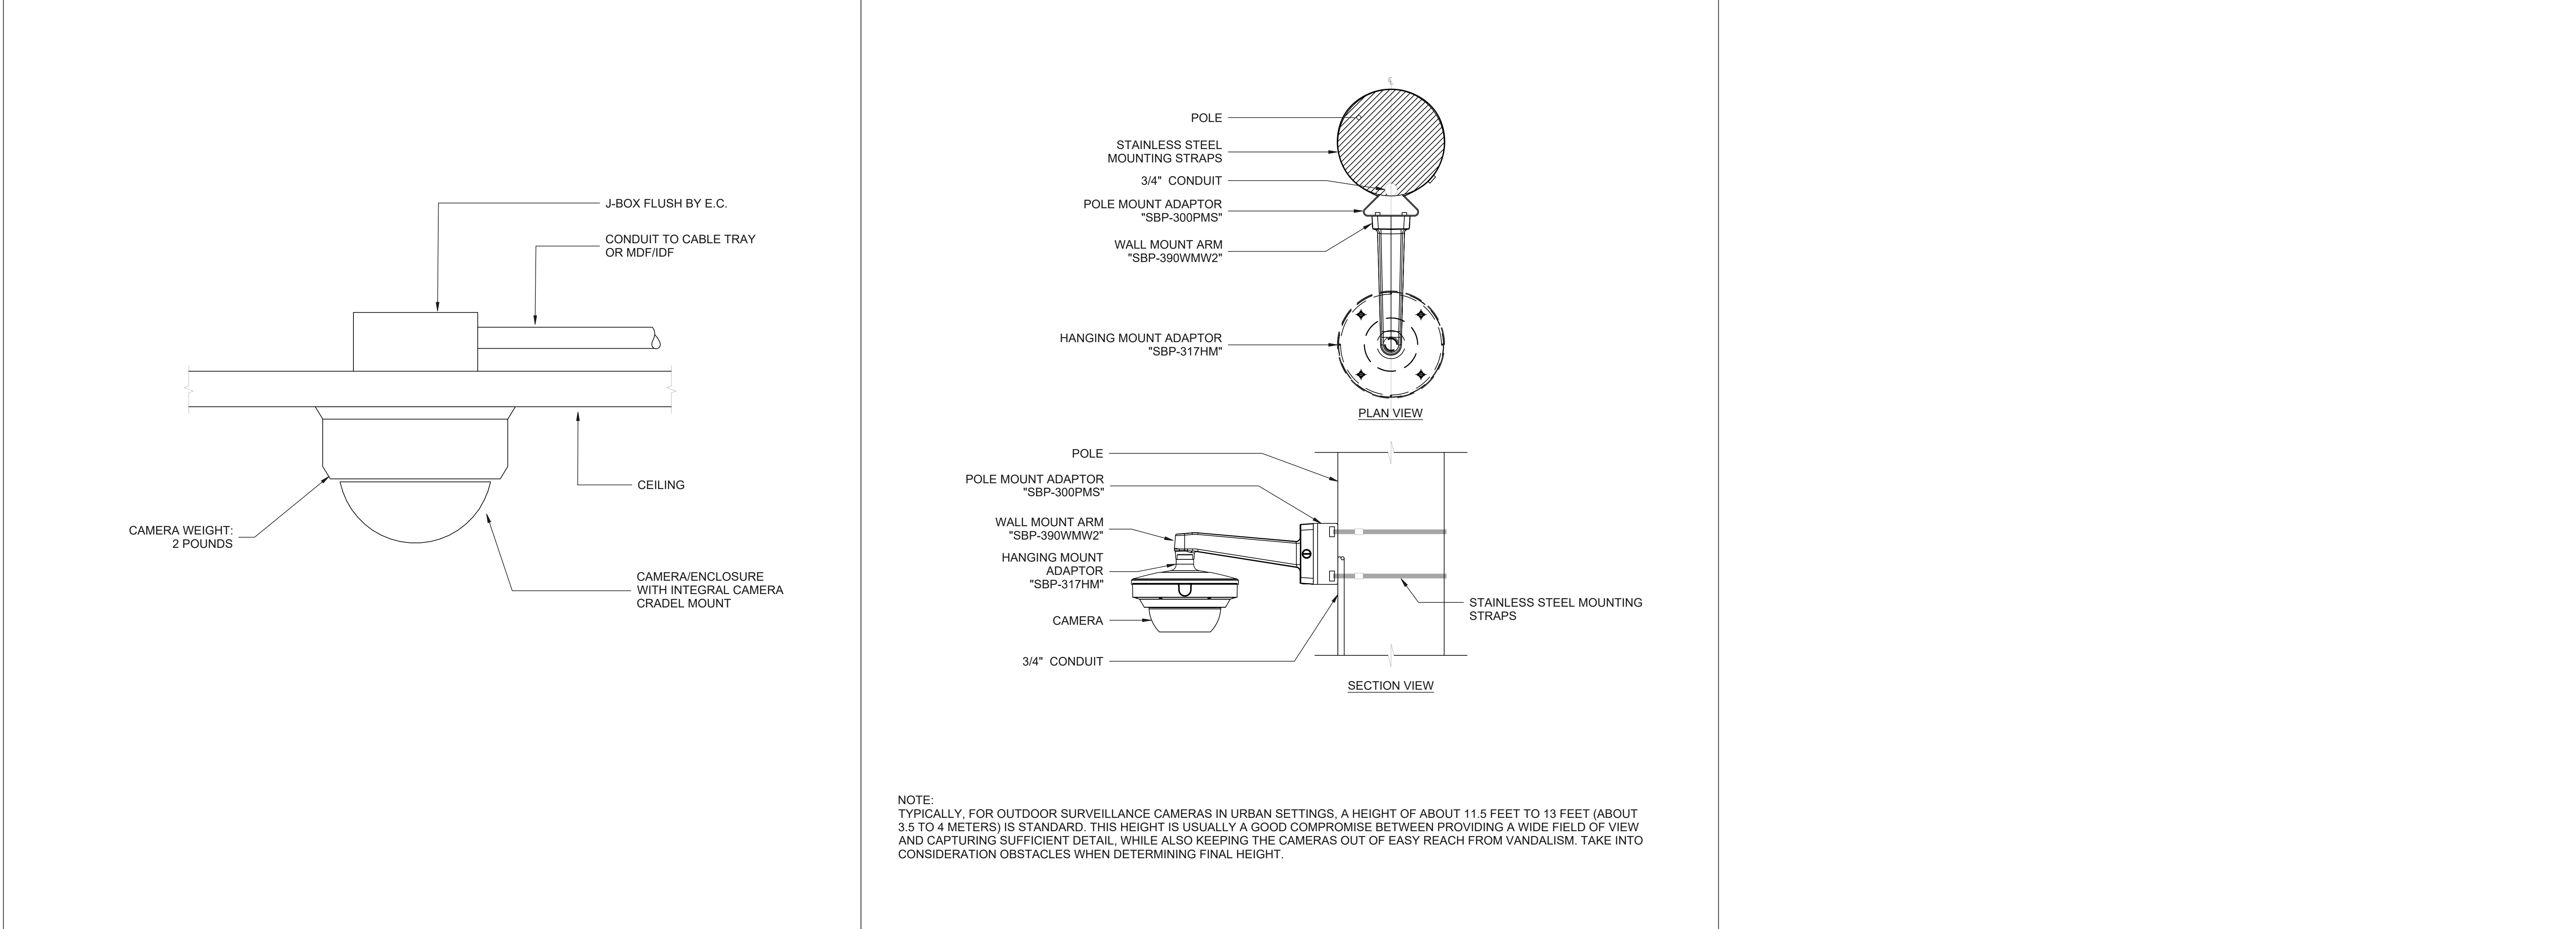FLUSH CAMERA WALL MOUNTING DETAIL	SCALE: NTS	1	PENDANT ARM EXTERIOR CAMERA DETAIL	SCALE: NTS	2	SURFACE MOUNTED CAMERA WITH POLE MOUNTING DETAIL	SCALE: NTS	3
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FLUSH CEILING CAMERA MOUNTING DETAIL	SCALE: NTS	4	TYPICAL POLE MOUNTED CAMERA DETAIL	SCALE: NTS	5
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